


Drawing Number	Drawing Title	Drawing Size
22156-MWP-00-00-DR-C-5001	Site Context Map	A1
22156-MWP-00-00-DR-C-5002	Planning Application and Landholding Boundary	AO
22156-MWP-00-00-DR-C-5003	Planning Application Boundary	A0
22156-MWP-00-00-DR-C-5004	Existing Contours	A0
22156-MWP-00-00-DR-C-5005	Site Layout - Master Sheet	AO
22156-MWP-01-00-DR-C-5005	Site Layout - Sheet 1	A1
22156-MWP-02-00-DR-C-5005	Site Layout - Sheet 2	A1
22156-MWP-03-00-DR-C-5005	Site Layout - Sheet 3	A1
22156-MWP-04-00-DR-C-5005	Site Layout - Sheet 4	A1
22156-MWP-05-00-DR-C-5005	Site Layout - Sheet 5	A1
22156-MWP-06-00-DR-C-5005	Site Layout - Sheet 6	A1
22156-MWP-07-00-DR-C-5005	Site Layout - Sheet 7	A1
22156-MWP-08-00-DR-C-5005	Site Layout - Sheet 8	A1
22156-MWP-09-00-DR-C-5005	Site Layout - Sheet 9	A1
22156-MWP-10-00-DR-C-5005	Site Layout - Sheet 10	A1
22156-MWP-11-00-DR-C-5005	Site Layout - Sheet 11	A1
22156-MWP-00-00-DR-C-5006	Drainage Layout - Master Sheet	A0
22156-MWP-01-00-DR-C-5006	Drainage Layout - Sheet 1	A1
22156-MWP-02-00-DR-C-5006	Drainage Layout - Sheet 2	A1
22156-MWP-03-00-DR-C-5006	Drainage Layout - Sheet 3	A1
22156-MWP-04-00-DR-C-5006	Drainage Layout - Sheet 4	A1
22156-MWP-05-00-DR-C-5006	Drainage Layout - Sheet 5	A1
22156-MWP-06-00-DR-C-5006	Drainage Layout - Sheet 6	A1
22156-MWP-07-00-DR-C-5006	Drainage Layout - Sheet 7	A1
22156-MWP-08-00-DR-C-5006	Drainage Layout - Sheet 8	A1
22156-MWP-09-00-DR-C-5006	Drainage Layout - Sheet 9	A1
22156-MWP-10-00-DR-C-5006	Drainage Layout - Sheet 10	A1
22156-MWP-11-00-DR-C-5006	Drainage Layout - Sheet 11	A1
22156-MWP-00-00-DR-C-5007	Site Access Layout and Sight Distances - Sheet 1	A1
22156-MWP-00-00-DR-C-5008	Site Access Layout and Sight Distances - Sheet 2	A1
22156-MWP-00-00-DR-C-5009	Turbine Delivery Route	A1
22156-MWP-00-00-DR-C-5010	Revegetation of Temporary Works Areas	A1
22156-MWP-00-00-DR-C-5401	Turbine Elevations Details	A1
22156-MWP-00-00-DR-C-5402	Turbine Foundation Details	A1
22156-MWP-00-00-DR-C-5403	Turbine Hardstand Details	A1



Drawing Number	Drawing Title	Drawing Size
	1	
22156-MWP-00-00-DR-C-5404	Met Mast Details	A1
22156-MWP-00-00-DR-C-5405	Access Track Details	A1
22156-MWP-00-00-DR-C-5406	Drainage Details	A1
22156-MWP-00-00-DR-C-5407	Cable Trench Details	A1
22156-MWP-00-00-DR-C-5408	Temporary Site Construction Compound Layout and Building Details	A1
22156-MWP-00-00-DR-C-5409	Entrance Gate Details	A3
22156-MWP-00-00-DR-C-5410	Timber Post and Rail Details	A3
22156-MWP-00-00-DR-C-5411	Borrow Pit / Material Storage Area Plan and Sections	A1
22156-MWP-00-00-DR-C-5412	Watercourse Crossing Details	A1
05923-DR-100	Overall Site Location Map	A1
05923-DR-101	Site Layout Plan	A1
05923-DR-107	End Mast Details	A2
05923-DR-108	Elevation View of Proposed Tower Locations	A1
05923-DR-110	Typical Ducting Through Regional/Local Roadways	A1
05923-DR-111	Ducting Through Forestry Track	A3
05923-DR-112	Typical Section Through Private Lands	A3
05923-DR-113	Typical 110kV Ducting Through Existing Floating Track	A1
05923-DR-115	Forestry Fire-Break Track Section	A3
05923-DR-116	Typical Communications Chamber Details	A3
05923-DR-117	Typical Earth Link Chamber Details	A3
05923-DR-118	Typical Transition Chamber Details	A3
05923-DR-119	Joint Bay Section Detail	A2
05923-DR-120	110kV Joint Bay General Arrangement and Details	A1
05923-DR-121	Typical Section Through Ducting in Flat Formation	A3
05923-DR-130	Substation Compound Layout	A1
05923-DR-131	Substation Elevations	A1
05923-DR-132	Control Building - Plan & Elevations & Section	A1
05923-DR-133	IPP Building - Plan & Elevations & Section	A1
05923-DR-134	Lightning Monopole Foundation Details 18m Masts	A3




Drawing Number	Drawing Title	Drawing Size
05923-DR-135	Gate & Fence Details	A2
05923-DR-136	Substation Compound Drainage, Retention Seperator Tank, Foul Water Holding Tank Details	A2
05923-DR-137	Telecoms Pole Elevation View	A3
05923-DR-138	Rain Water Harvesting Tank & Vent Details	A1
05923-DR-139	Cut & Fill Layout Plan	A1
05923-DR-140	Substation Site Sections	A1
05923-DR-141	Autotrack Layout Plan	A1
05923-DR-142	Substation Compound Details	A2

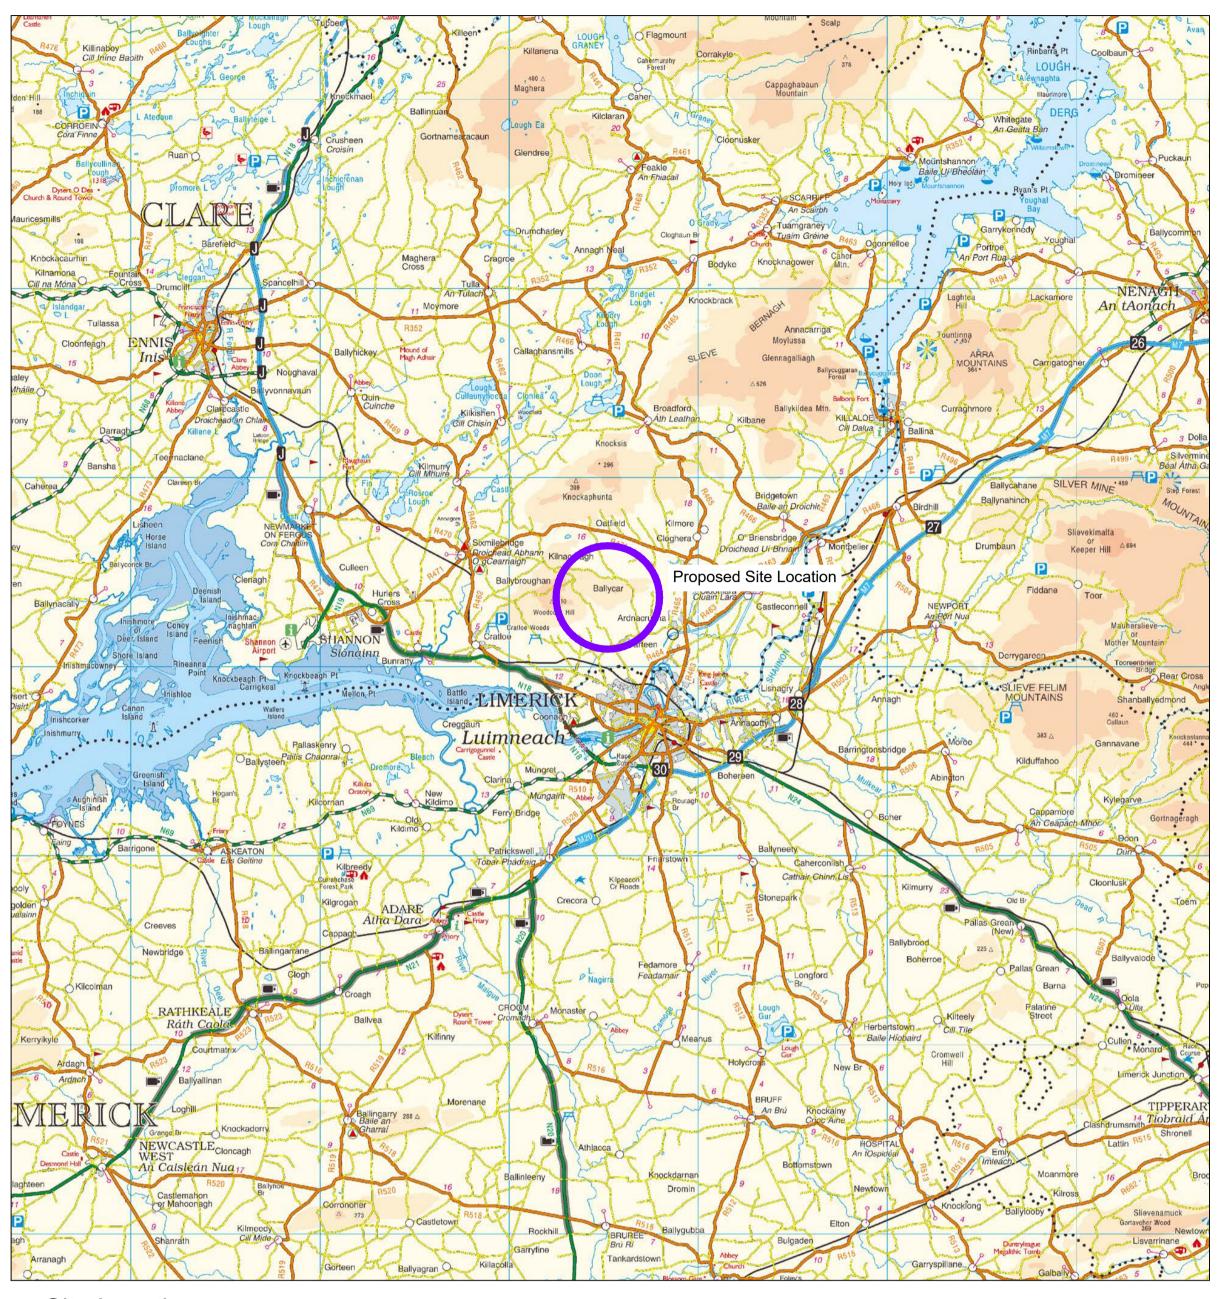


Site Location Scale 1:200,000



Site Location Map Of Ireland Not to Scale

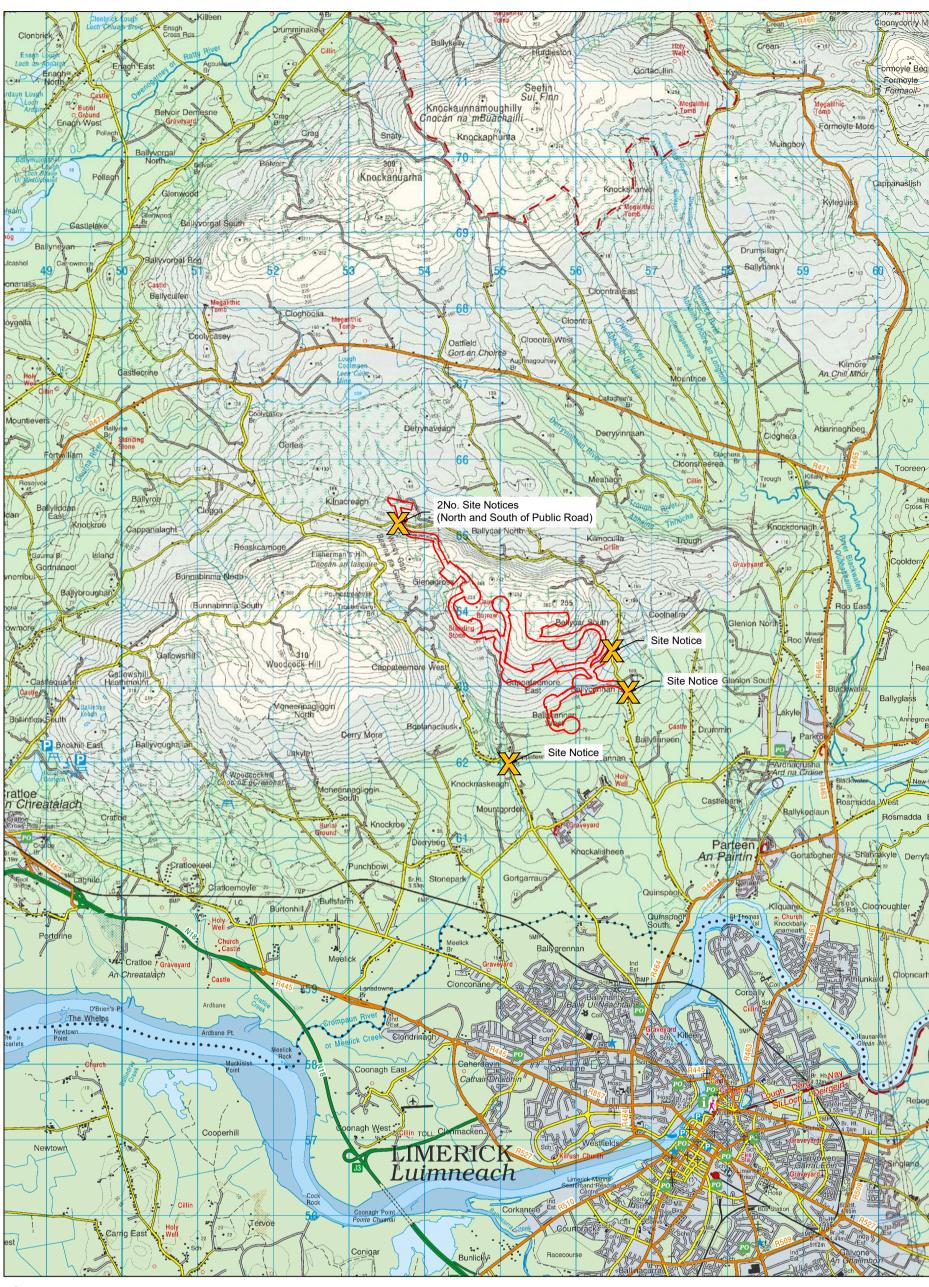


Site Location Scale 1:50,000

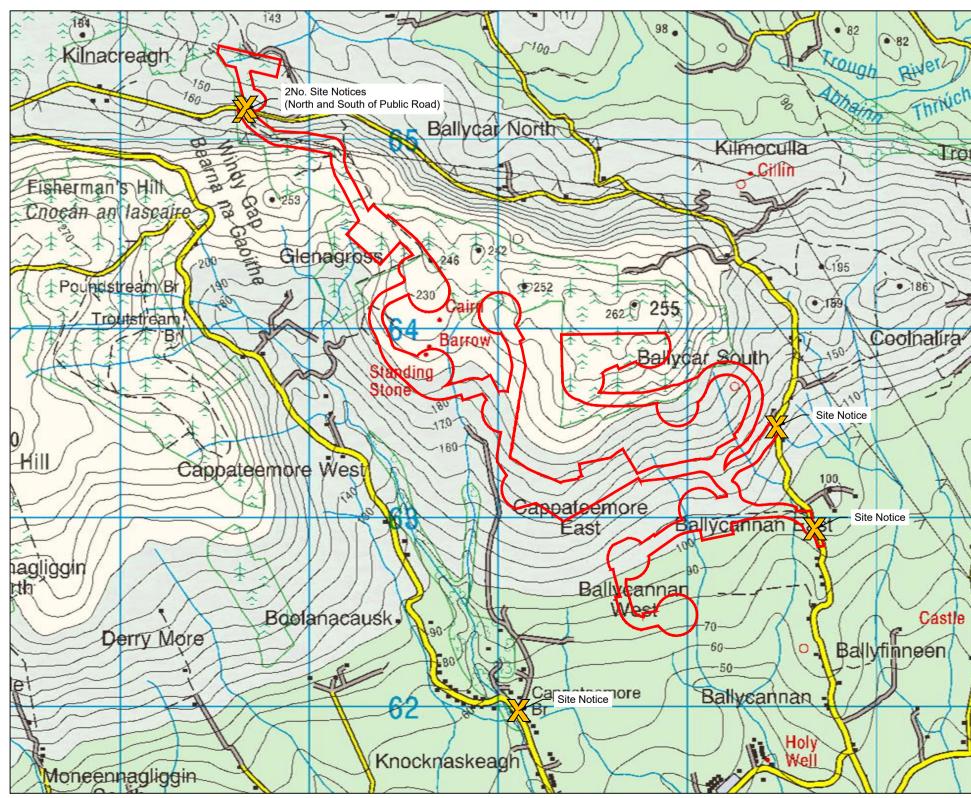

Site Location Scale 1:20,000




BO SOTSCILLE FIRST THE DESCRIPTION DESCRIPTION DESCRIPTION THIS DRAWING TO DESCRIPTION THE DESCRIPTION THIS DRAWING TO DESCRIPTION THIS DRAWING TO DESCRIPTION THIS DRAWINGS ARE TO BE FEAD IN CONJUNCTION WITH ALL DESCRIPTION THE PERFORMANCE DATUM AND THE CONTRACT SERVICES AND ENGINEERING DRAWINGS ANCHITECTURAL, SERVICES AND ENGINEERING DRAWINGS ANCHITECTURAL, SERVICES AND ENGINEERING DRAWINGS ANCHITECTURAL, SERVICES AND ENGINEERING DRAWINGS ANCHITECTURAL, SERVICES AND ENGINEERING BROUGHT TO THE ATTENTION OF THE ENGINEERING AND DISCREPANCIES BETWEEN THESE DOCUMENTS SHALL BI BROUGHT TO THE ATTENTION OF THE ENGINEERING AND DISCREPANCIES BETWEEN THESE DOCUMENTS SHALL BI BROUGHT TO THE ATTENTION OF THE ENGINEERING AND DISCREPANCIES BETWEEN THESE DOCUMENTS SHALL BI BROUGHT TO THE ATTENTION OF THE ENGINEERING INTERVISE. LEGEND: Planning Application Boundary Site Notice Planning Application Boundary Site Notice Planning Application Boundary THE Ballycar Wind Farm THE Site Context Map CLEM: PLANNER DISCOVERY TILE NOT HALL ALL AND ENGINEERING AND DISCOVERY THE NOT HALL AND THE ALL AND THE ALL AND DISCREPANCIES AND
THE BRAVING TO BE READ IN CONJUNCTION WITH THE DESIGNERS I THIS DRAWING TO BE READ IN CONJUNCTION WITH THE DESIGNERS PERMISSION NOTES: ALL DRAWINGS ARE TO BE READ IN CONJUNCTION WITH ALL RELEVANT SPECIFICATIONS, BILLS OF QUANTITIES, ARCHTECTURAL, SERVICES AND ENGINEERING DRAWINGS. ALL LEVELS ARE IN METRES RELATED TO ORDINANCE DATUM MALIN HEAD. AND INCREPANCIES BETWEEN THESE DOLUMENTS SHALL BI BROUGHT TO THE ATTENTION OF THE RENINEER. DRAWINGS ARE NOT TO BE SCALED. ALL DIMENSIONS ARE IN MILLIMETRES, UNLESS NOTED OTHERWISE. LEGEND: Map Reproduced From Ordinance Survey Ireland BY OFTIME CONTINUES. Map Reproduced From Ordinance Survey Ireland BY OFTIME SOLUTION OF THE ENSINEER. DRAWINGS ARE NOT TO BE SCALED. ALL DIMENSIONS ARE IN MILLIMETRES, UNLESS NOTED OTHERWISE. LEGEND: CISIDISCOVERY THE NOT THE OFTIME ADDING DISCOVERY THE NOT THE CONTINUES. CISIDISCOVERY THE NOT HAR THE SITE STREED OFTIME FOLORIZED INCLUDENT OF THE CONTINUES. CISIDISCOVERY THE NOT HAR THE SITE STREED OFTIME THE SITE CONTEXT MAP CLENT
NOTES: NOTES: NOTES: DESIGNERS PERMISSION NOTES: ACCHTECATIONS, ARE TO BE READ IN CONJUNCTION WITH ALL RELEVANT SPECIFICATIONS, BILLS OF QUANTITIES, ARCHTECTURAL, SERVICES AND ENGINEERING DRAWINGS. ALL LEVELS ARE IN METRES RELATED TO ORDNANCE DATUM MAUN HEAD. ANY DISCREPANCIES BETWEEN THESE DOCUMENTS SHALL BI BROUGHT TO THE ATENTION OF THE RENINEER. DRAWINGS ARE NOT TO BE SCALED. ALL DIRENSIONS ARE IN MULLIMETRES, UNLESS NOTED OTHERWISE. LEGEND: Map Reproduced From Ordnance Survey Ireland By Demission Of The Covernment. COST DISCOVERY TILE NO. 1414, 1416, 1614 & 1616 POI 0612.22 Ballycar Wind Farm TITLE Site Context Map CLIENT
RELEVANT SPECIFICATIONS, BILLS OF QUANTITIES, ARCHITECTURAL, SERVICES AND ENGINEERING DRAWINGS. 2. ALL LEVELS ARE IN METRES RELATED TO ORDNANCE DATUM MALIN HEAD. 3. ANY DISCREPANCIES BETWEEN THESS DOCUMENTS SHALL BI BROUGHT TO THE ATTENTION OF THE ENGINEER. 4. DRAWINGS ARE NOT TO BE SCALED. 5. ALL DIMENSIONS ARE IN MILLIMETRES, UNLESS NOTED OTHERWISE. LEGEND: Planning Application Boundary XX Site Notice
 ALL LEVELS ARE IN METRES RELATED TO ORDNANCE DATUM MALIN HEAD. ANY DISCREPANCIES BETWEEN THESE DOCUMENTS SHALL BI BROUGHTO THE ATTENTION OF THE ENGINEER. DRAWINGS ARE NOT TO BE SCALED. ALL DIMENSIONS ARE IN MILLIMETRES, UNLESS NOTED OTHERWISE. LEGEND: Wap Reproduced From Ordnance Survey Ireland By Permission Of The Government. CVAL6032108. OSI DISCOVERY TILE NO: 1414, 1416, 1614 & 1616 DSI DISCOVERY TILE NO: 1414, 1416, 1614 & REGENTION DSI DISCOVERY TILE NO: 1414, 1416, 1614 & REGENTION Ballycar Wind Farm TILE: Site Context Map CLENT:
MALIN HEAD. MALIN HEAD. MALIN HEAD. MALIN HEAD. MAN DISCREPANCIES BETWEEN THESE DOCUMENTS SHALL BI BROUGHT TO THE ATTENTION OF THE ENGINEER. D DRAWINGS ARE NO TO BE SCALED. ADD MAN SARE NO TO BE SCALED. ADD MAN SARE NO MILLIMETRES, UNLESS NOTED Planning Application Boundary Site Notice Map Reproduced From Ordnance Survey Ireland By Permission Of The Government. CVALE032118. Map Reproduced For Planning MAL NERVENTIAL SARE NO. SID DISCOVERY TILE NO. 1114, 1116, 1614 & Poil MATE Ballycar Wind Farm TILE: Site Context Map CUENT:
 ANY DISCREPANCIES BETWEEN THESE DOCUMENTS SHALL BI BROUGHT TO THE ATTENTION OF THE ENGINEER. DRAWINGS ARE NOT TO BE SCALED. ALL DIMENSIONS ARE IN MILLIMETRES, UNLESS NOTED IEGEND: Planning Application Boundary Site Notice Map Reproduced From Orthance Survey Ireland By Permission Of The Government. CYALS032108. OBI DISCOVERY TILE NO: Hard Street Internet OBI DISCOVERY TILE NO: Hard Street Ballycar Wind Farm TILE: Site Context Map OLIENT:
BROUGHT TO THE ATTENTION OF THE ENGINEER. 4. DRAWINGS ARE NOT TO BE SCALED. 5. ALL DIMENSIONS ARE IN MILLIMETRES, UNLESS NOTED EGGEND: Planning Application Boundary Site Notice Map Reproduced From Ordnance Survey Ireland By Permission Of The Government. By Permission Of The Government. CVAL60321198. OSI DISCOVERY TILE NO: 1414, 1416, 1614 & POL 04 12.23 Ballycar Wind Farm THE Site Context Map CLEM:
S. ALL DIMENSIONS ARE IN MILLIMETRES, UNLESS NOTED OTHERWISE. LEGEND: Planning Application Boundary Site Notice Site Notice Maps Reproduced From Ordnance Survey Ireland By Permission Of The Government. Ost Discovery Title Not: 1414, 1416, 1614 & 1616 P01 081 DISI DISCOVERY TILE Ballycar Wind Farm Title: Site Context Map
OTHERWISE. LEGEND: Planning Application Boundary Site Notice Map Reproduced From Ordnance Survey Ireland By Permission Of The Government. Other Survey Ireland By Permission Of The Government. OSI DISCOVERY TILE NO: 1414, 1416, 1614 & 1618 OSI DISCOVERY TILE NO: 1414, 1416, 1614 & 1618 POI 06 1223 Issued For Planning JK P POI 06 1223 Issued For Planning
LEGEND: Image: Construction of the second
Planning Application Boundary X Site Notice Map Reproduced From Ordnance Survey Ireland By Permission Of The Government. CVA503321/B OSI DISCOVERY TILE NO: 1414, 1416, 1614 & 1816 P01 06:12.23 Issued For Planning JK REV DESCRIPTION BY AR Ballycar Wind Farm TITLE: Site Context Map
Site Notice Site Notice Image: Site Notice Image: Site Notice Map Reproduced From Ordnance Survey Ireland By Permission Of The Government: CX4L50332198. OSI DISCOVERY TILE NO: 1414, 1416, 1614 & 1616 P01 06 12 23 Issued For Planning DISCOVERY TILE NO: 1414, 1416, 1614 & 1616 P01 06 12 23 Issued For Planning Ballycar Wind Farm TILE: Site Context Map CLEMT:
Map Reproduced From Ordnance Survey Ireland By Permission Of The Government. CYAL50332198. OSI DISCOVERY TILE NO: 1414, 1416, 1614 & 1616 Rev DATE DESCRIPTION BY A Ballycar Wind Farm
By Permission Of The Government. CYAL50332198. OSI DISCOVERY TILE NO: 1414, 1416, 1614 & 1616 1616 P01 08.12.23 Issued For Planning JK REV DATE DATE DESCRIPTION Ballycar Wind Farm TITLE: Site Context Map CLIENT:
By Permission Of The Government. CYAL50332198. OSI DISCOVERY TILE NO: 1414, 1416, 1614 & 1616 1616 P01 08.12.23 Issued For Planning JK REV DATE DATE DESCRIPTION Ballycar Wind Farm TITLE: Site Context Map CLIENT:
By Permission Of The Government. CYAL50332198. OSI DISCOVERY TILE NO: 1414, 1416, 1614 & 1616 P01 08.12.23 Issued For Planning JK REV DATE DESCRIPTION BY AF PROJECT: Ballycar Wind Farm TITLE: Site Context Map CLIENT:
By Permission Of The Government. CYAL50332198. OSI DISCOVERY TILE NO: 1414, 1416, 1614 & 1616 1616 P01 08.12.23 Issued For Planning JK REV DATE DATE DESCRIPTION Ballycar Wind Farm TITLE: Site Context Map CLIENT:
By Permission Of The Government. CYAL50332198. OSI DISCOVERY TILE NO: 1414, 1416, 1614 & 1616 1616 P01 08.12.23 Issued For Planning JK REV DATE DATE DESCRIPTION Ballycar Wind Farm TITLE: Site Context Map CLIENT:
By Permission Of The Government. CYAL50332198. OSI DISCOVERY TILE NO: 1414, 1416, 1614 & 1616 P01 08.12.23 Issued For Planning JK REV DATE DESCRIPTION BY AF PROJECT: Ballycar Wind Farm TITLE: Site Context Map CLIENT:
By Permission Of The Government. CYAL50332198. OSI DISCOVERY TILE NO: 1414, 1416, 1614 & 1616 P01 08.12.23 Issued For Planning JK REV DATE DESCRIPTION BY AF PROJECT: Ballycar Wind Farm TITLE: Site Context Map CLIENT:
By Permission Of The Government. CYAL50332198. OSI DISCOVERY TILE NO: 1414, 1416, 1614 & 1616 1616 P01 08.12.23 Issued For Planning JK REV DATE DATE DESCRIPTION Ballycar Wind Farm TITLE: Site Context Map CLIENT:
By Permission Of The Government. CYAL50332198. OSI DISCOVERY TILE NO: 1414, 1416, 1614 & 1616 1616 P01 08.12.23 Issued For Planning JK REV DATE DATE DESCRIPTION Ballycar Wind Farm TITLE: Site Context Map CLIENT:
By Permission Of The Government. CYAL50332198. OSI DISCOVERY TILE NO: 1414, 1416, 1614 & 1616 1616 P01 08.12.23 Issued For Planning JK REV DATE DATE DESCRIPTION Ballycar Wind Farm TITLE: Site Context Map CLIENT:
By Permission Of The Government. CYAL50332198. OSI DISCOVERY TILE NO: 1414, 1416, 1614 & 1616 1616 P01 08.12.23 Issued For Planning JK REV DATE DATE DESCRIPTION Ballycar Wind Farm TITLE: Site Context Map CLIENT:
By Permission Of The Government. CYAL50332198. OSI DISCOVERY TILE NO: 1414, 1416, 1614 & 1616 P01 08.12.23 Issued For Planning JK REV DATE DESCRIPTION BY AF PROJECT: Ballycar Wind Farm TITLE: Site Context Map CLIENT:
By Permission Of The Government. CYAL50332198. OSI DISCOVERY TILE NO: 1414, 1416, 1614 & 1616 P01 08.12.23 Issued For Planning JK REV DATE DESCRIPTION BY AF PROJECT: Ballycar Wind Farm TITLE: Site Context Map CLIENT:
By Permission Of The Government. CYAL50332198. OSI DISCOVERY TILE NO: 1414, 1416, 1614 & 1616 P01 08.12.23 Issued For Planning JK REV DATE DESCRIPTION BY AF PROJECT: Ballycar Wind Farm TITLE: Site Context Map CLIENT:
By Permission Of The Government. CYAL50332198. OSI DISCOVERY TILE NO: 1414, 1416, 1614 & 1616 1616 P01 08.12.23 Issued For Planning JK REV DATE DESCRIPTION BY AF PROJECT: Ballycar Wind Farm TITLE: Site Context Map CLIENT:
By Permission Of The Government. CYAL50332198. OSI DISCOVERY TILE NO: 1414, 1416, 1614 & 1616 1616 P01 08.12.23 Issued For Planning JK REV DATE DESCRIPTION BY AF PROJECT: Ballycar Wind Farm TITLE: Site Context Map CLIENT:
By Permission Of The Government. CYAL50332198. OSI DISCOVERY TILE NO: 1414, 1416, 1614 & 1616 1616 P01 08.12.23 Issued For Planning JK PRU DATE DESCRIPTION BY AF PROJECT: Ballycar Wind Farm TITLE: Site Context Map CLIENT:
By Permission Of The Government. CYAL50332198. OSI DISCOVERY TILE NO: 1414, 1416, 1614 & 1616 1616 PO1 08.12.23 Issued For Planning JK REV DATE DESCRIPTION BY AF PROJECT: TITLE: Site Context Map CLIENT:
By Permission Of The Government. CYAL50332198. OSI DISCOVERY TILE NO: 1414, 1416, 1614 & 1616 1616 P01 08.12.23 Issued For Planning JK PRU DATE DESCRIPTION BY AF PROJECT: Ballycar Wind Farm TITLE: Site Context Map CLIENT:
By Permission Of The Government. CYAL50332198. OSI DISCOVERY TILE NO: 1414, 1416, 1614 & 1616 1616 P01 08.12.23 Issued For Planning JK PRU DATE DESCRIPTION BY AF PROJECT: Ballycar Wind Farm TITLE: Site Context Map CLIENT:
By Permission Of The Government. CYAL50332198. OSI DISCOVERY TILE NO: 1414, 1416, 1614 & 1616 1616 P01 08.12.23 Issued For Planning JK REV DATE DESCRIPTION BY AF PROJECT: Ballycar Wind Farm TITLE: Site Context Map CLIENT:
CYAL50332198. OSI DISCOVERY TILE NO: 1414, 1416, 1614 & 1616 1616 PO1 08.12.23 Issued For Planning JK P REV DATE DESCRIPTION BY AF PROJECT: TITLE: Site Context Map CLIENT:
1616 P01 08.12.23 Issued For Planning JK P REV DATE DESCRIPTION BY AF PROJECT: Ballycar Wind Farm TITLE: Site Context Map CLIENT:
REV DATE DESCRIPTION BY AF PROJECT: Ballycar Wind Farm TITLE: Site Context Map CLIENT:
REV DATE DESCRIPTION BY AF PROJECT: Ballycar Wind Farm TITLE: Site Context Map
REV DATE DESCRIPTION BY AF PROJECT: Ballycar Wind Farm TITLE: Site Context Map
REV DATE DESCRIPTION BY AF PROJECT: Ballycar Wind Farm TITLE: Site Context Map CLIENT:
Ballycar Wind Farm
TITLE: Site Context Map
CLIENT: BALLYCAR
BALLYCAR
BALLYCAR
Design of the second
ENGINEERING AND ENVIRONMENTAL CONSULTANTS
CORK TRALEE LONDON LIMERICK
mwp.ie DRAWN: CHECKED: APPROVED:
JK PC OH
PROJECT NUMBER: DATE: SCALE @ A1:
22156 December 2023 As Shown STATUS DESCRIPTION STATUS:
FOR INFORMATION S2
FOR INFORMATION S2 DRAWING NUMBER: REV: 2215 - MWP - 00 - 00 - DR - C - 5001 P01

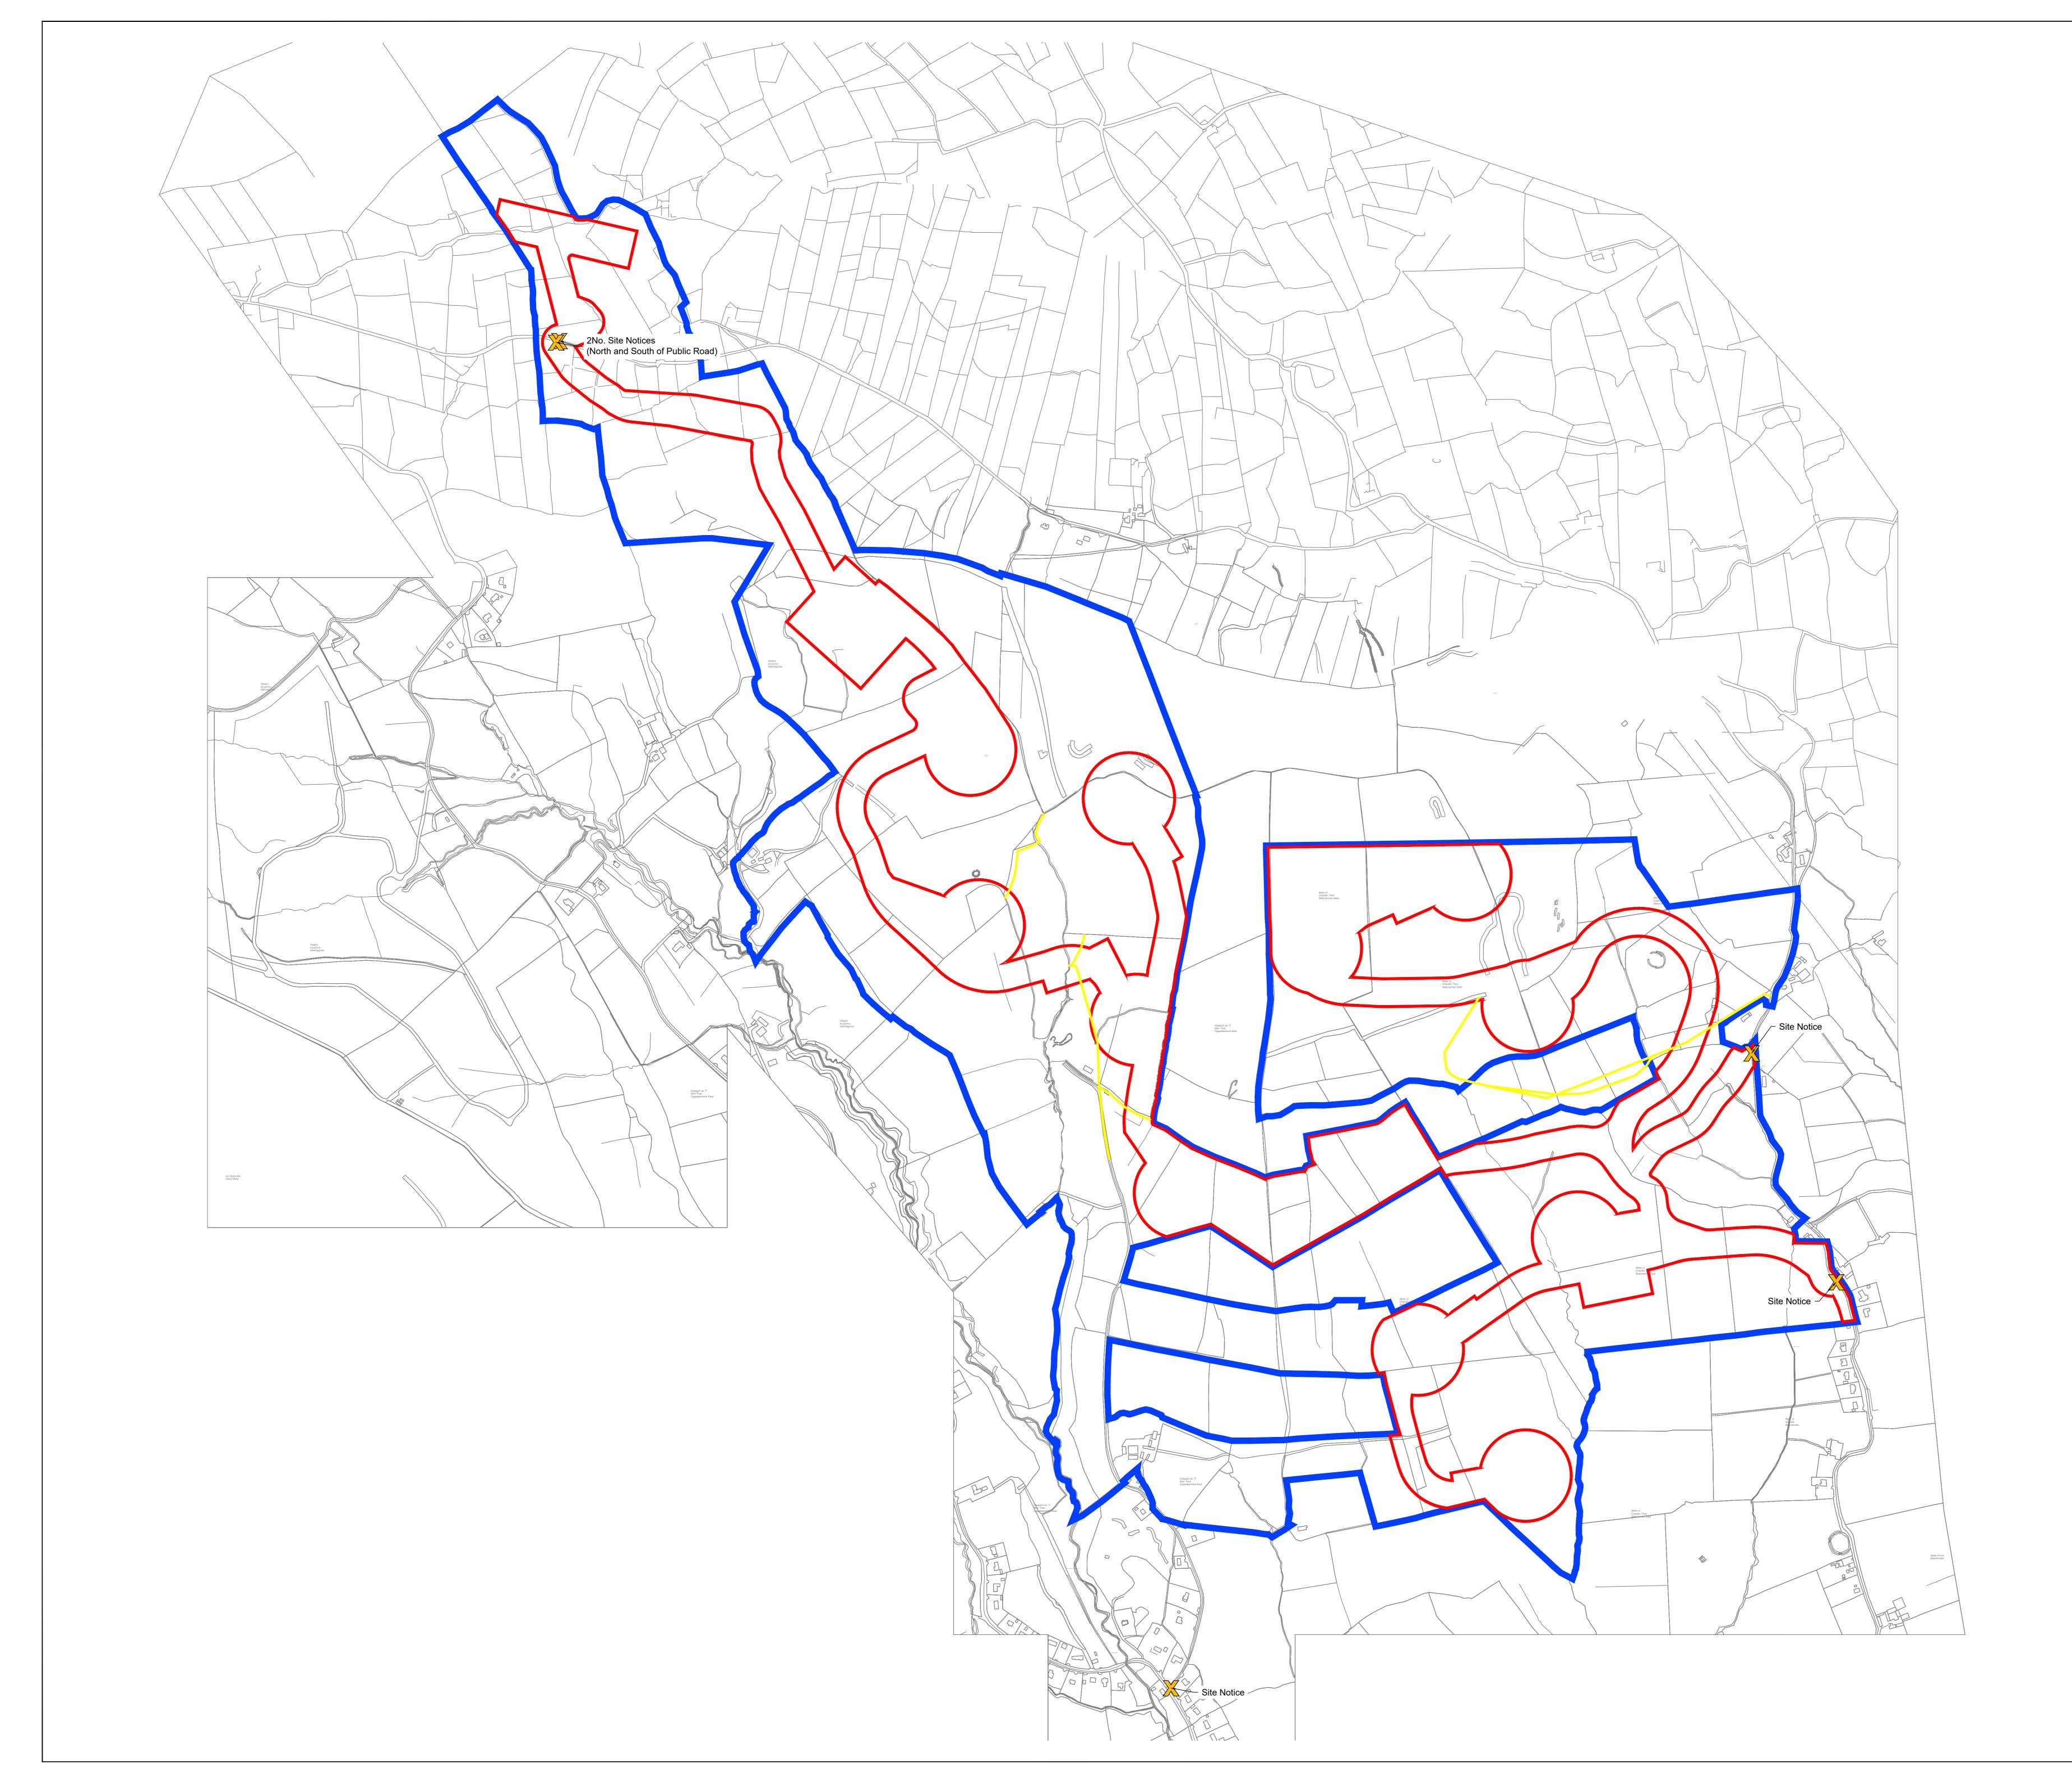


DO NOT SCALE FROM THIS DRAWING. USE FIGURED DIMENSIONS IN ALL CASES. VERIFY DIMENSIONS ON SITE AND REPORT ANY DISCREPANCIES TO THE DESIGNERS IMMEDIATELY. THIS DRAWING TO BE READ IN CONJUNCTION WITH THE DESIGNERS SPECIFICATION. © THIS DRAWING IS COPYRIGHT AND MAY ONLY BE REPRODUCED WITH THE DESIGNERS PERMISSION. NOTES: 1. ALL DRAWINGS ARE TO BE READ IN CONJUNCTION WITH ALL RELEVANT SPECIFICATIONS, BILLS OF QUANTITIES, ARCHITECTURAL, SERVICES AND ENGINEERING DRAWINGS. 2. ALL LEVELS ARE IN METRES RELATED TO ORDNANCE DATUM MALIN HEAD. 3. ANY DISCREPANCIES BETWEEN THESE DOCUMENTS SHALL BE BROUGHT TO THE ATTENTION OF THE ENGINEER. 4. DRAWINGS ARE NOT TO BE SCALED. ALL DIMENSIONS ARE IN MILLIMETRES, UNLESS NOTED OTHERWISE. LEGEND: Landholding Boundary Planning Application Boundary Wayleave \mathbf{X} Site Notice Map Reproduced From Ordnance Survey Ireland By Permission Of The Government. CYAL50332198 OSI SHEET NO: 4622-A, 4622-C, 4622-B, 4563-C, 4562-D, 4621-B, 4562-C, 4562-A & 4562
 P01
 08.12.23
 Issued For Planning
 JK
 PC

 REV
 DATE
 DESCRIPTION
 BY
 APP
 Ballycar Wind Farm Planning Application and Landholding Boundary ENGINEERING AND ENVIRONMENTAL CONSULTANTS CORK TRALEE LONDON LIMERICK mwp.ie APPROVED: CHECKED PC OH JK PROJECT NUMBER: SCALE @ A0: 1 : 5,000 22156 December 2023 STATUS DESCRIPTION STATUS: S2 FOR INFORMATION DRAWING NUMBER: 22156 - MWP - 00 - 00 - DR - C - 5002 P01

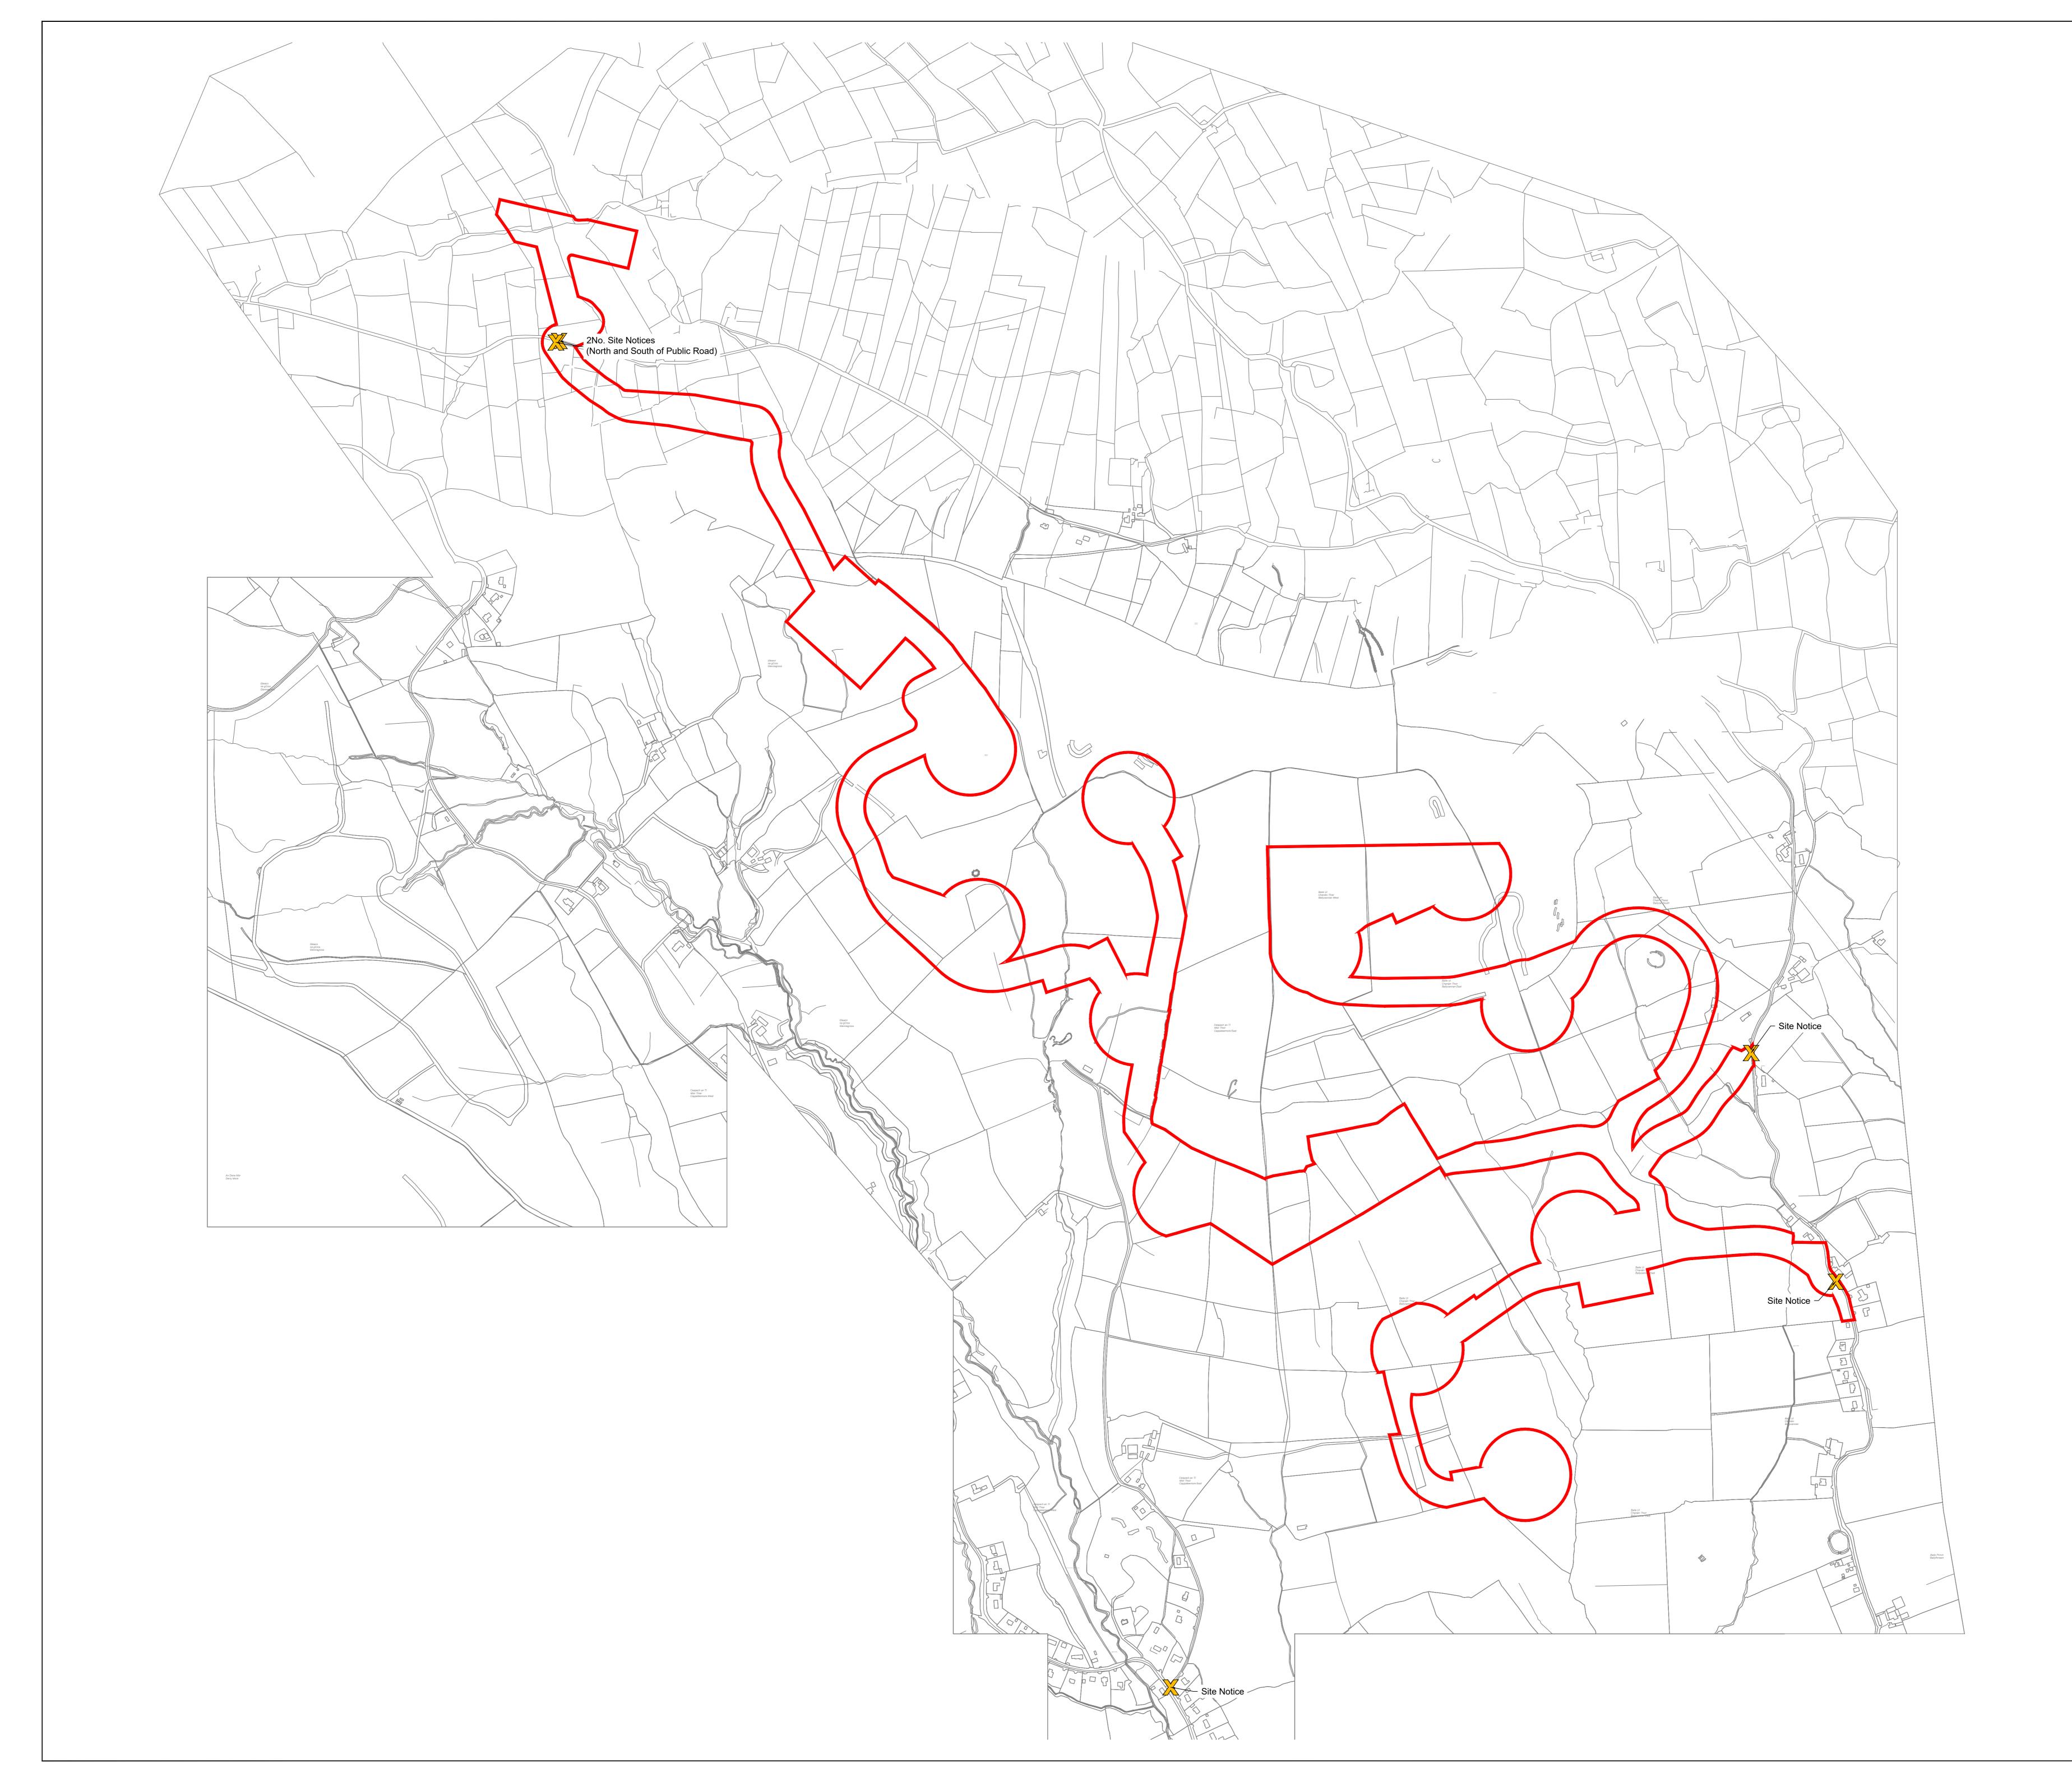


VERIFY DIM THIS DRA	IENSIONS O AWING TO BI	N SITE AND DESIGNER E READ IN C SPEC	REPORT S IMMEDIA CONJUNC IFICATION D MAY ON	ANY DIS ATELY. TION WIT I. ILY BE R	CREPAN	NS IN ALL CASES NCIES TO THE DESIGNERS JCED WITH THE
ARCHIT	NT SPECIF ECTURAL, 'ELS ARE II	SERVICES	s, Bills (S and Ei	OF QUA NGINEE	NTITIE RING D	
3. ANY DIS	CREPANC	ATTENTI	ON OF TH	HE ENG		NTS SHALL BE
5. ALL DIM OTHERV LEGEND:		ARE IN MII	LLIMETR	es, uni	LESS N	OTED
>	<	Plannin Site No	ng Applica	ition Bo	undary	
		v				
Г	Map Repro					nd
	OSI SHEET		.50332198 A, 4622-0	8. C, 4622-	B, 4563	-C,
P01 08.12.23 REV DATE PROJECT:			For Plani	ning		JK PC BY APP
Ballycar Wind Farm						
CLIENT:	BALLYCAR Green Energy					
ENG	GINEERING	AND ENVI				D TANTS
DRAWN:		TRALEE CHECKED:	-	NDON		MERICK mwp.ie
PROJECT NUMBE 2215 STATUS DESCRIP	6 TION	DATE: Decer	nber 20 MATIC	23	SCALE @ /	a0: : 5,000 status: S2
DRAWING NUMBE)3	REV: P01

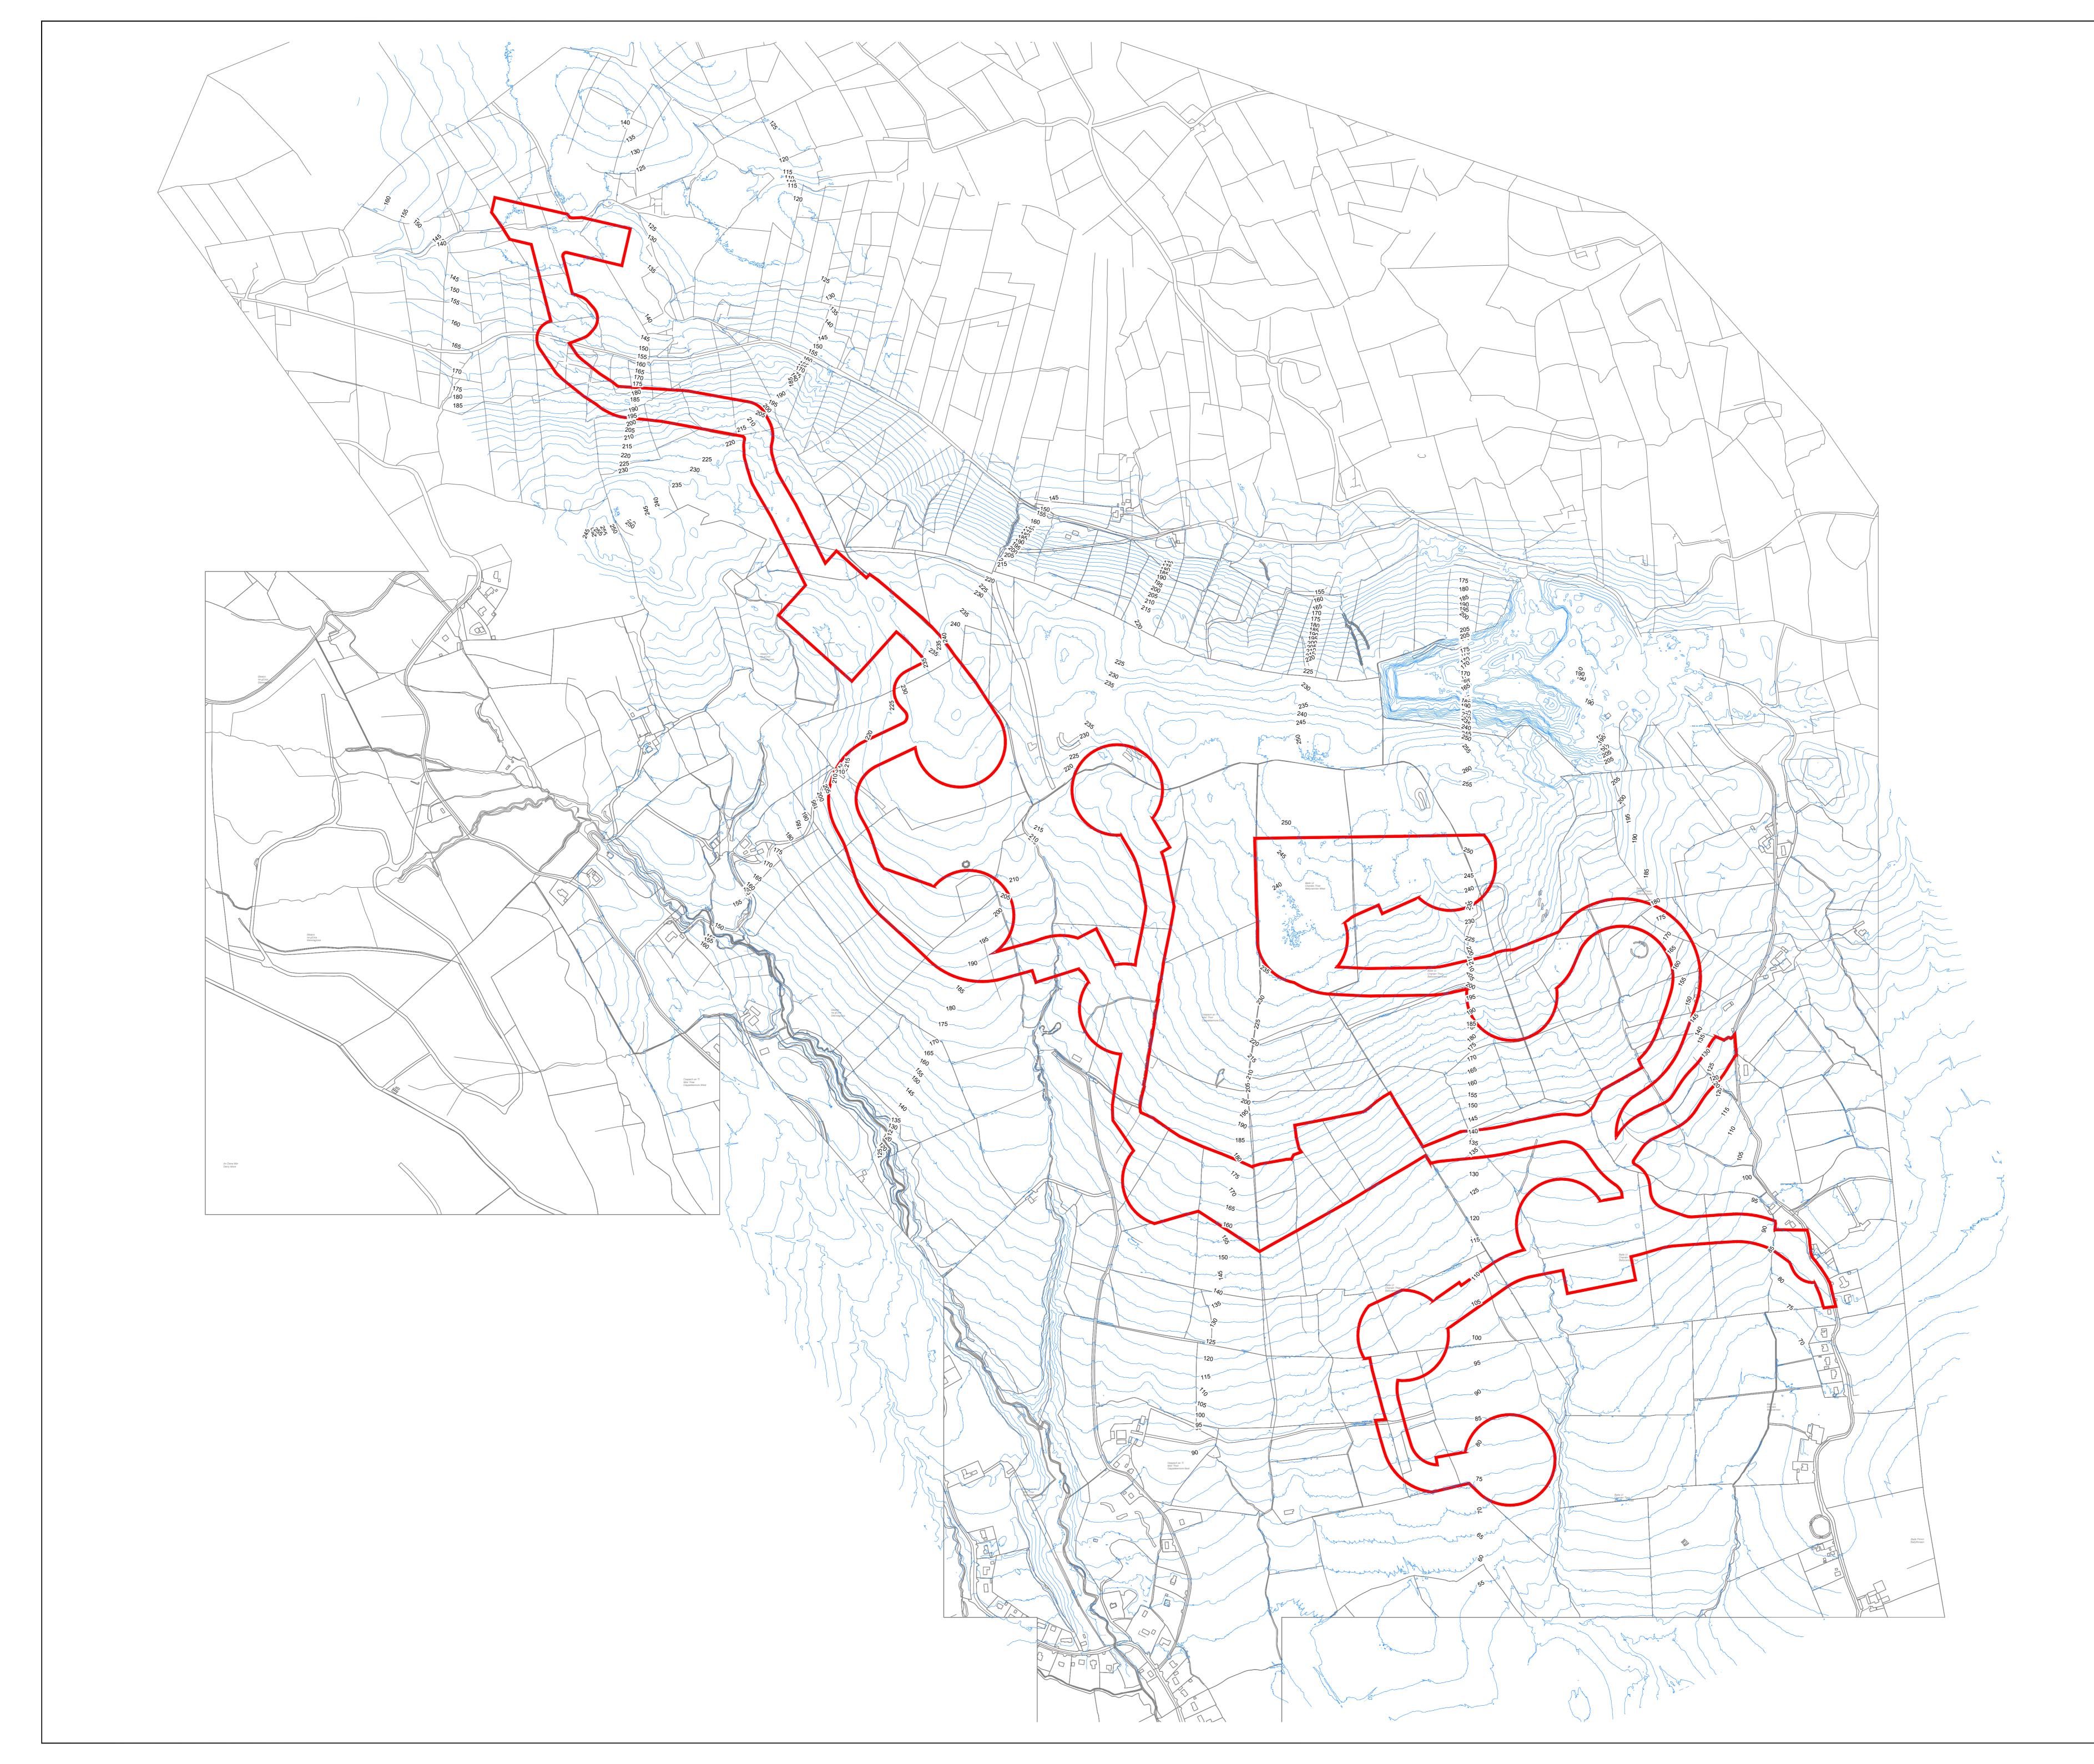


DO NOT SCALE FROM THIS DRAWING. USE FIGURED DIMENSION VERIFY DIMENSIONS ON SITE AND REPORT ANY DISCREPA DESIGNERS IMMEDIATELY. THIS DRAWING TO BE READ IN CONJUNCTION WITH THE SPECIFICATION. © THIS DRAWING IS COPYRIGHT AND MAY ONLY BE REPROD	NCIES TO THE DESIGNERS
DESIGNERS PERMISSION. NOTES: 1. ALL DRAWINGS ARE TO BE READ IN CONJUNCTIC RELEVANT SPECIFICATIONS, BILLS OF QUANTITIE	
ARCHITECTURAL, SERVICES AND ENGINEERING I2. ALL LEVELS ARE IN METRES RELATED TO ORDNA MALIN HEAD.	DRAWINGS.
 ANY DISCREPANCIES BETWEEN THESE DOCUME BROUGHT TO THE ATTENTION OF THE ENGINEER DRAWINGS ARE NOT TO BE SCALED. 	
5. ALL DIMENSIONS ARE IN MILLIMETRES, UNLESS N OTHERWISE.	IOTED
LEGEND: Planning Application Boundary	
160 Existing Contour	
▲ 1211	
-	
Map Reproduced From Ordnance Survey Irela By Permission Of The Government. CYAL50332198	
OSI SHEET NO: 4622-A, 4622-C, 4622-B, 4563 4562-D, 4621-B, 4562-C, 4562-A & 4562	3-С,
P01 08.12.23 Issued For Planning REV DATE DESCRIPTION	JK PC BY APP
Ballycar Wind Farm	
Existing Contours	
CLIENT:	
BALLYCAR Green Energy	
	MERICK mwp.ie
DRAWN: CHECKED: APPROVE JK PC PC PROJECT NUMBER: DATE: SCALE @ 22156 December 2023 PC	ОН
STATUS DESCRIPTION FOR INFORMATION	STATUS: S2 REV:

DRAWING NUMBER: 22156 - MWP - 00 - 00 - DR - C - 5004 P01

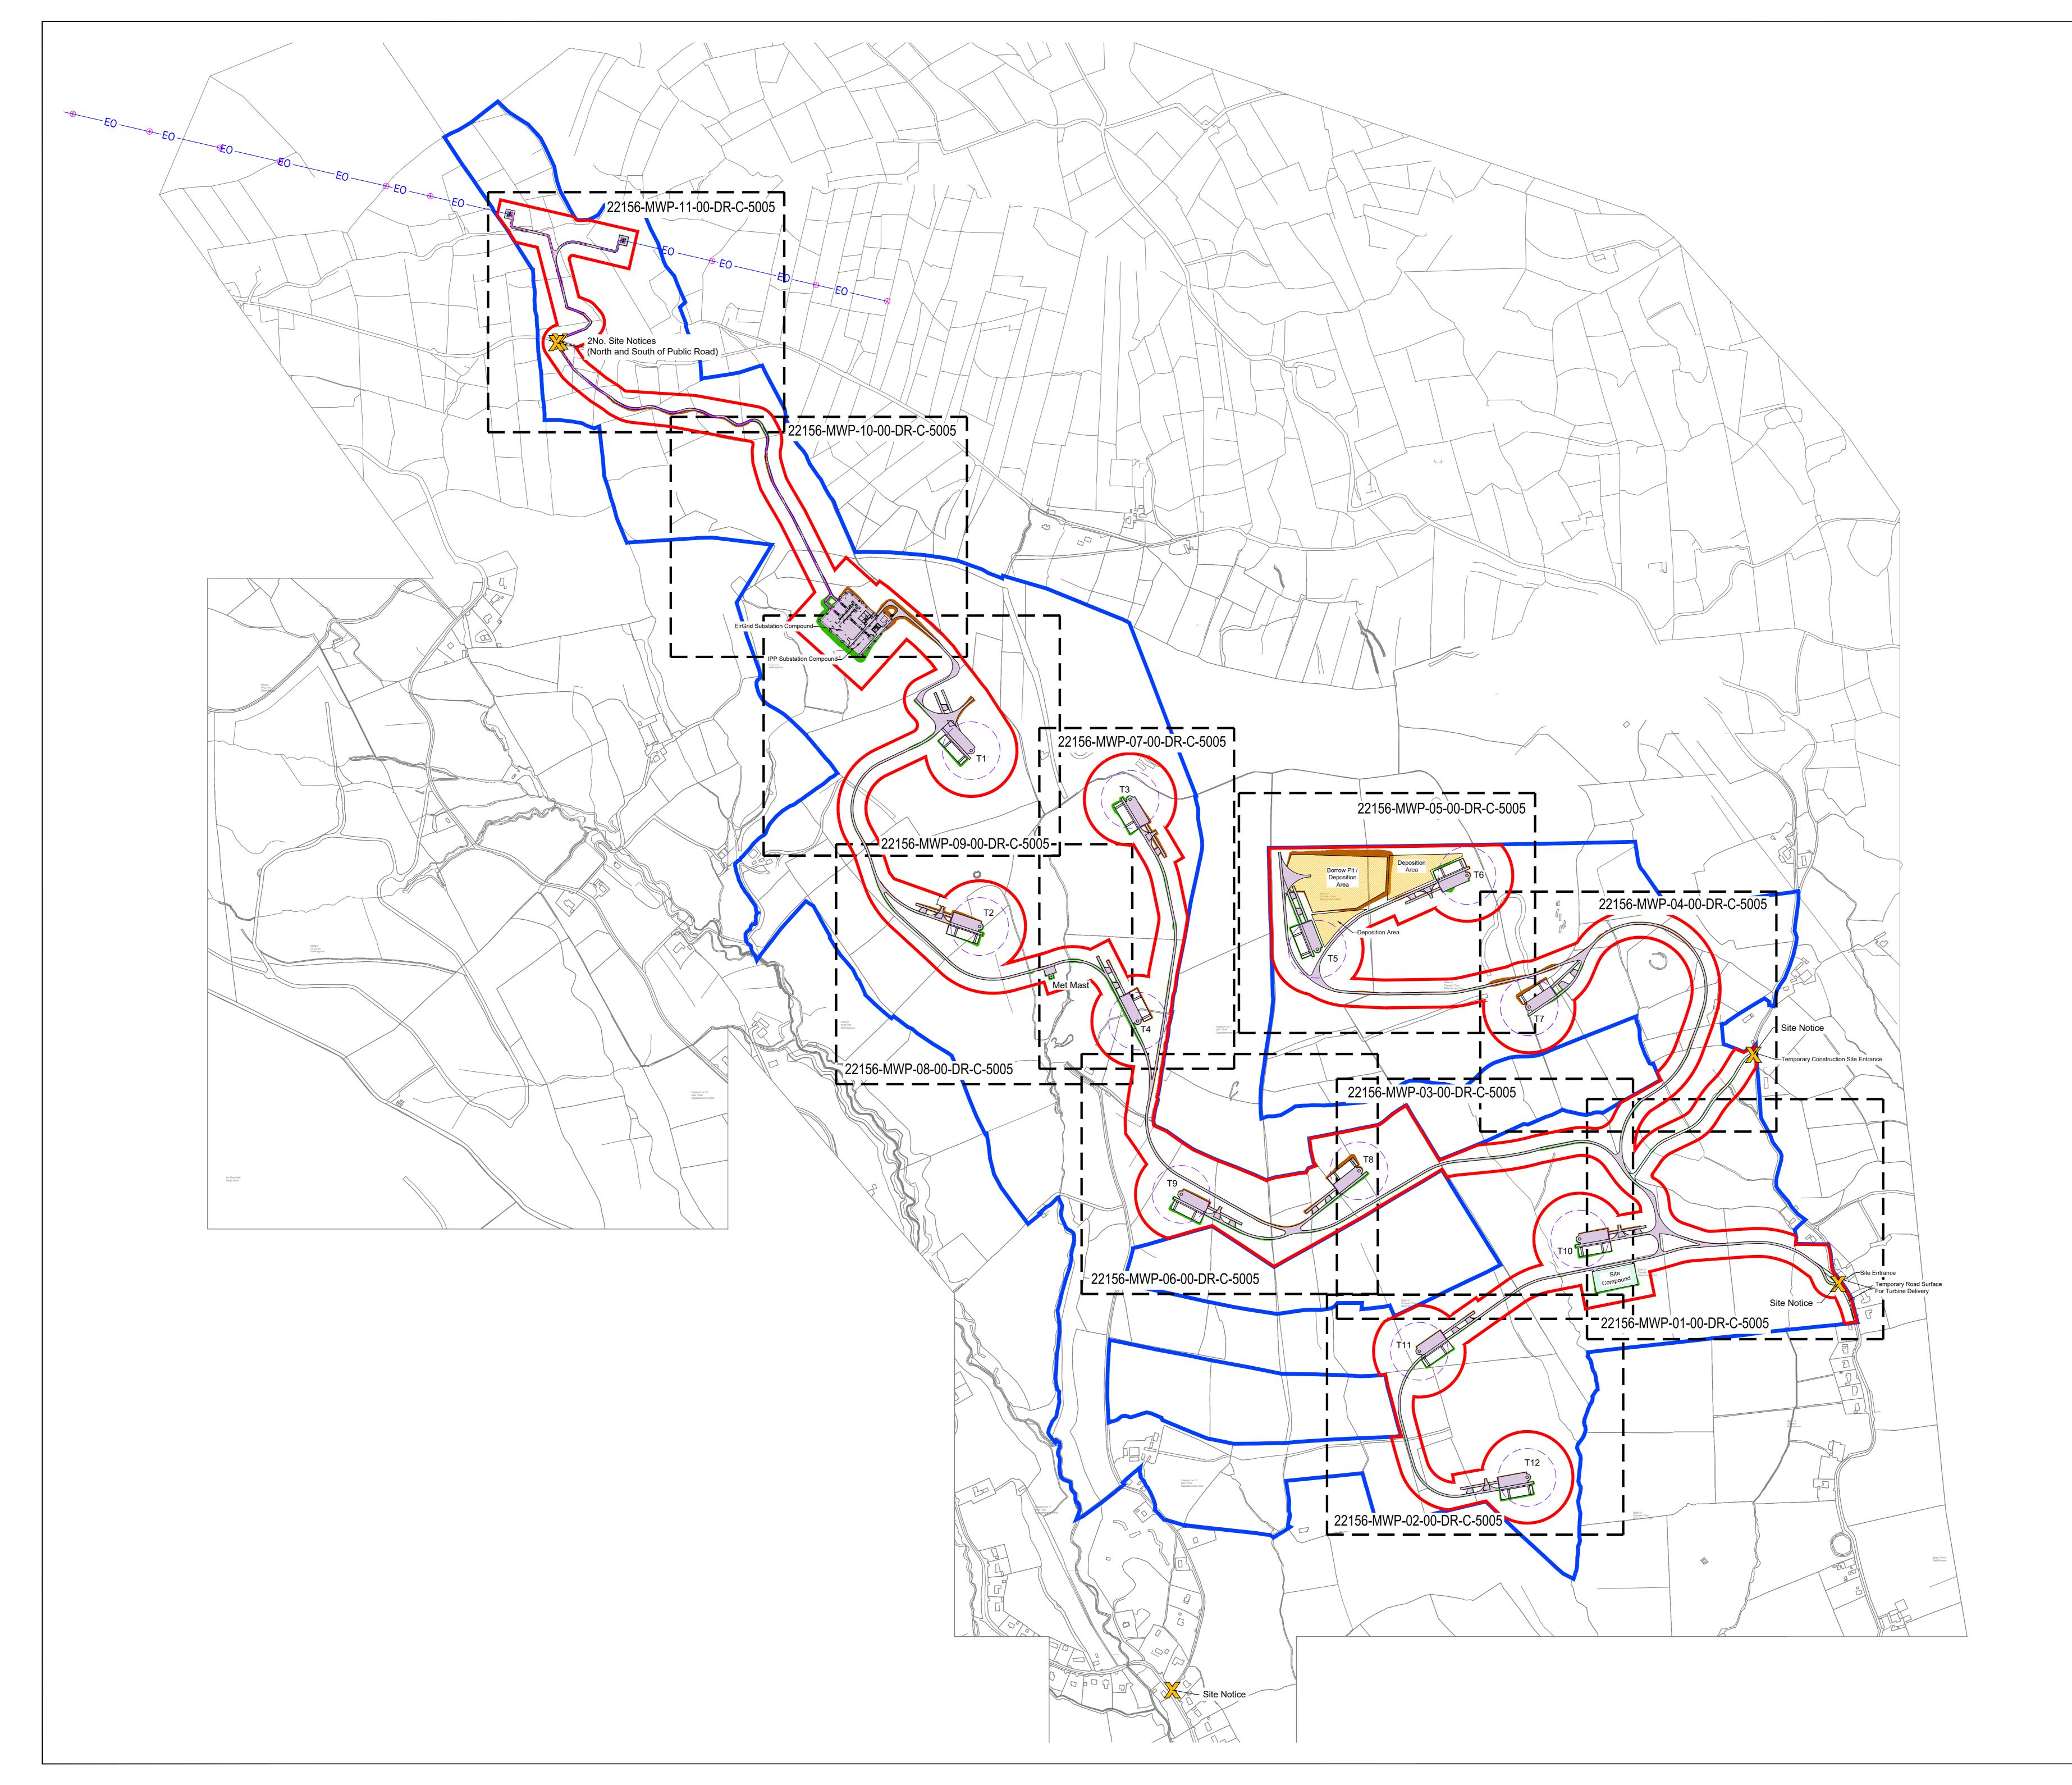



© THIS DRAWING IS COP	SPECIFICATIO (RIGHT AND MAY O DESIGNERS PERMI		ED WITH THE
NOTES: 1. ALL DRAWINGS AF RELEVANT SPECIF ARCHITECTURAL,	ICATIONS, BILLS	OF QUANTITIES,	
 ALL LEVELS ARE II MALIN HEAD. ANY DISCREPANC BROUGHT TO THE 	ES BETWEEN TH	ESE DOCUMENT	
 DRAWINGS ARE NO ALL DIMENSIONS A OTHERWISE. 			TED
DRAWING REFERENCE 22156-MWP-00-00-DR-C-		e Layout - Master S	Sheet
EGEND:	Landholding Bo	-	
	Planning Applic	and	
	68m Blade Ove Access Track (ōm Wide)	
	Temporary Acc Temporary Site Borrow Pit / Dep		e) /
===		nection - Circuit A nection - Circuit B	
EO	Existing Overhe	ad 110kV line	
	Fill		
Turbine No T1 T2		Existing Ground L 233.5 204.1	evel (m)
T3 T4		204.1 232.1 192.6	
T5 T6 T7		239.7 247.6 194.8	
T8 T9 T10		161.4 166.4 114.5	
T11 T12		107.6 76.8	
Met Mast		185	
By P OSI SHEET	ermission Of The G CYAL5033219 NO: 4622-A, 4622-	98. C, 4622-B, 4563-C	
By P OSI SHEET	ermission Of The G CYAL5033219	Bovernment. 98 C, 4622-B, 4563-C 4562-A & 4562 nning	JK PC
By P OSI SHEET 4562-D 201 08.12.23	ermission Of The G CYAL5033219 NO: 4622-A, 4622- , 4621-B, 4562-C, 4 Issued For Plar DESCRIPTION	Bovernment. 98 C, 4622-B, 4563-C 4562-A & 4562 nning	JK PC
By P OSI SHEET 4562-D ROJECT: Ballycar Wind	ermission Of The G CYAL5033219 NO: 4622-A, 4622- , 4621-B, 4562-C, 4 Issued For Plar DESCRIPTION	Sovernment. 98 C, 4622-B, 4563-C 4562-A & 4562 nning	JK PC
By P OSI SHEET 4562-D ROJECT: Ballycar Wind ITLE: Site Layout -	ermission Of The G CYAL5033219 NO: 4622-A, 4622- , 4621-B, 4562-C, 4 Issued For Plar DESCRIPTION	Sovernment. 98 C, 4622-B, 4563-C 4562-A & 4562 nning	JK PC
DSI SHEET 4562-D PO1 08.12.23 REV DATE ROJECT: Ballycar Wind ITLE: Site Layout - CLIENT: BALLYCAR Green Energy ENGINEERING CORK	ermission Of The G CYAL5033219 NO: 4622-A, 4622- , 4621-B, 4562-C, 4 Issued For Plar DESCRIPTION d Farm Master Shee Master Shee Master Shee	Bovernment. 28 C, 4622-B, 4563-C 4562-A & 4562 Inning 4 et Ext Ext Ext Ext Ext Ext Ext Ex	JK PC BY APP
By P OSI SHEET 4562-D PO1 08.12.23 REV DATE ROJECT: Ballycar Wind ITLE: Site Layout - CLIENT: CILENT:	ermission Of The G CYAL5033219 NO: 4622-A, 4622- , 4621-B, 4562-C, 4 Issued For Plar DESCRIPTION d Farm Master Shee	Sovernment. 28 C, 4622-B, 4563-C 4562-A & 4562 mining 4 et VIP ENTAL CONSULTAT ONDON LIME mv APPROVED: SCALE @ A0:	JK PC BY APF

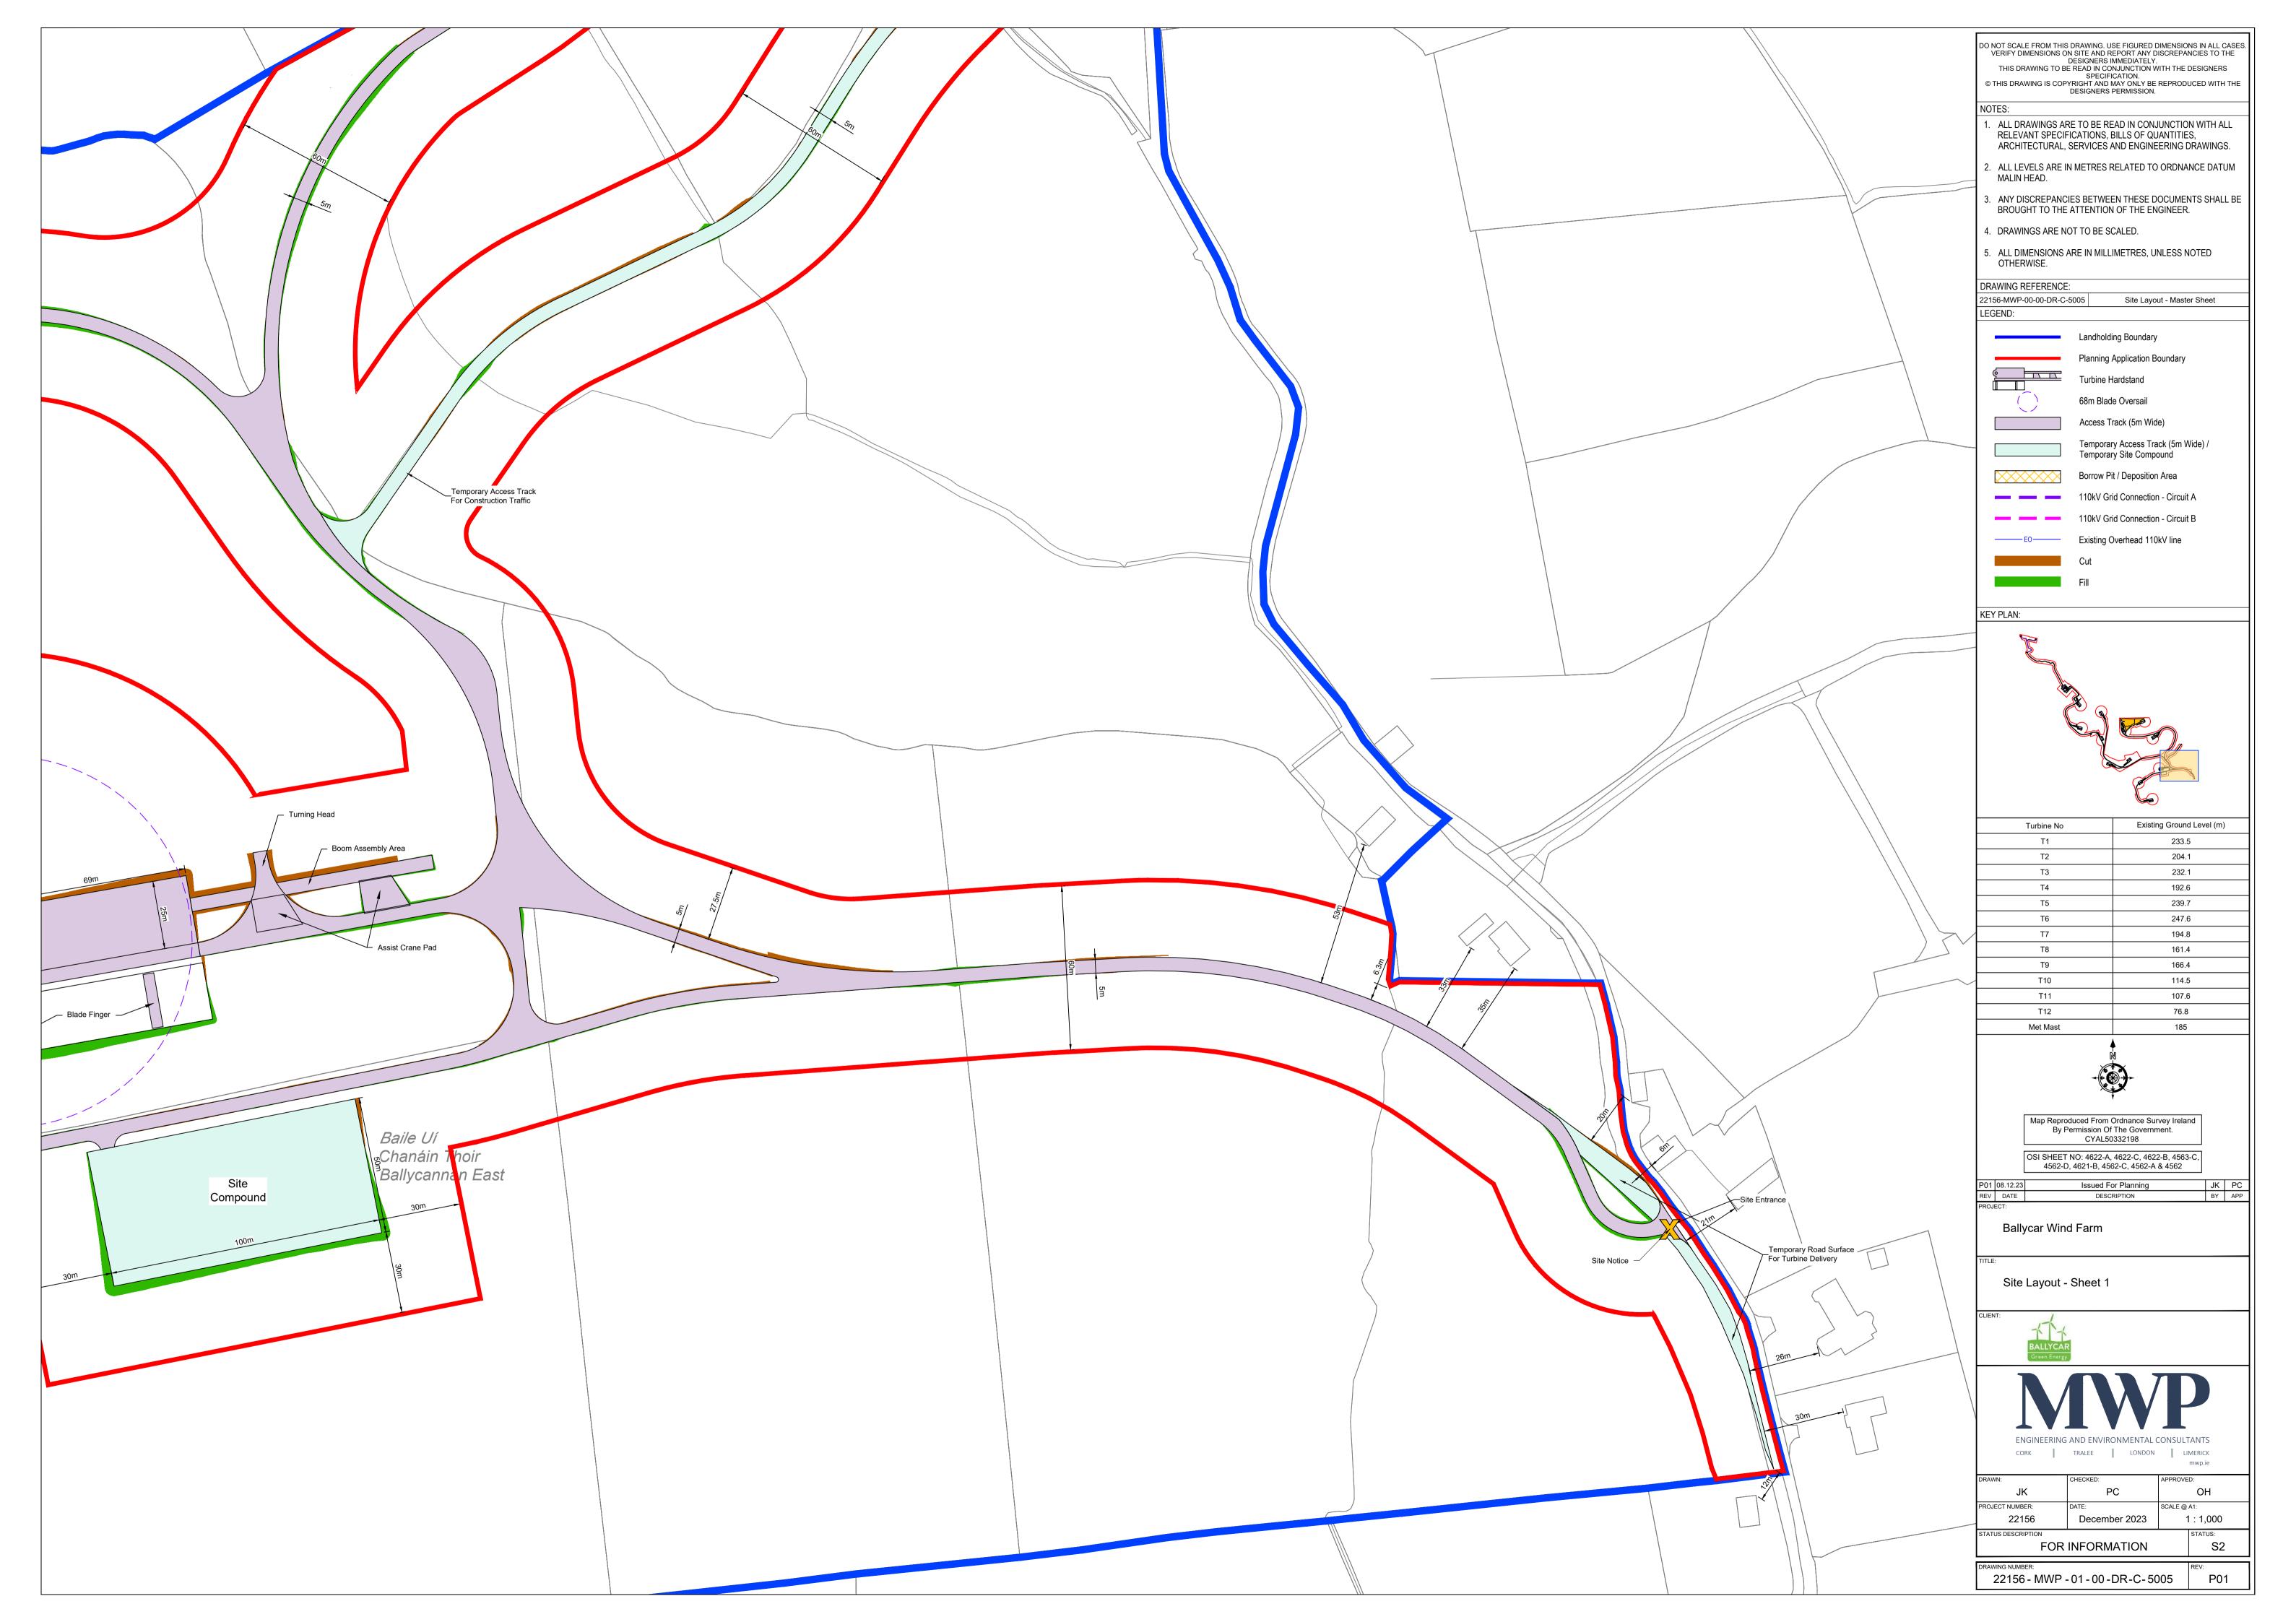





DO NOT SCALE FROM THIS		
THIS DRAWING TO BE	N SITE AND REPORT ANY D DESIGNERS IMMEDIATELY. READ IN CONJUNCTION W SPECIFICATION. 'RIGHT AND MAY ONLY BE DESIGNERS PERMISSION.	ITH THE DESIGNERS
ARCHITECTURAL, S	E TO BE READ IN CONJ ICATIONS, BILLS OF QU SERVICES AND ENGINE I METRES RELATED TO	ANTITIES, ERING DRAWINGS.
 ANY DISCREPANCI BROUGHT TO THE DRAWINGS ARE NO 		GINEER.
OTHERWISE. DRAWING REFERENCE: 22156-MWP-00-00-DR-C-5		ut - Master Sheet
LEGEND:	Landholding Boundary Planning Application Bo	oundary
	Turbine Hardstand 68m Blade Oversail Access Track (5m Wide	
	Temporary Access Tra Temporary Site Compo Borrow Pit / Deposition 110kV Grid Connection	Area
EO	110kV Grid Connection Existing Overhead 110 Cut	
KEY PLAN:	Fill	
		0,
	a e	
Turbine No	C	ng Ground Level (m)
T1 T2	C	ng Ground Level (m) 233.5 204.1
T1	C	ig Ground Level (m) 233.5
T1 T2 T3 T4	C	ng Ground Level (m) 233.5 204.1 232.1 192.6
T1 T2 T3 T4 T5 T6	C	Ig Ground Level (m) 233.5 204.1 232.1 192.6 239.7 247.6
T1 T2 T3 T4 T5 T6 T7 T8	C	Ig Ground Level (m) 233.5 204.1 232.1 192.6 239.7 247.6 194.8 161.4
T1 T2 T3 T4 T5 T6 T7 T8 T9 T10 T11 T12	C	g Ground Level (m) 233.5 204.1 232.1 192.6 239.7 247.6 194.8 161.4 166.4 114.5 107.6 76.8
T1 T2 T3 T4 T5 T6 T7 T8 T9 T10 T11	C	ng Ground Level (m) 233.5 204.1 232.1 192.6 239.7 247.6 194.8 161.4 166.4 114.5 107.6
T1 T2 T3 T4 T5 T6 T7 T8 T9 T10 T11 T12 Met Mast Map Reproc By Peter OSI SHEET	C	reg Ground Level (m) 233.5 204.1 232.1 192.6 239.7 247.6 194.8 161.4 166.4 114.5 107.6 76.8 185 vey Ireland tent. 2-B, 4563-C,
T1 T2 T3 T4 T5 T6 T7 T8 T9 T10 T11 T12 Met Mast Map Reproc By Peter OSI SHEET	Existin	reg Ground Level (m) 233.5 204.1 232.1 192.6 239.7 247.6 194.8 161.4 166.4 114.5 107.6 76.8 185 vey Ireland tent. 2-B, 4563-C,
T1 T2 T3 T4 T5 T6 T7 T8 T9 T10 T11 T12 Met Mast Map Reproc By Peter 1 OSI SHEET 1 4562-D, P01 08.12.23 REV DATE PROJECT: Ballycar Winc TITLE: Site Layout -	Existin Existin	reg Ground Level (m) 233.5 204.1 232.1 192.6 239.7 247.6 194.8 161.4 166.4 114.5 107.6 76.8 185 vey Ireland tent. 2-B, 4563-C, & 4562 JK PC
T1 T2 T3 T4 T5 T6 T6 T7 T8 T9 T10 T11 T12 Met Mast Map Reproc By Pe OSI SHEET 4562-D, P01 08.12.23 REV DATE PROJECT: Ballycar Winc	Existin Existin	Ig Ground Level (m) 233.5 204.1 232.1 192.6 239.7 247.6 194.8 161.4 166.4 114.5 107.6 76.8 185 vey Ireland tent. 2-B, 4563-C, & 4562 JK PC
T1 T2 T3 T4 T5 T6 T7 T8 T9 T10 T11 T12 Met Mast Map Reproc By Pe OSI SHEET 4562-D, P01 08.12.23 REV DATE PROJECT: Ballycar Winc TITLE: Site Layout - CLIENT: EALLYCAR TUD TITLE: Site Layout -	Existin	Ig Ground Level (m) 233.5 204.1 232.1 192.6 239.7 247.6 194.8 161.4 166.4 114.5 107.6 76.8 185 Vey Ireland hent. 2-B, 4563-C, & 4562 UK PC K PC
T1 T2 T3 T4 T5 T6 T7 T8 T9 T10 T11 T12 Met Mast Map Reproc By Pe OSI SHEET 4562-D, P01 08.12.23 REV DATE PROJECT: Ballycar Winc TITLE: Site Layout - CLIENT: ENGINEERING CORK	Existin Existi	Ig Ground Level (m) 233.5 204.1 232.1 192.6 239.7 247.6 194.8 161.4 166.4 114.5 107.6 76.8 185 185 Vey Ireland hent. 2-B, 4563-C, & 4562
T1 T2 T3 T4 T5 T6 T7 T8 T9 T10 T11 T12 Met Mast Map Reproc By Pe OSI SHEET 4562-D, P01 08.12.23 REV DATE PROJECT: Ballycar Winc TITLE: Site Layout - CLIENT: ENGINEERING CORK	Existin Existi	Ing Ground Level (m) 233.5 204.1 232.1 192.6 239.7 247.6 194.8 161.4 166.4 114.5 107.6 76.8 185 Vey Ireland hent. 2-B, 4563-C, & 4562
T1 T2 T3 T4 T5 T6 T7 T8 T9 T10 T11 T12 Met Mast Map Reproc By Pe OSI SHEET 4562-0, P01 08.12.23 REV DATE PROJECT: Ballycar Winc TITLE: Site Layout - CLIENT: DRAWN: JK PROJECT NUMBER: QUI DRAWN: JK PROJECT NUMBER: QUI DRAWN:	Existin Existi	Ig Ground Level (m) 233.5 204.1 232.1 192.6 239.7 247.6 194.8 161.4 166.4 114.5 107.6 76.8 185 185 185 Vey Ireland tent. 2-B, 4563-C, & 4562 UK PC BY APP

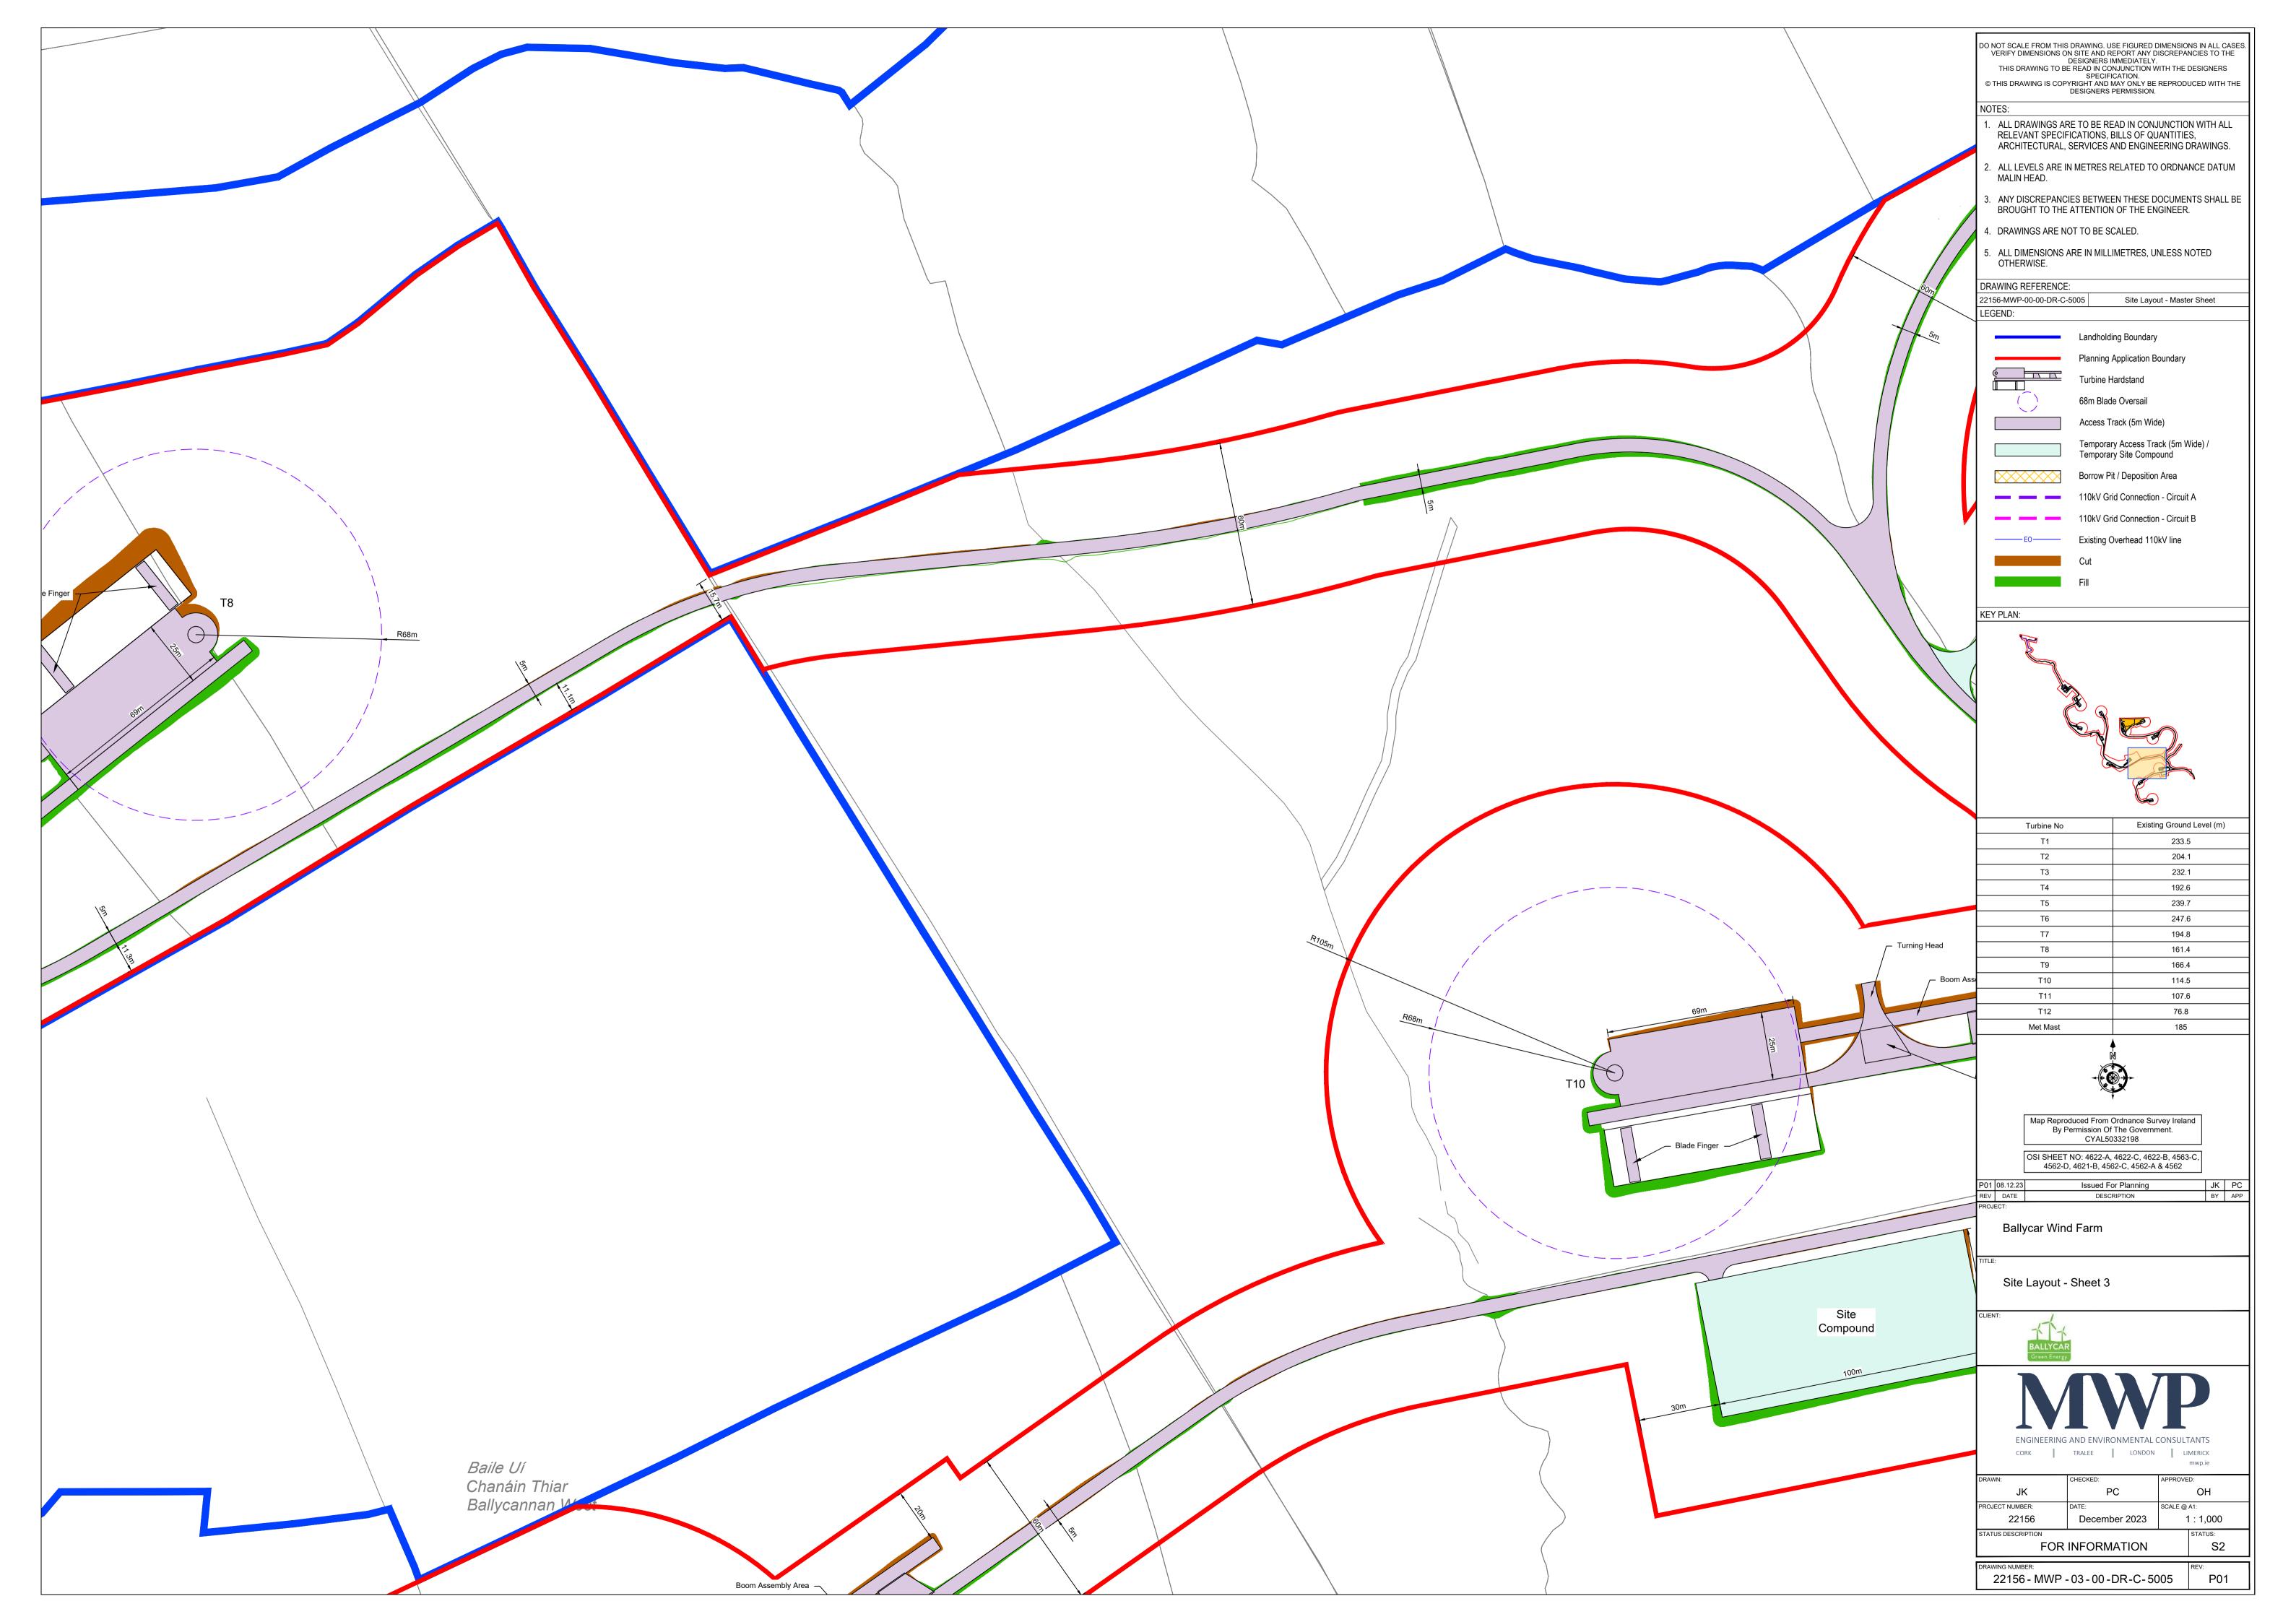

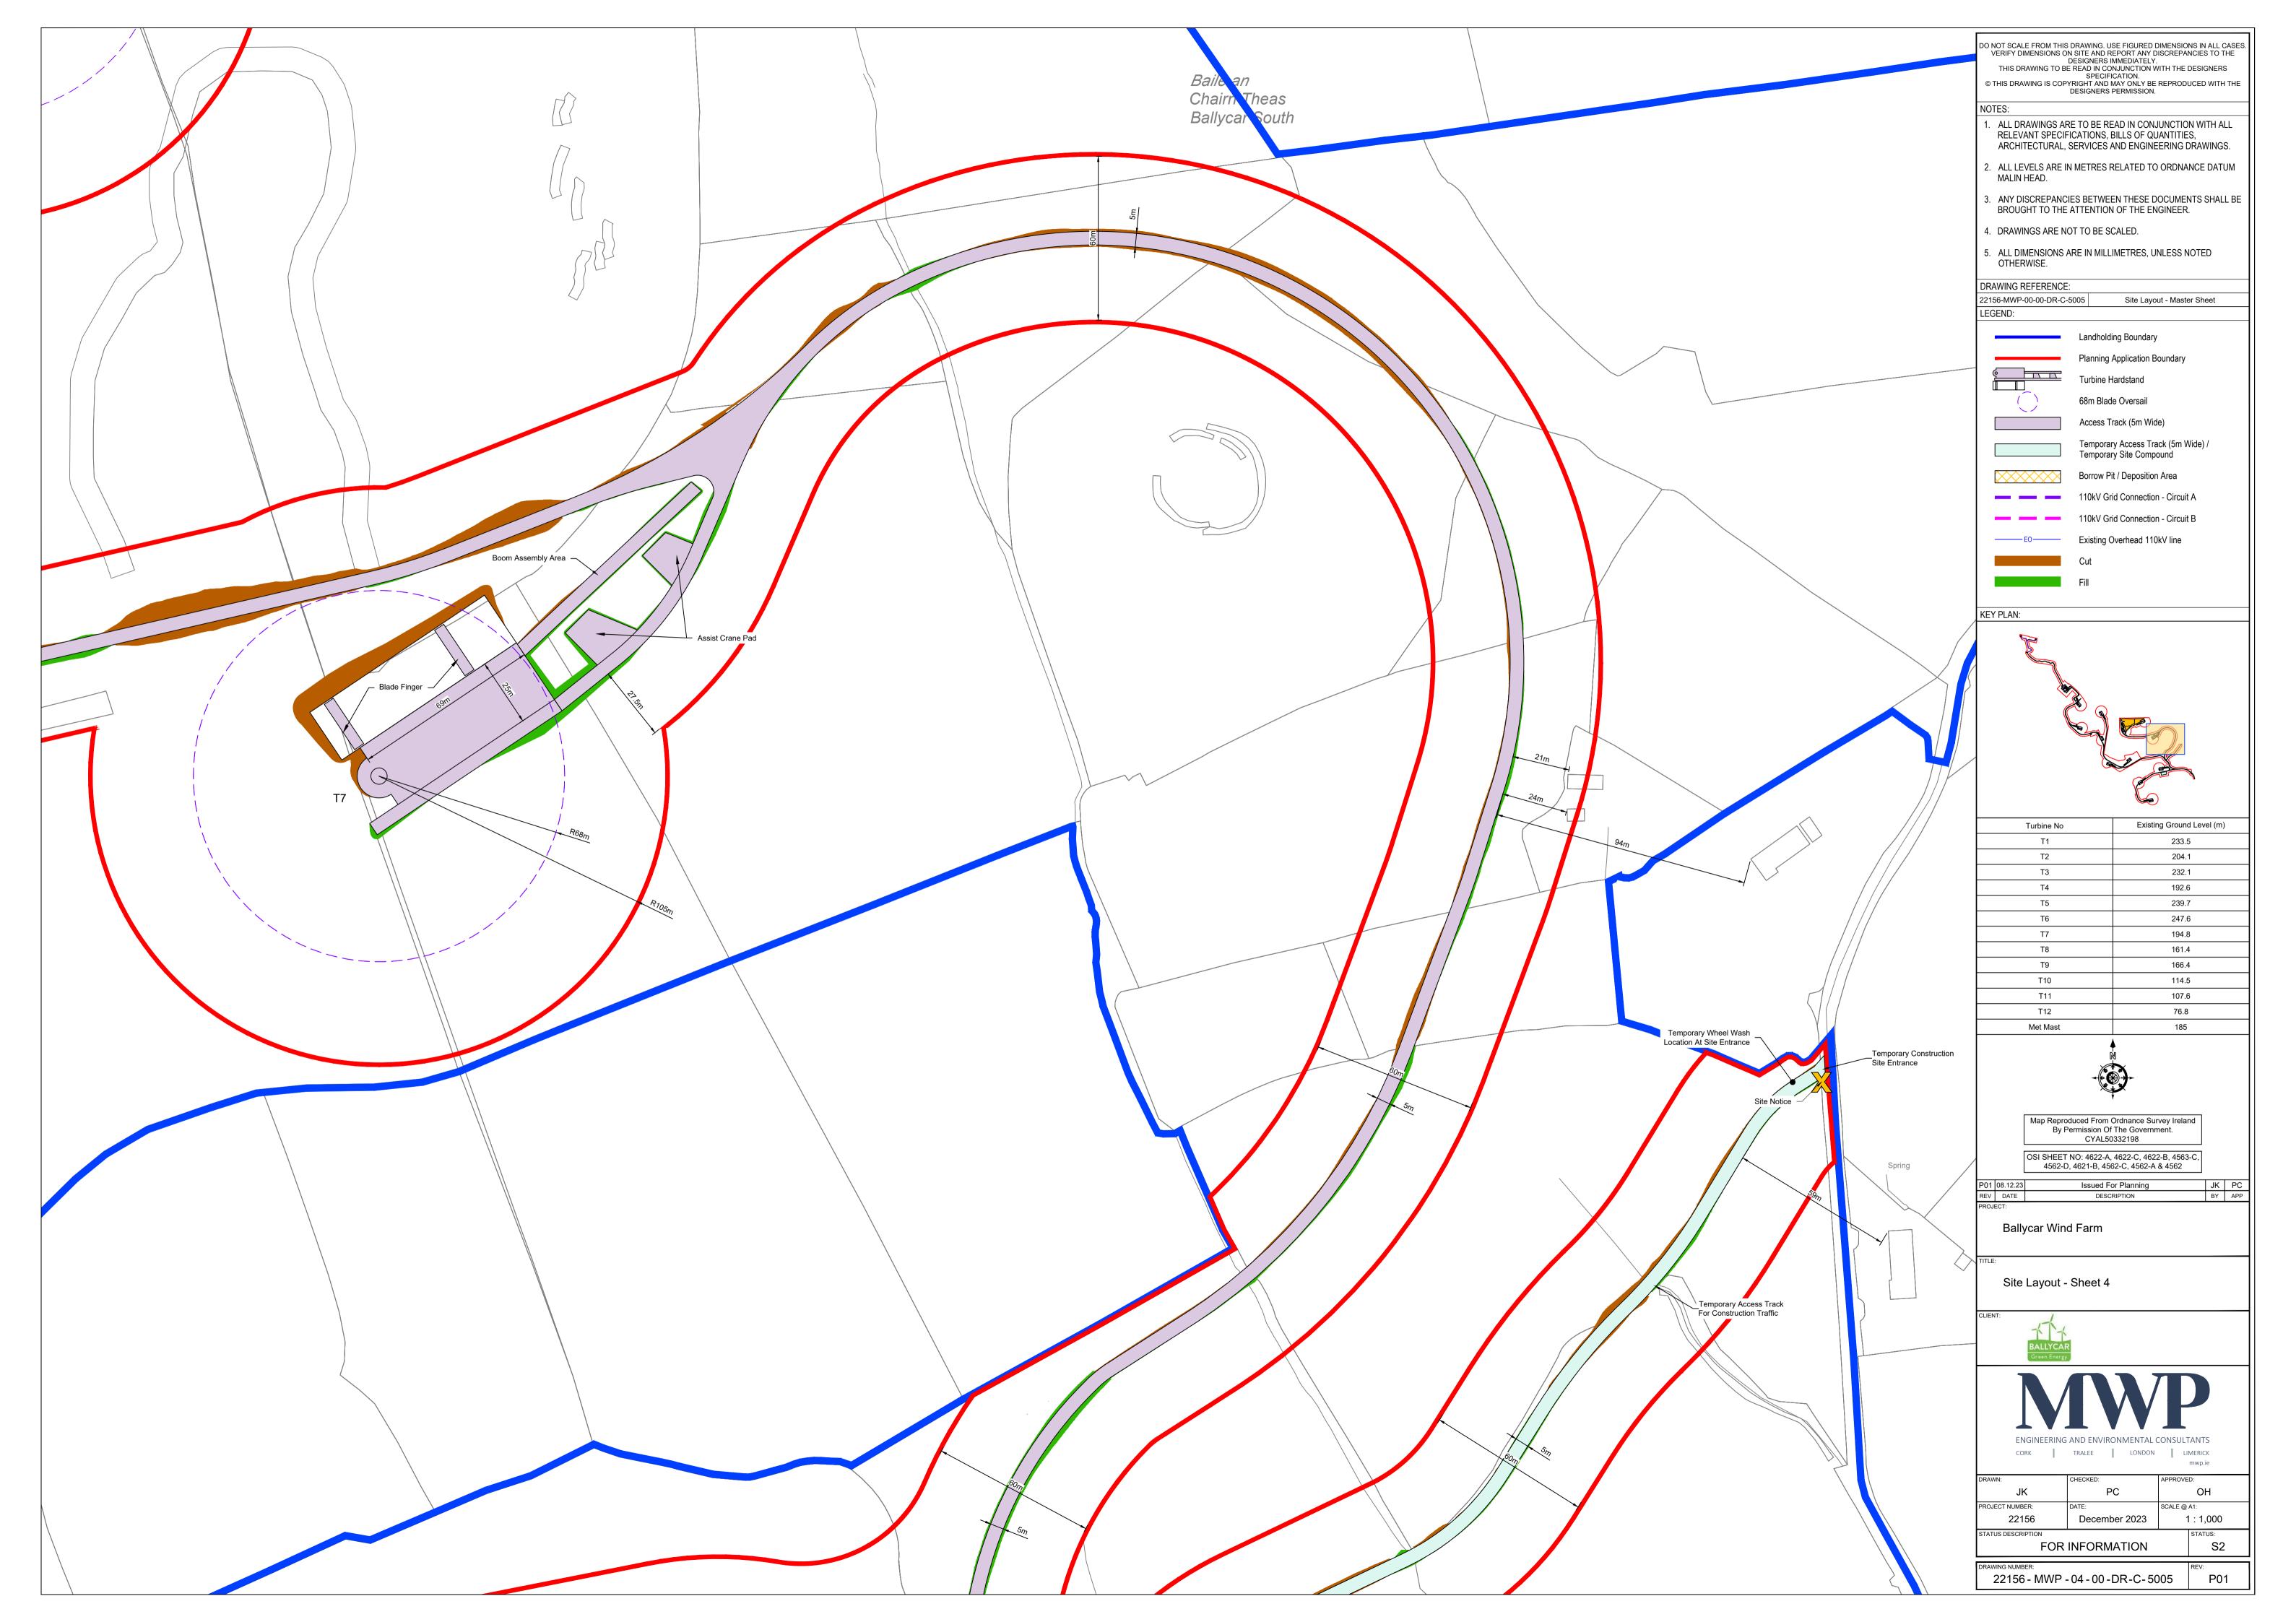


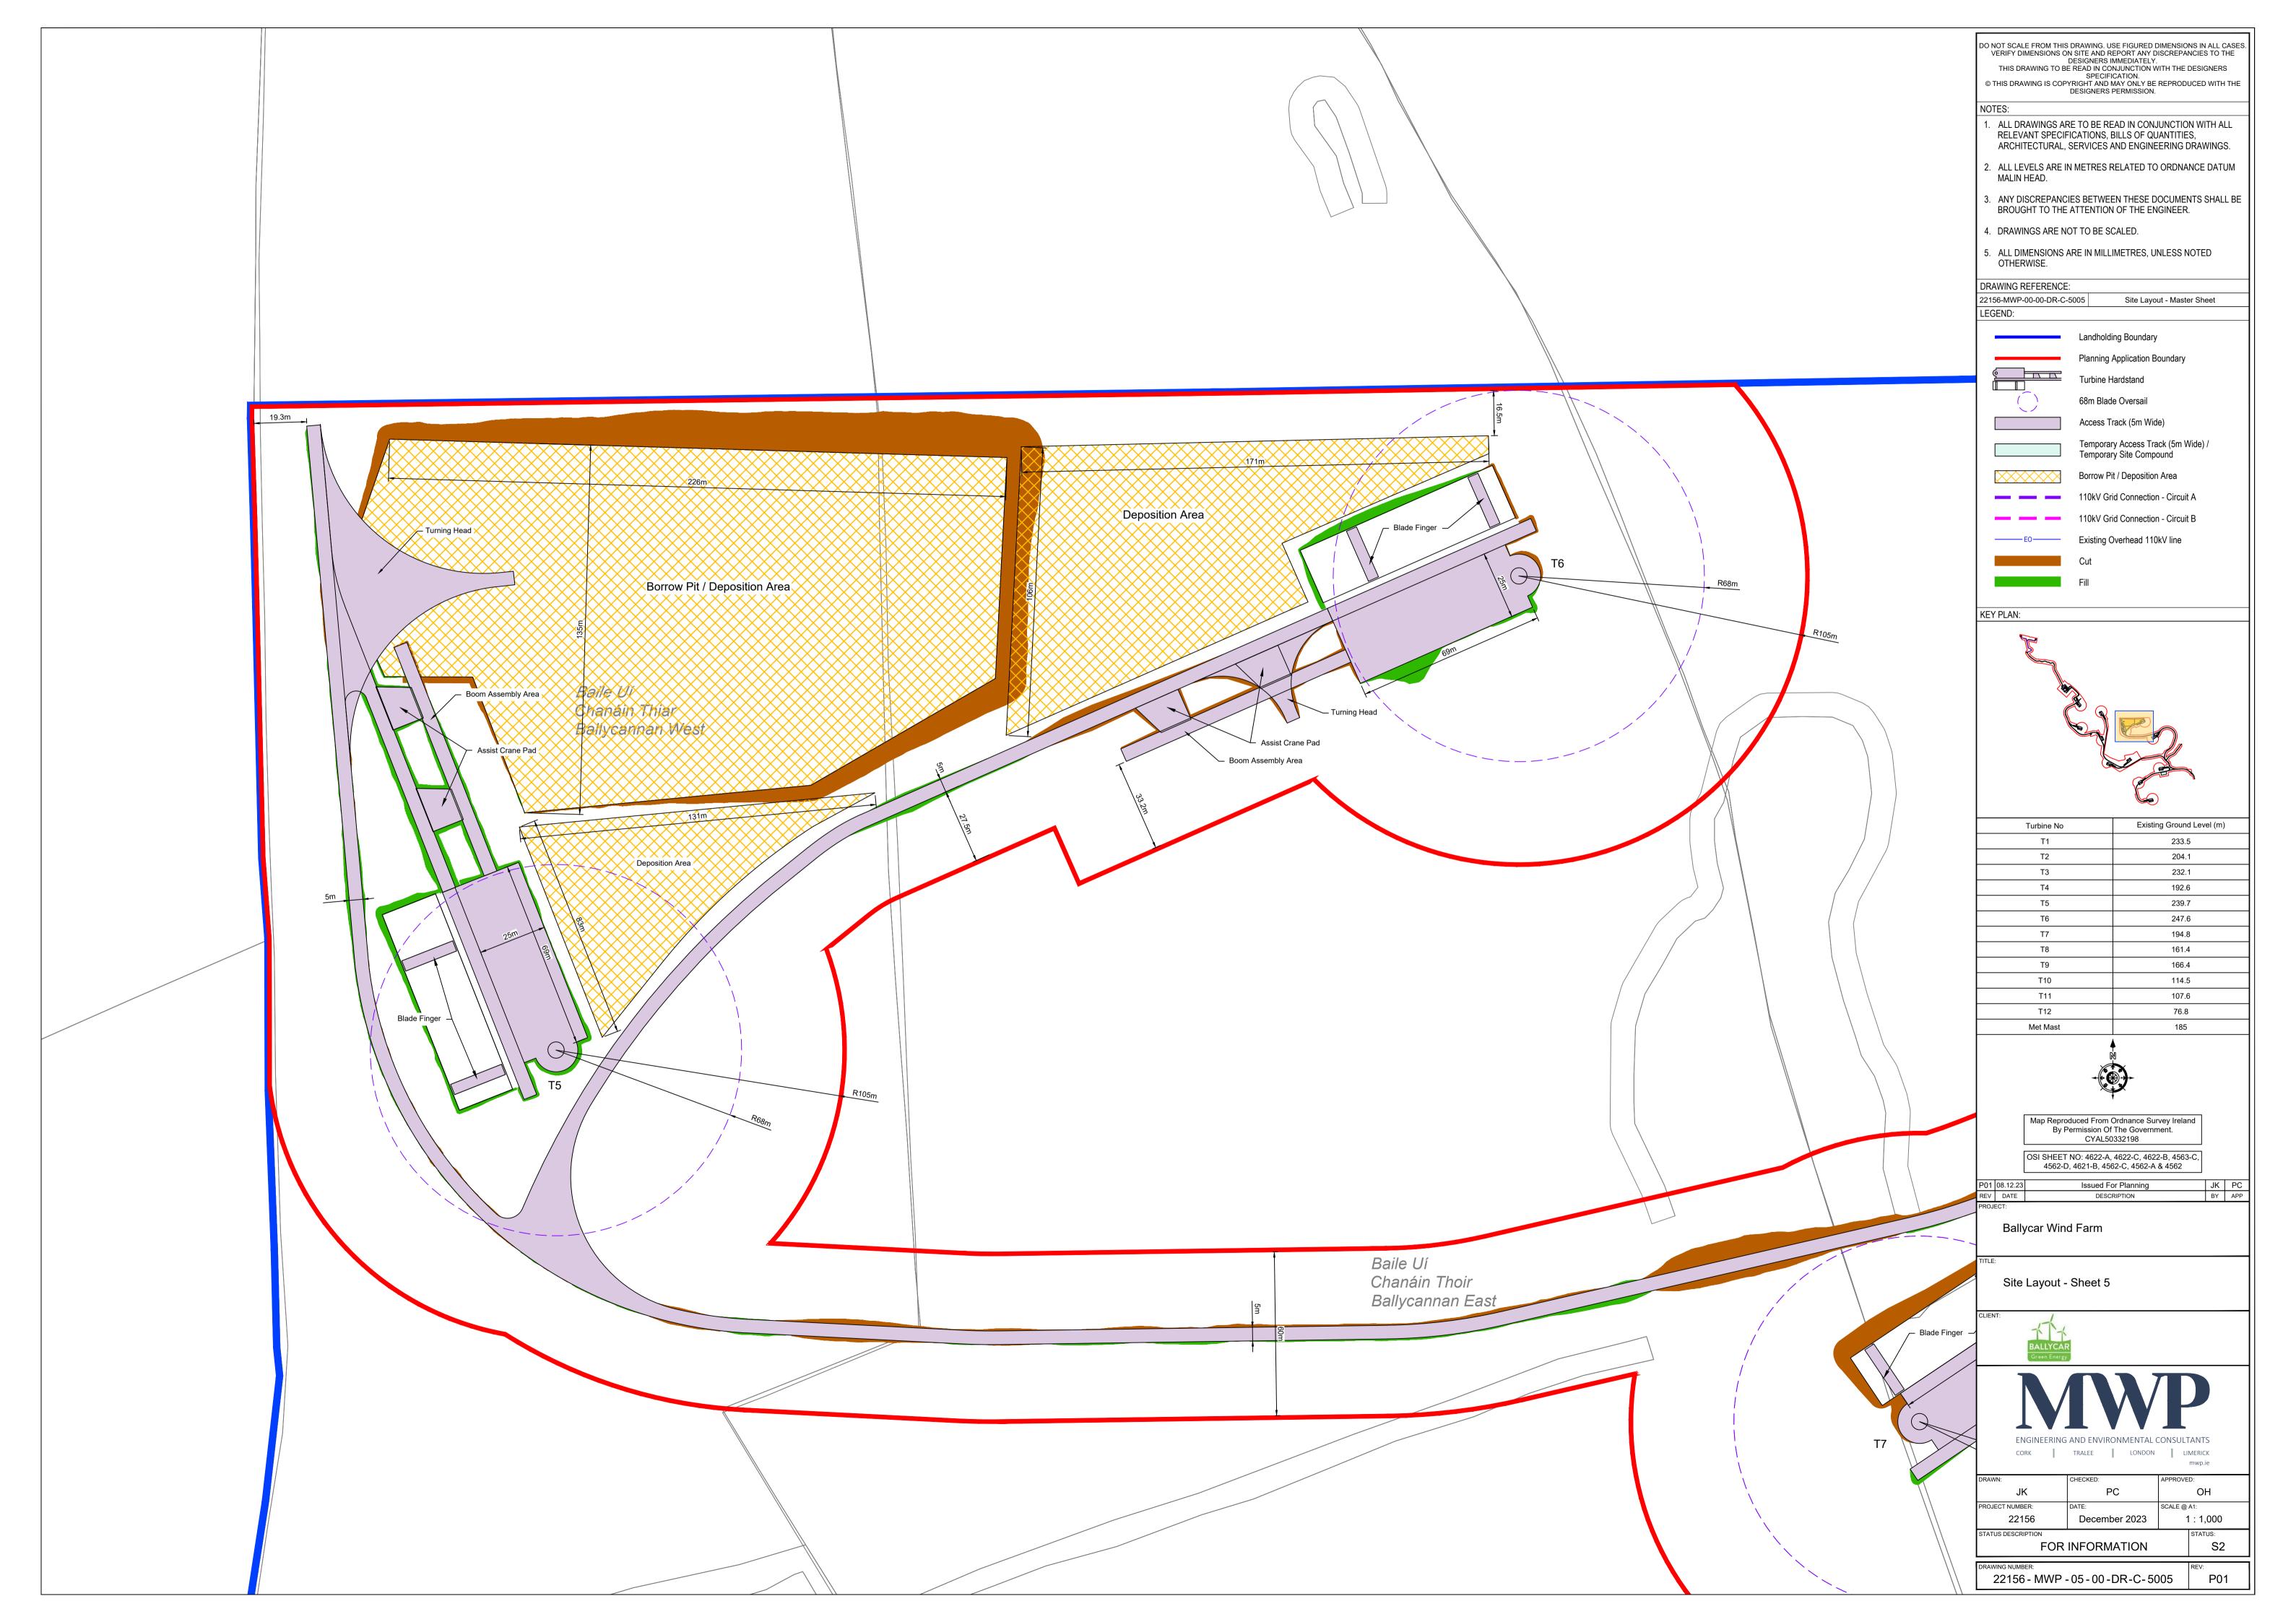




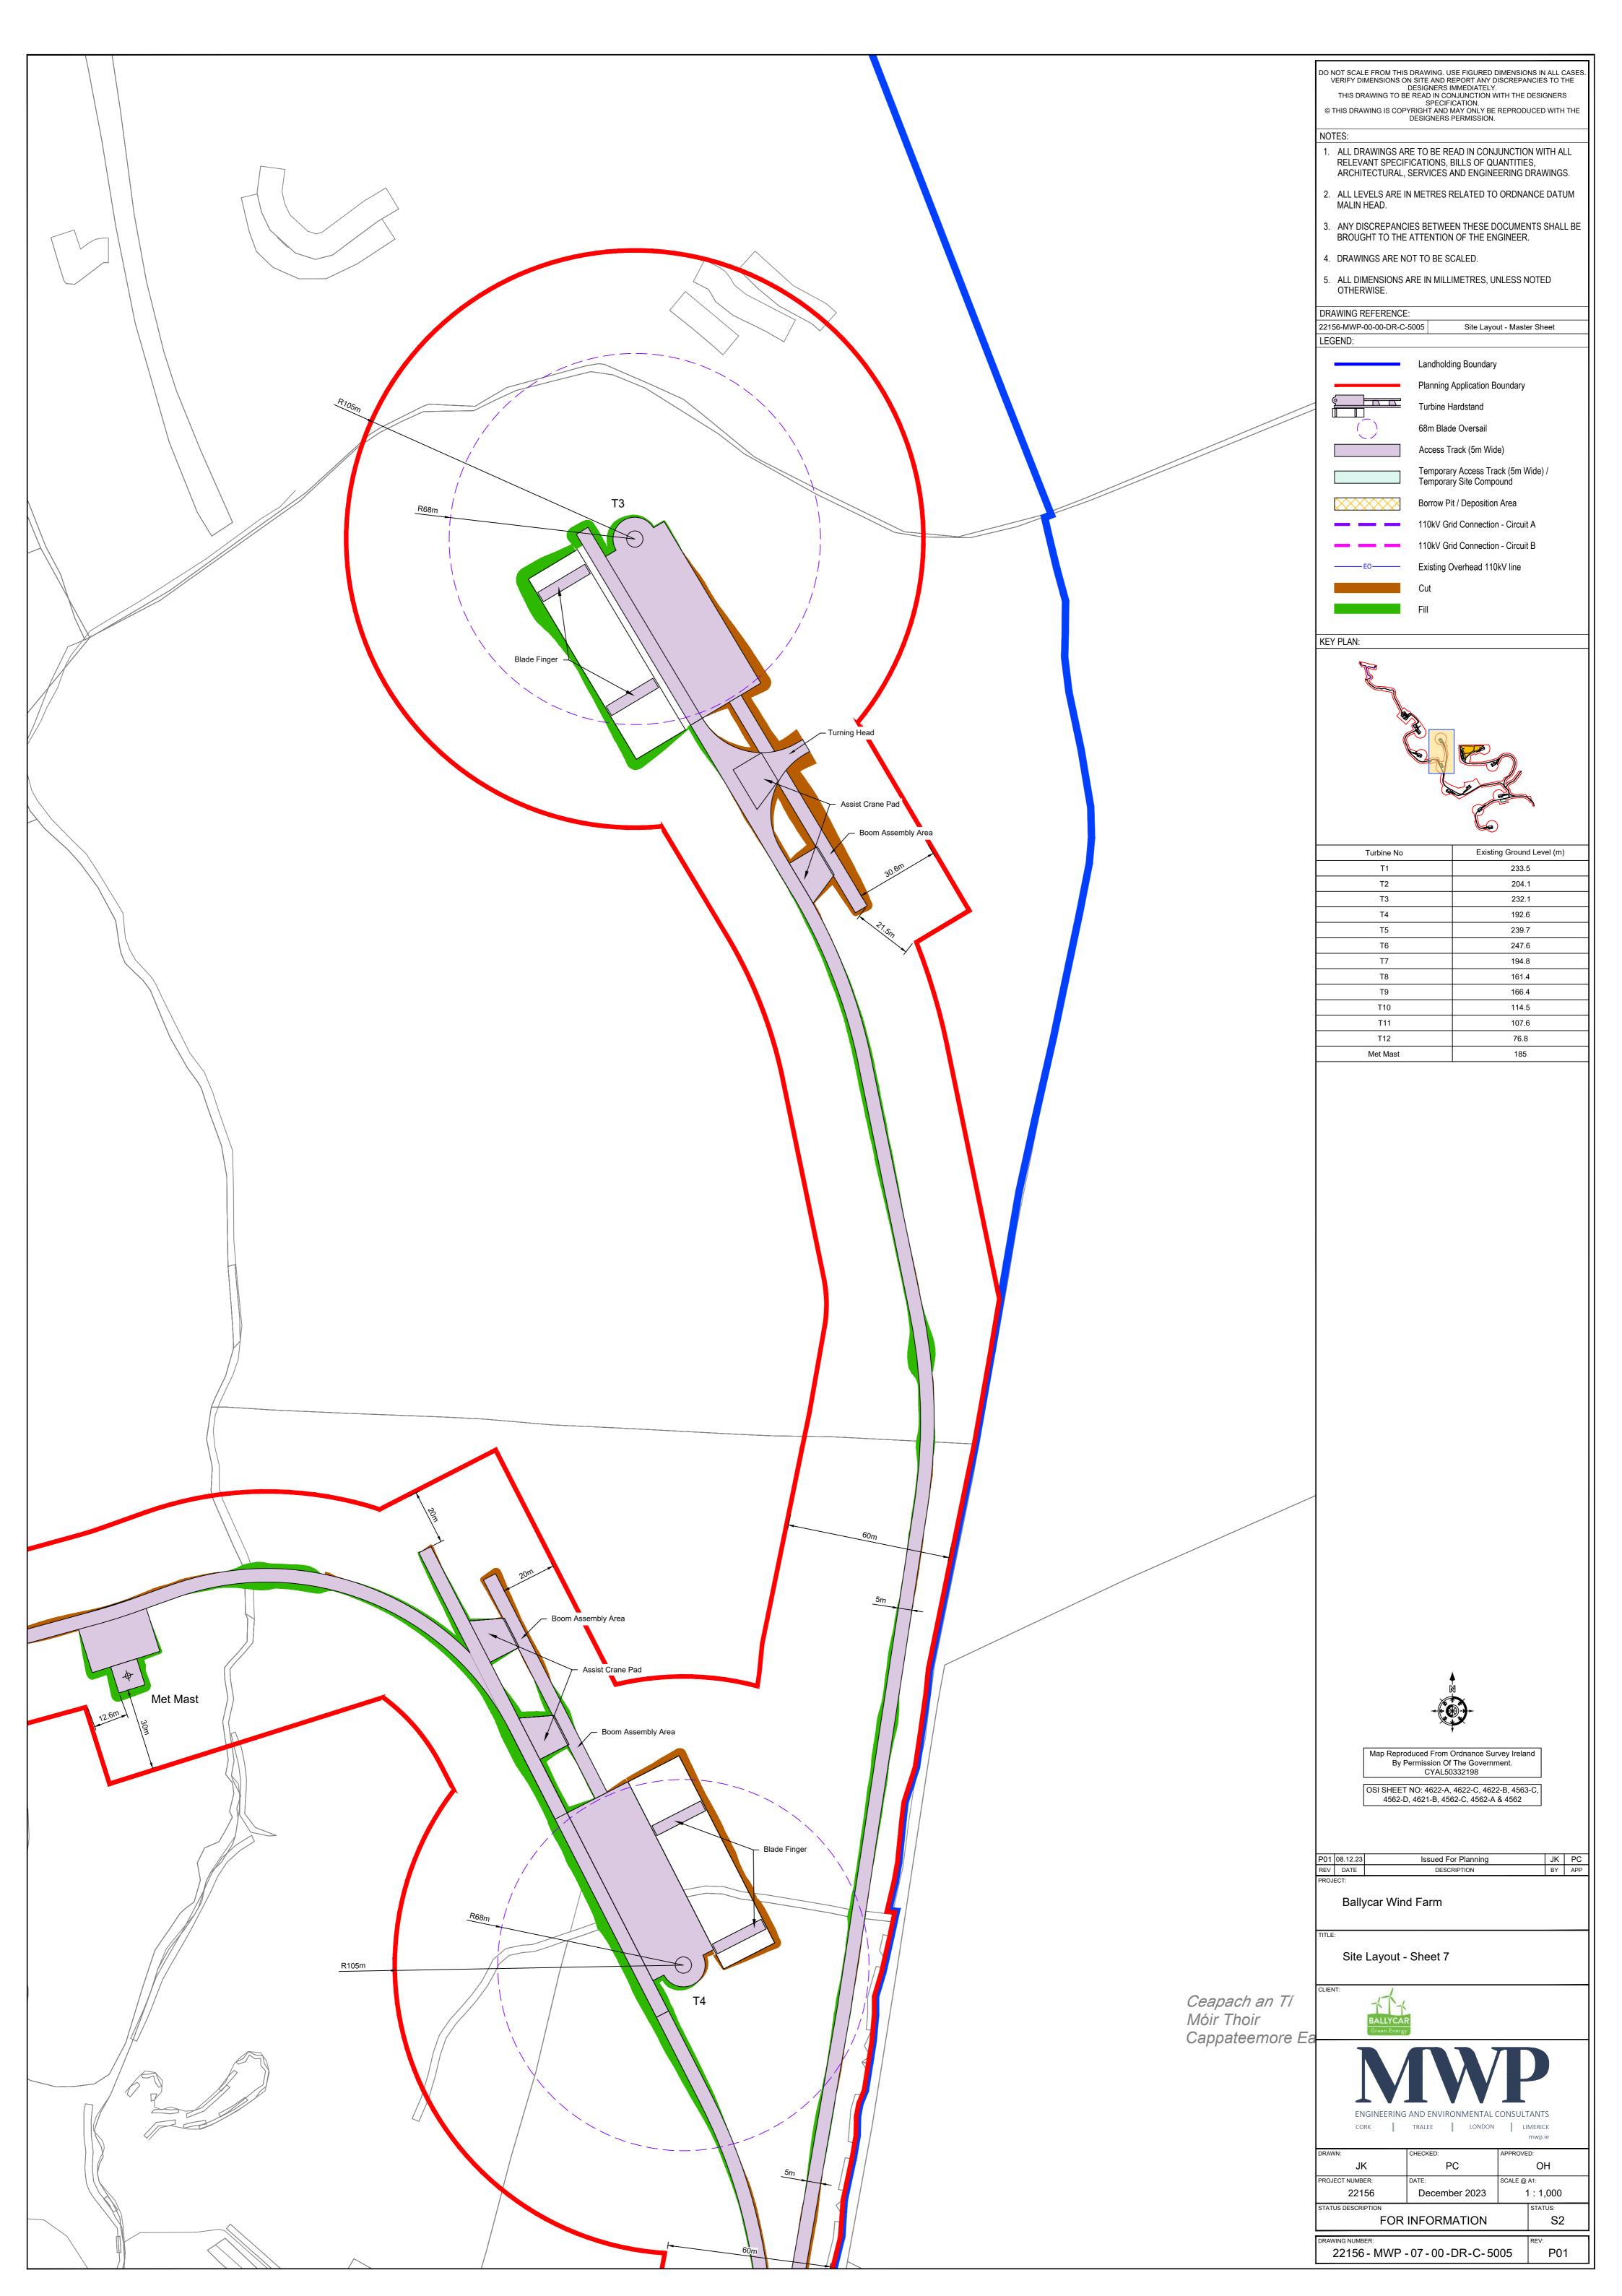





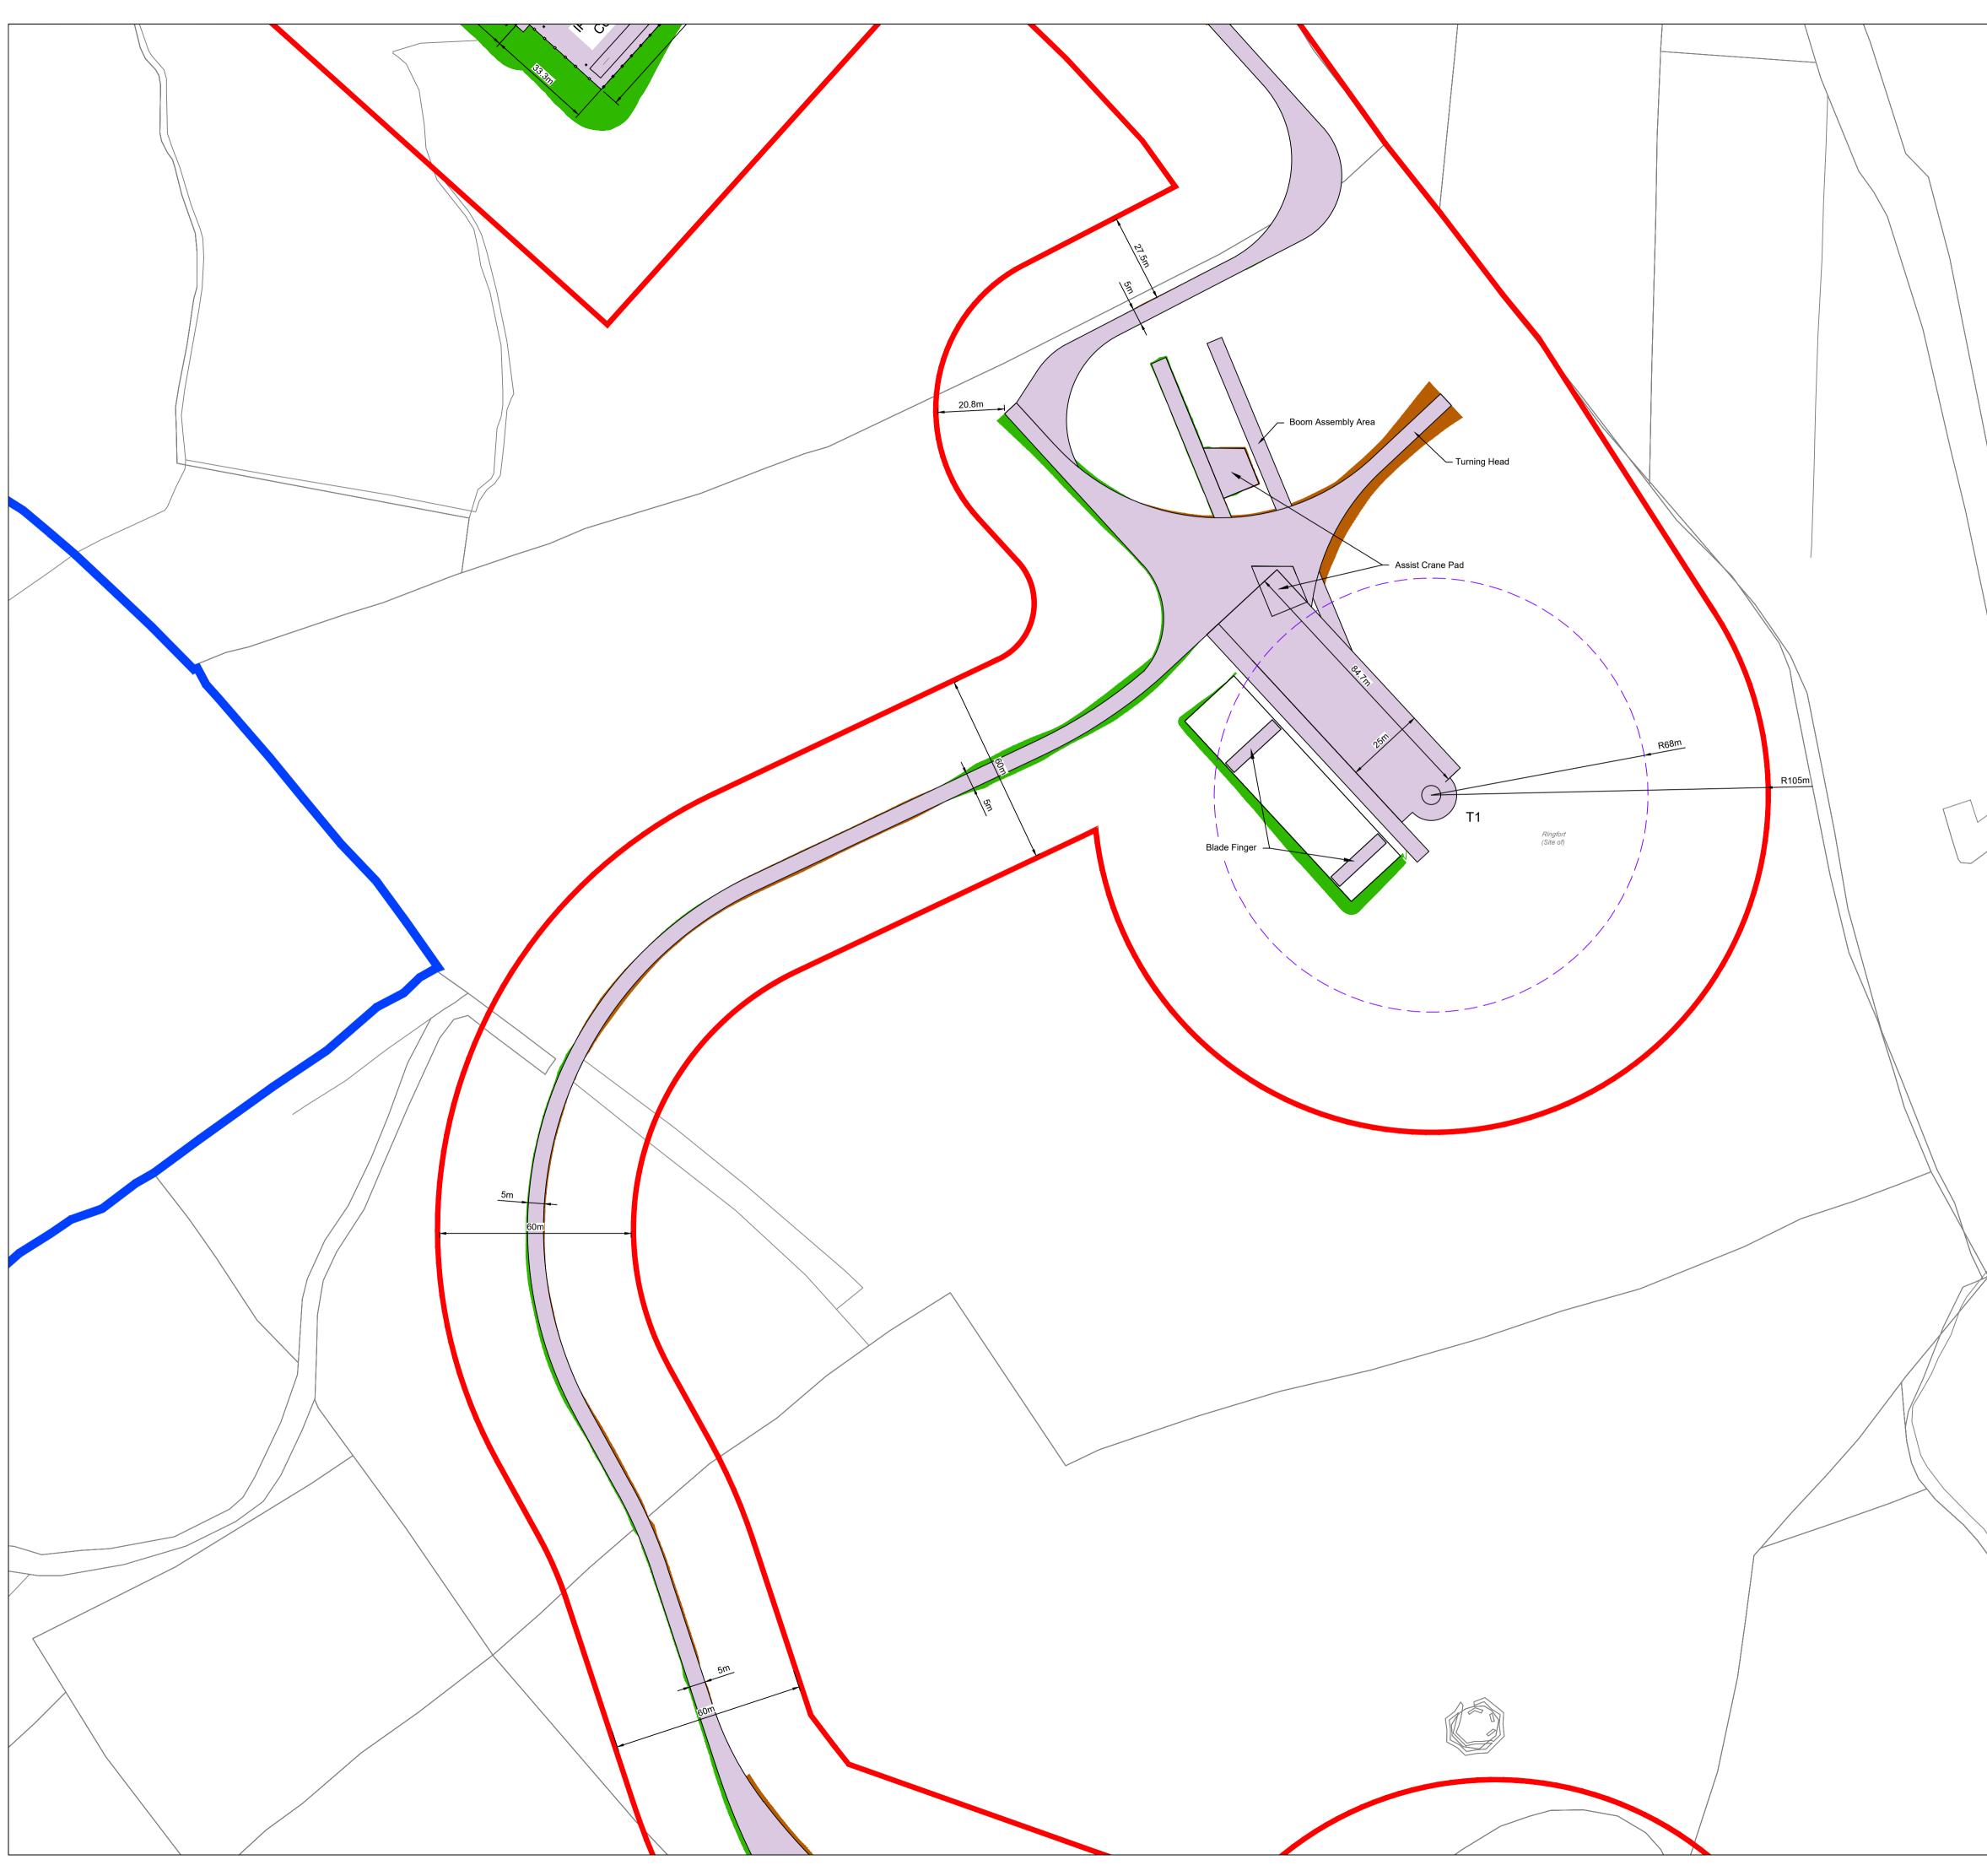



	DRAWING. USE FIGURED I SITE AND REPORT ANY I DESIGNERS IMMEDIATELY	DISCREPANCIES TO THE
THIS DRAWING TO BE	READ IN CONJUNCTION A SPECIFICATION. RIGHT AND MAY ONLY BE	WITH THE DESIGNERS
	DESIGNERS PERMISSION	
1. ALL DRAWINGS AR RELEVANT SPECIFI	CATIONS, BILLS OF QU	JANTITIES,
	SERVICES AND ENGINI	EERING DRAWINGS.
MALIN HEAD.		
3. ANY DISCREPANCI BROUGHT TO THE	ES BETWEEN THESE D ATTENTION OF THE EN	
4. DRAWINGS ARE NO	OT TO BE SCALED.	
5. ALL DIMENSIONS A OTHERWISE.	RE IN MILLIMETRES, U	INLESS NOTED
DRAWING REFERENCE:		
22156-MWP-00-00-DR-C-5	5005 Site Layo	out - Master Sheet
	Landholding Boundary	/
	Planning Application E	Boundary
	Turbine Hardstand 68m Blade Oversail	
	Access Track (5m Wid	de)
	Temporary Access Tr	ack (5m Wide) /
	Temporary Site Comp Borrow Pit / Deposition	
	110kV Grid Connectio	
	110kV Grid Connectio	n - Circuit B
EO	Existing Overhead 11	0kV line
	Cut	
	Fill	
KEY PLAN:		
K		
-		
Turbine No	Existi	ng Ground Level (m)
Turbine No T1 T2	Existi	ng Ground Level (m) 233.5 204.1
T1 T2 T3	Existi	233.5 204.1 232.1
T1 T2	Existi	233.5 204.1
T1 T2 T3 T4 T5 T6	Existi	233.5 204.1 232.1 192.6 239.7 247.6
T1 T2 T3 T4 T5 T6 T7 T8	Existi	233.5 204.1 232.1 192.6 239.7 247.6 194.8 161.4
T1 T2 T3 T4 T5 T6 T7	Existi	233.5 204.1 232.1 192.6 239.7 247.6 194.8
T1 T2 T3 T4 T5 T6 T7 T8 T9 T10 T11		233.5 204.1 232.1 192.6 239.7 247.6 194.8 161.4 166.4 114.5 107.6
T1 T2 T3 T4 T5 T6 T7 T7 T8 T9 T10		233.5 204.1 232.1 192.6 239.7 247.6 194.8 161.4 166.4 114.5
T1 T2 T3 T4 T5 T6 T7 T8 T9 T10 T11 T12		233.5 204.1 232.1 192.6 239.7 247.6 194.8 161.4 166.4 114.5 107.6 76.8
T1 T2 T3 T4 T5 T6 T7 T8 T9 T10 T11 T12		233.5 204.1 232.1 192.6 239.7 247.6 194.8 161.4 166.4 114.5 107.6 76.8
T1 T2 T3 T4 T5 T6 T7 T8 T9 T10 T11 T12 Met Mast		233.5 204.1 232.1 192.6 239.7 247.6 194.8 161.4 166.4 114.5 107.6 76.8 185
T1 T2 T3 T4 T5 T6 T7 T8 T9 T10 T11 T12 Met Mast	Luced From Ordnance Supermission Of The Governmeter	233.5 204.1 232.1 192.6 239.7 247.6 194.8 161.4 166.4 114.5 107.6 76.8 185
T1 T2 T3 T4 T5 T6 T7 T8 T9 T10 T11 T12 Met Mast Map Reprod By Pe OSI SHEET I	Auced From Ordnance Su ermission Of The Governi CYAL50332198	233.5 204.1 232.1 192.6 239.7 247.6 194.8 161.4 166.4 114.5 107.6 76.8 185
T1 T2 T3 T4 T5 T6 T7 T8 T9 T10 T11 T12 Met Mast Map Reprod By Peter OSI SHEET 1 4562-D, P01 08.12.23	Auced From Ordnance Su ermission Of The Governi CYAL50332198 NO: 4622-A, 4622-C, 462 4621-B, 4562-C, 4562-A Issued For Planning	233.5 204.1 232.1 192.6 239.7 247.6 194.8 161.4 166.4 114.5 107.6 76.8 185 185 185 22-B, 4563-C, & 4562 JK PC
T1 T2 T3 T4 T5 T6 T7 T8 T9 T10 T11 T12 Met Mast Map Reprod By Pe OSI SHEET I 4562-D, P01 08.12.23 REV DATE PROJECT:	Auced From Ordnance Su Reversion of The Governic CYAL50332198 NO: 4622-A, 4622-C, 462 4621-B, 4562-C, 4562-A Issued For Planning DESCRIPTION	233.5 204.1 232.1 192.6 239.7 247.6 194.8 161.4 166.4 114.5 107.6 76.8 185 185 22-B, 4563-C, & 4562 JK PC
T1 T2 T3 T4 T5 T6 T7 T8 T9 T10 T11 T12 Met Mast Map Reproc By Pe OSI SHEET I 4562-D, PO1 08.12.23 REV DATE PROJECT: Ballycar Wind	Auced From Ordnance Su Reversion of The Governic CYAL50332198 NO: 4622-A, 4622-C, 462 4621-B, 4562-C, 4562-A Issued For Planning DESCRIPTION	233.5 204.1 232.1 192.6 239.7 247.6 194.8 161.4 166.4 114.5 107.6 76.8 185 185 22-B, 4563-C, & 4562 JK PC
T1 T2 T3 T4 T5 T6 T7 T8 T9 T10 T11 T12 Met Mast Map Reprod By Pe OSI SHEET I 4562-D, P01 08.12.23 REV DATE PROJECT:	Auced From Ordnance Su Primission Of The Governi CYAL50332198 NO: 4622-A, 4622-C, 462 4621-B, 4562-C, 4562-A Issued For Planning DESCRIPTION I Farm	233.5 204.1 232.1 192.6 239.7 247.6 194.8 161.4 166.4 114.5 107.6 76.8 185 185 22-B, 4563-C, & 4562 JK PC
T1 T2 T3 T4 T5 T6 T7 T8 T9 T10 T11 T12 Met Mast OSI SHEET I 4562-D, P01 08.12.23 REV DATE PROJECT: Ballycar Wind TITLE:	Auced From Ordnance Su Primission Of The Governi CYAL50332198 NO: 4622-A, 4622-C, 462 4621-B, 4562-C, 4562-A Issued For Planning DESCRIPTION I Farm	233.5 204.1 232.1 192.6 239.7 247.6 194.8 161.4 166.4 114.5 107.6 76.8 185 185 22-B, 4563-C, & 4562 JK PC
T1 T2 T3 T4 T5 T6 T7 T8 T9 T10 T11 T12 Met Mast Map Reproc By Pe OSI SHEET I 4562-D, P01 08.12.23 REV DATE PROJECT: Ballycar Wind TITLE: CLIENT:	Auced From Ordnance Su Primission Of The Governi CYAL50332198 NO: 4622-A, 4622-C, 462 4621-B, 4562-C, 4562-A Issued For Planning DESCRIPTION I Farm	233.5 204.1 232.1 192.6 239.7 247.6 194.8 161.4 166.4 114.5 107.6 76.8 185 185 22-B, 4563-C, & 4562 JK PC
T1 T2 T3 T4 T5 T6 T7 T8 T9 T10 T11 T12 Met Mast OSI SHEET I 4562-D, P01 08.12.23 REV DATE PROJECT: Ballycar Wind TITLE: Site Layout - CLIENT:	Auced From Ordnance Su Primission Of The Governi CYAL50332198 NO: 4622-A, 4622-C, 462 4621-B, 4562-C, 4562-A Issued For Planning DESCRIPTION I Farm	233.5 204.1 232.1 192.6 239.7 247.6 194.8 161.4 166.4 114.5 107.6 76.8 185 185 22-B, 4563-C, & 4562 JK PC
T1 T2 T3 T4 T5 T6 T7 T8 T9 T10 T11 T12 Met Mast OSI SHEET I 4562-D, P01 08.12.23 REV DATE PROJECT: Ballycar Wind TITLE: Site Layout - CLIENT: SALLYCAR Green Energy	Auced From Ordnance Su No: 4622-A, 4622-C, 462 4621-B, 4562-C, 4562-A Issued For Planning DESCRIPTION I Farm Sheet 9	233.5 204.1 232.1 192.6 239.7 247.6 194.8 161.4 166.4 114.5 107.6 76.8 185 185 22-B, 4563-C, 3 & 4562 JK PC BY APP
T1 T2 T3 T4 T5 T6 T7 T8 T9 T10 T11 T12 Met Mast OSI SHEET I 4562-D, P01 08.12.23 REV DATE PROJECT: Ballycar Wind TITLE: CLIENT: Site Layout - CLIENT: FALLYCAR OSI SHEET I 4562-D,	Auced From Ordnance Su Provide From Ordnanc	233.5 204.1 232.1 192.6 239.7 247.6 194.8 161.4 166.4 114.5 107.6 76.8 185 185 185 Xerrey Ireland ment. 22-B, 4563-C, 8 4562 JK PC BY APP
T1 T2 T3 T4 T5 T6 T7 T8 T9 T10 T11 T12 Met Mast OSI SHEET I 4562-D, P01 08.12.23 REV DATE PROJECT: Ballycar Wind TITLE: CLIENT: Site Layout - CLIENT: FALLYCAR OSI SHEET I 4562-D,	Auced From Ordnance Su No: 4622-A, 4622-C, 462 4621-B, 4562-C, 4562-A Issued For Planning DESCRIPTION I Farm Sheet 9	233.5 204.1 232.1 192.6 239.7 247.6 194.8 161.4 166.4 114.5 107.6 76.8 185 185 76.8 185 185 185 185 185 185 185 185 185 18
T1 T2 T3 T4 T5 T6 T7 T8 T9 T10 T11 T12 Met Mast OSI SHEET I 4562-D, P01 08.12.23 REV DATE PROJECT: Ballycar Wind TITLE: Site Layout - CLIENT: ENGINEERING / CORK DRAWN: I	AND ENVIRONMENTAL TRALEE	233.5 204.1 232.1 192.6 239.7 247.6 194.8 161.4 166.4 114.5 107.6 76.8 185 185 22-B, 4563-C, 3-8 4562 JK PC BY APP BY APP APPROVED:
Т1 Т2 Т3 Т4 Т5 Т6 Т7 Т7 Т8 Т9 Т10 Т11 Т12 Мет Mast Мар Reprod Ву Рес ОSI SHEET I 4562-D, Р01 08.12.23 REV DATE PROJECT: Ballycar Wind TITLE: Site Layout - CLIENT: CLI	AND ENVIRONMENTAL TRALEE	233.5 204.1 232.1 192.6 239.7 247.6 194.8 161.4 166.4 114.5 107.6 76.8 185 185 Treey Ireland ment. 22-B, 4563-C, 3 & 4562 JK PC BY APP BY APP
T1 T2 T3 T4 T5 T6 T7 T8 T9 T10 T11 T12 Met Mast Map Reprod By Peter OSI SHEET I 4562-D, P01 08.12.23 REV DATE PROJECT: Ballycar Wind TITLE: Site Layout - CLIENT: ENGINEERING CUIENT: JK	AND ENVIRONMENTAL TRALEE PC	233.5 204.1 232.1 192.6 239.7 247.6 194.8 161.4 166.4 114.5 107.6 76.8 185 185 Very Ireland ment. 22-B, 4563-C, & 4562 JK PC BY APP BY APP APPROVED: OH
T1 T2 T3 T4 T5 T6 T7 T8 T9 T10 T11 T12 Met Mast Map Reproc By Pe OSI SHEET I 4562-D, P01 08.12.23 REV DATE PROJECT: Ballycar Wind TITLE: Site Layout - CLIENT: Site Layout - CLIENT: BALLYCAR DRAWN: JK JK PROJECT NUMBER: JK PROJECT NUMBER: Z2156 STATUS DESCRIPTION	AVD ENVIRONMENTAL TRALEE LONDON	233.5 204.1 232.1 192.6 239.7 247.6 194.8 161.4 166.4 114.5 107.6 76.8 185 185 185 185 228, 4563-C, & 4562 JK PC BY APP APP APP SCALE @ A1: 1 : 1,000

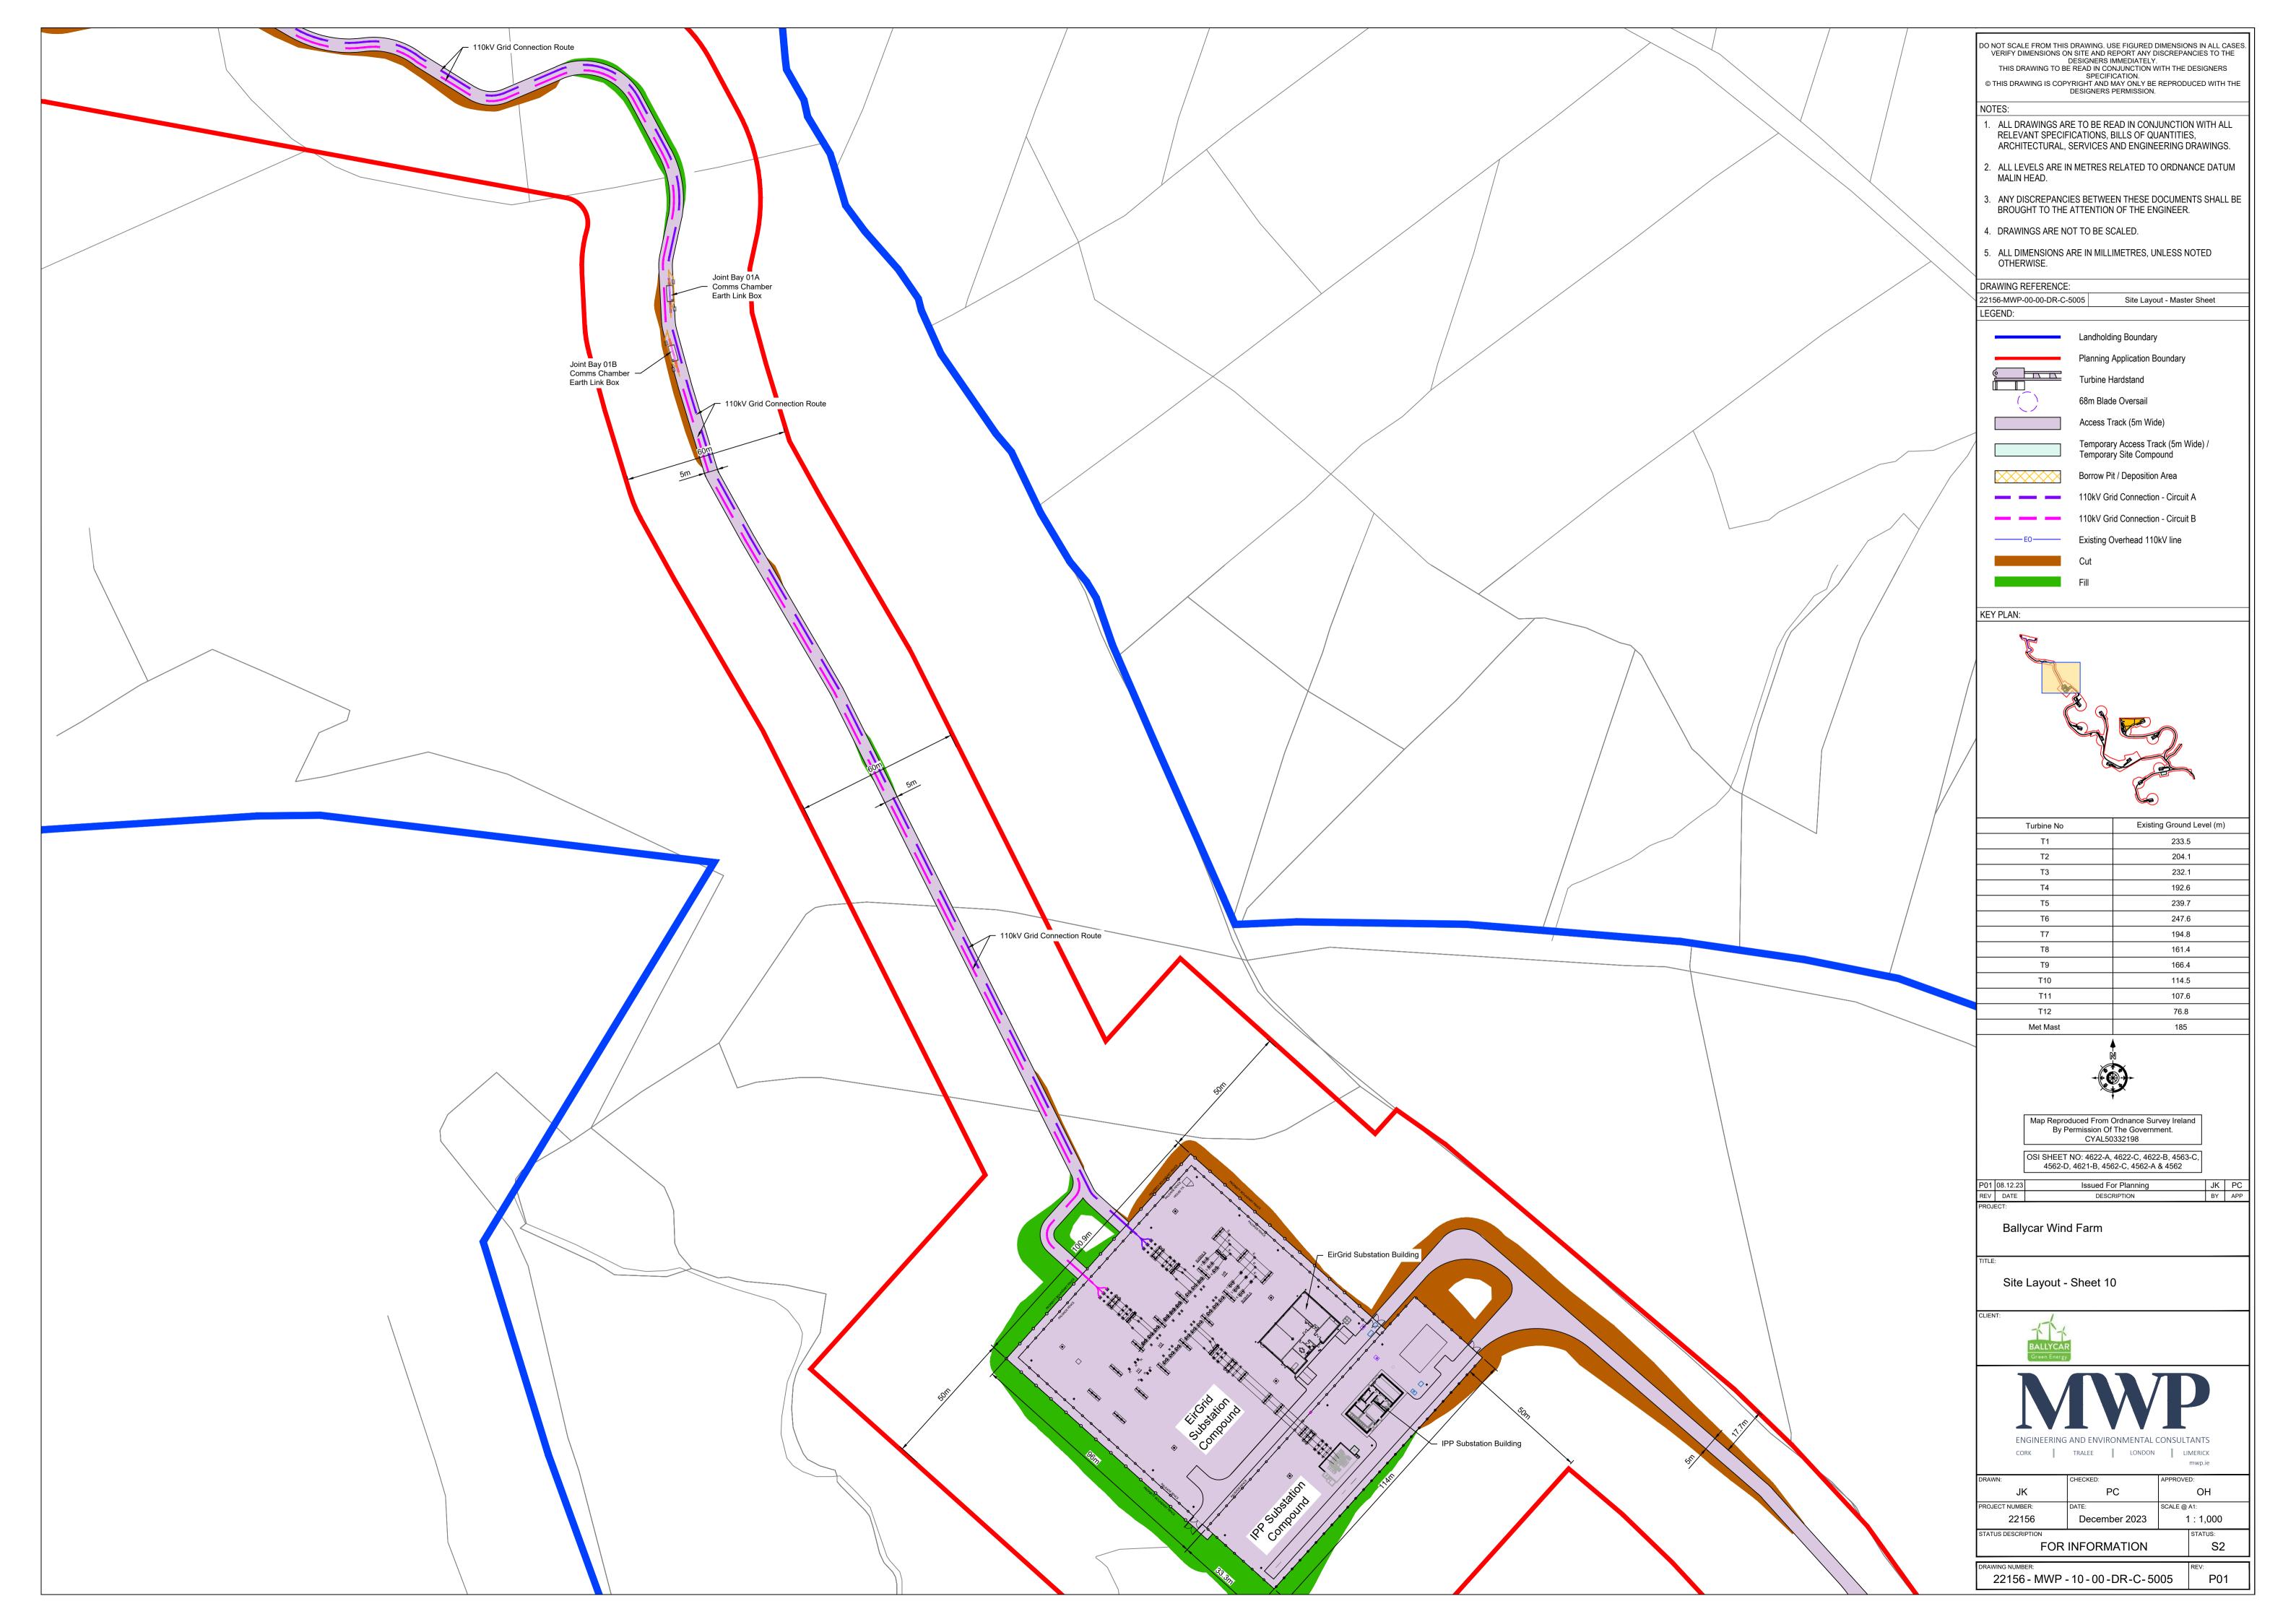


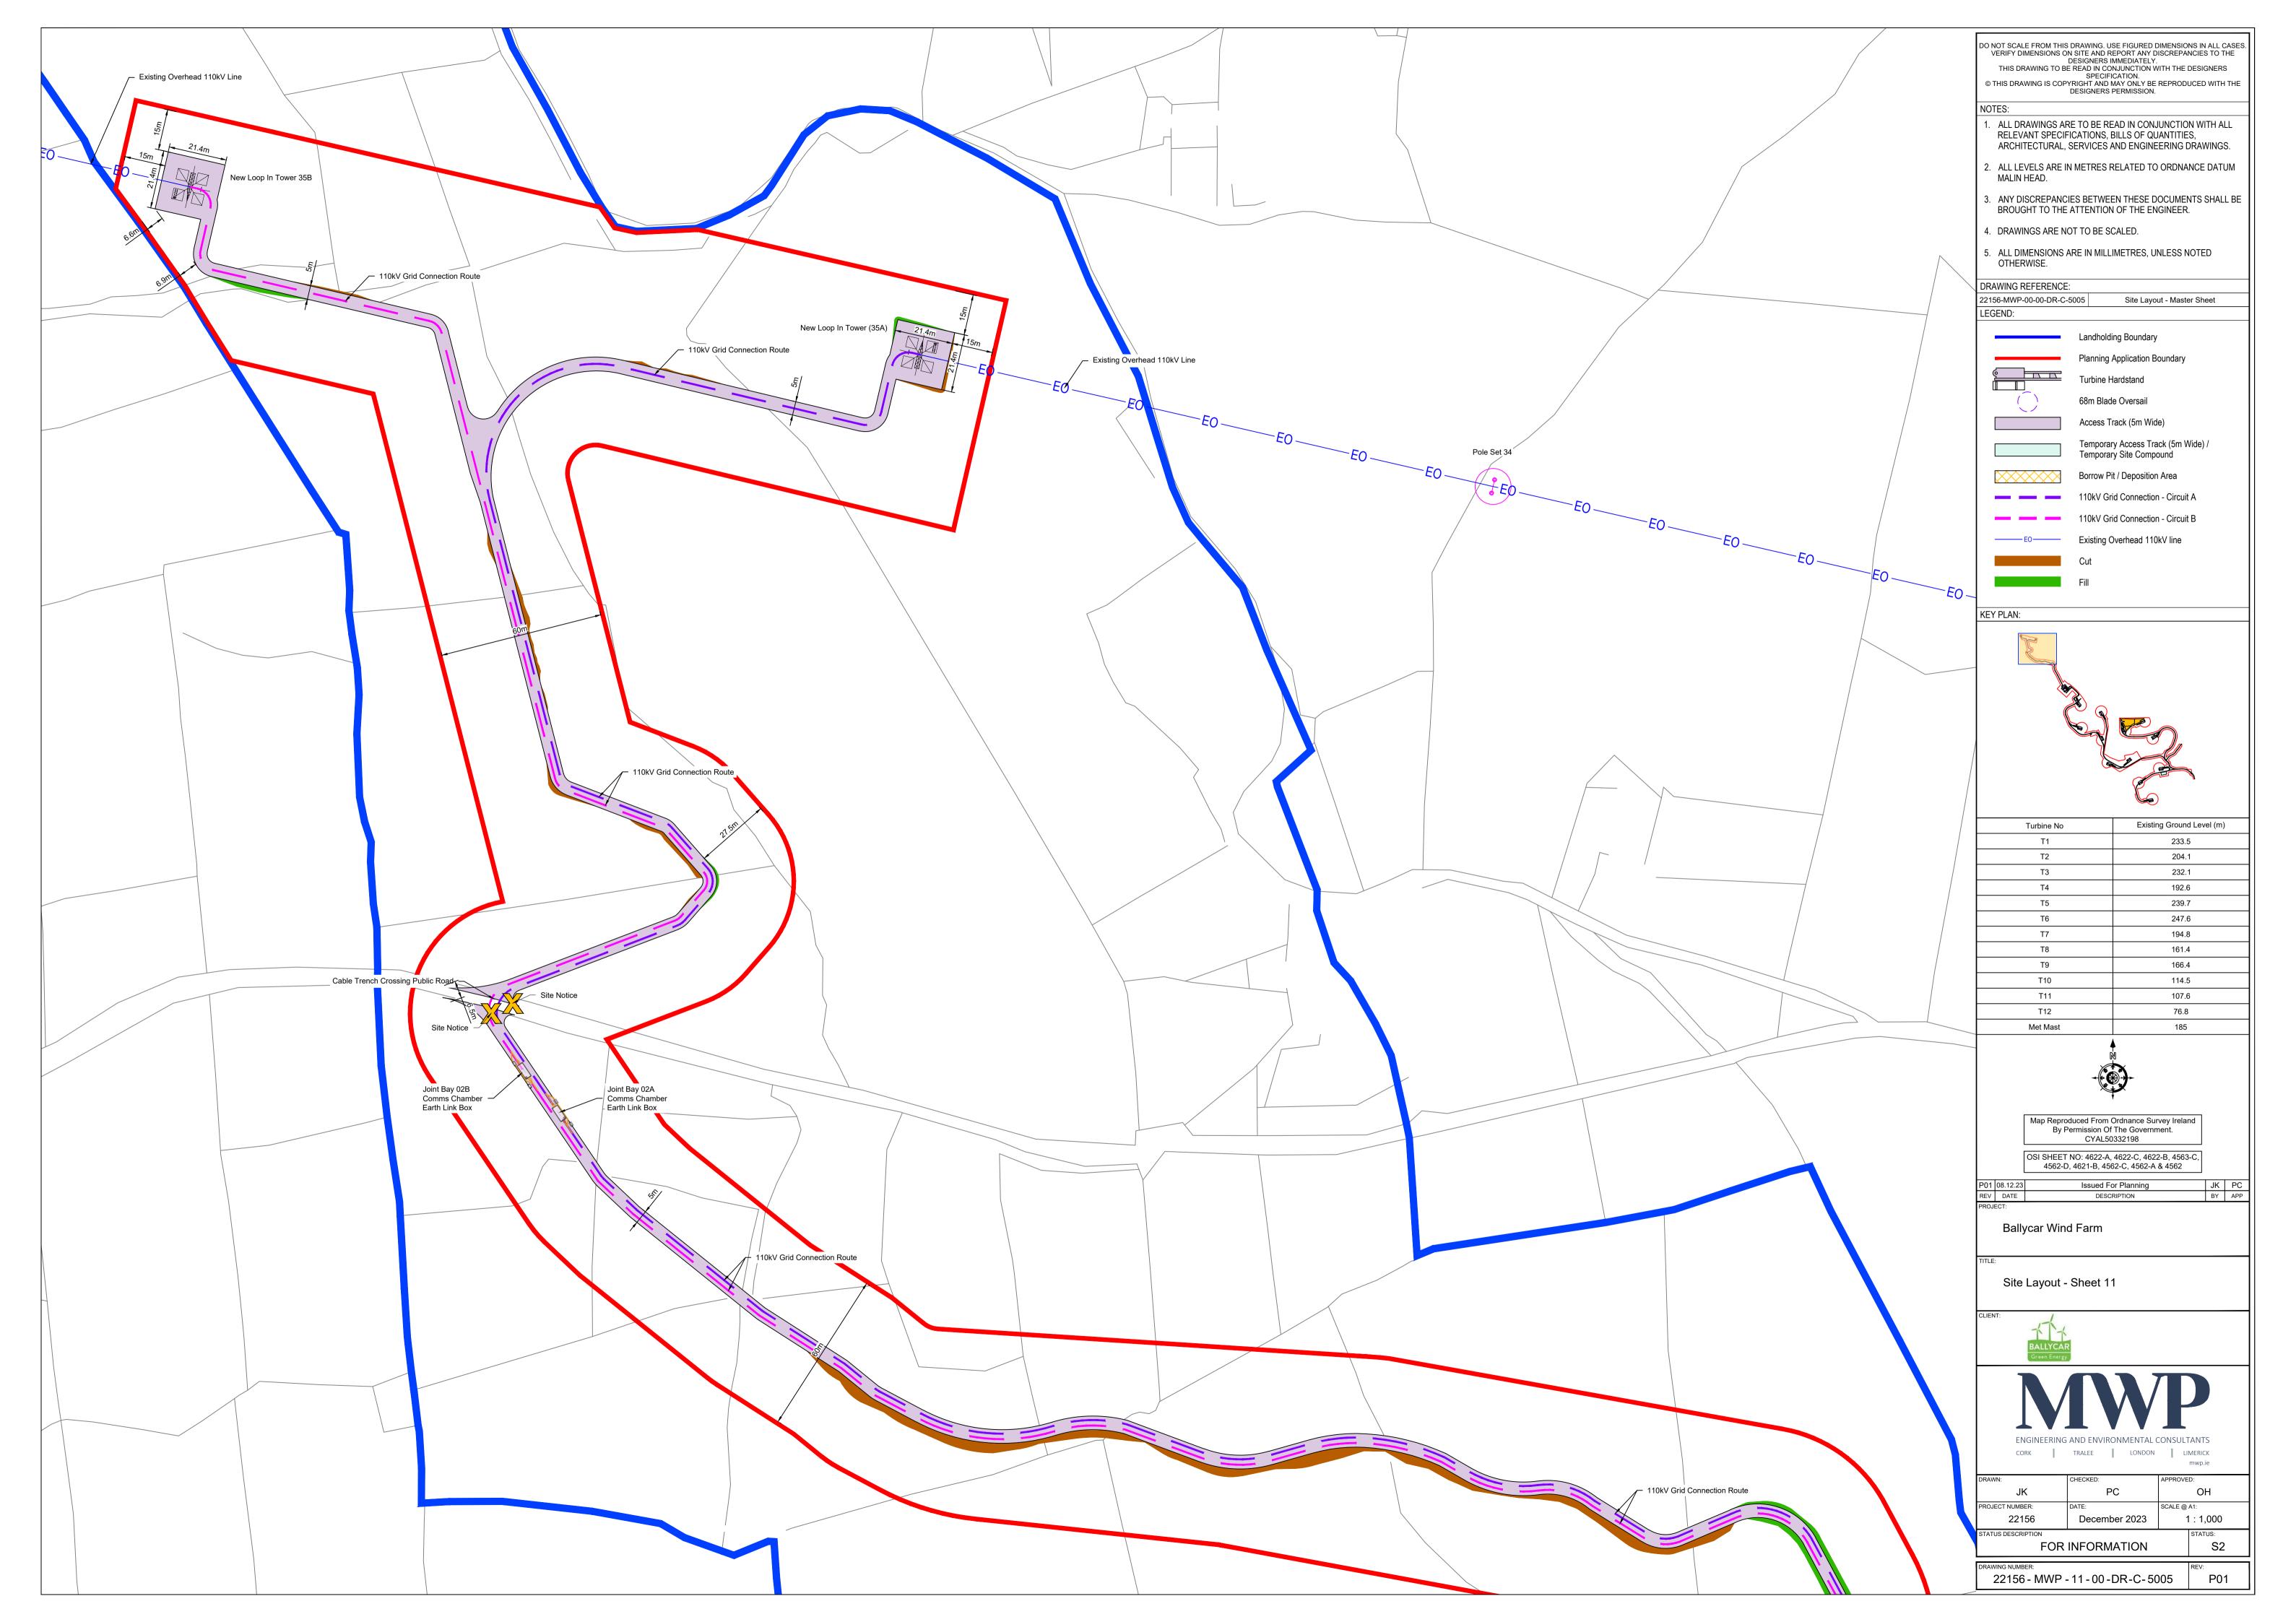


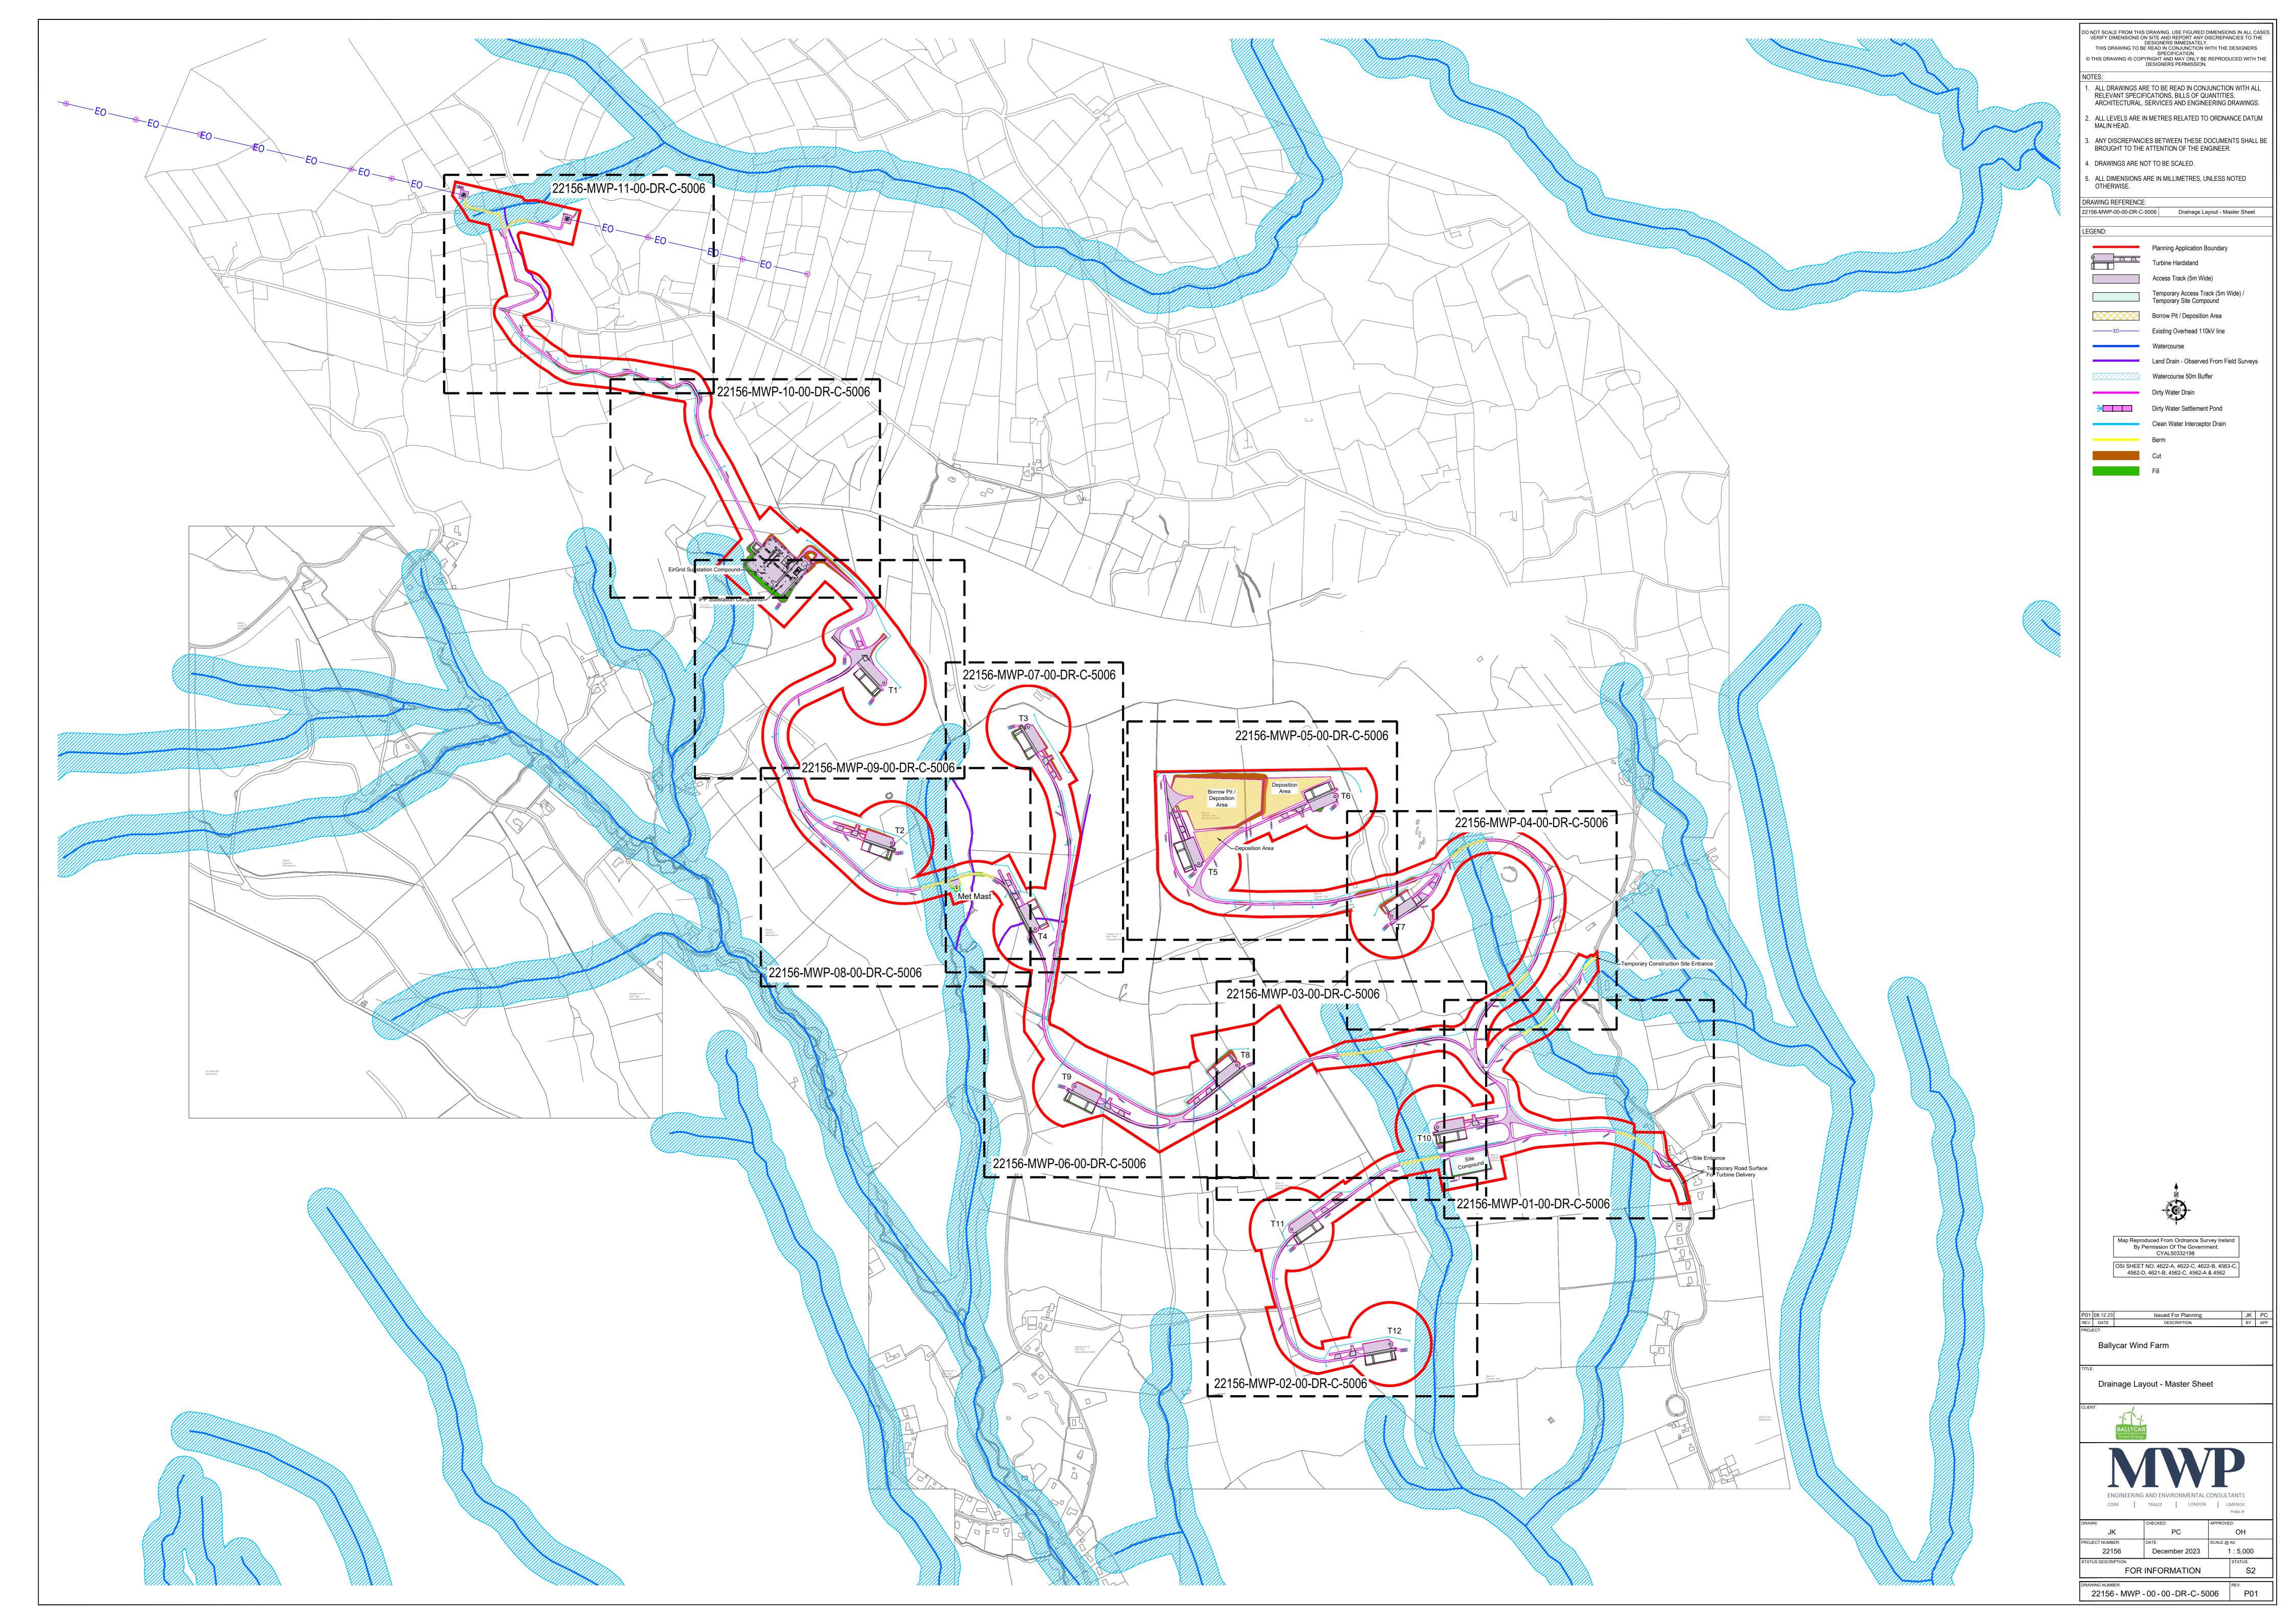


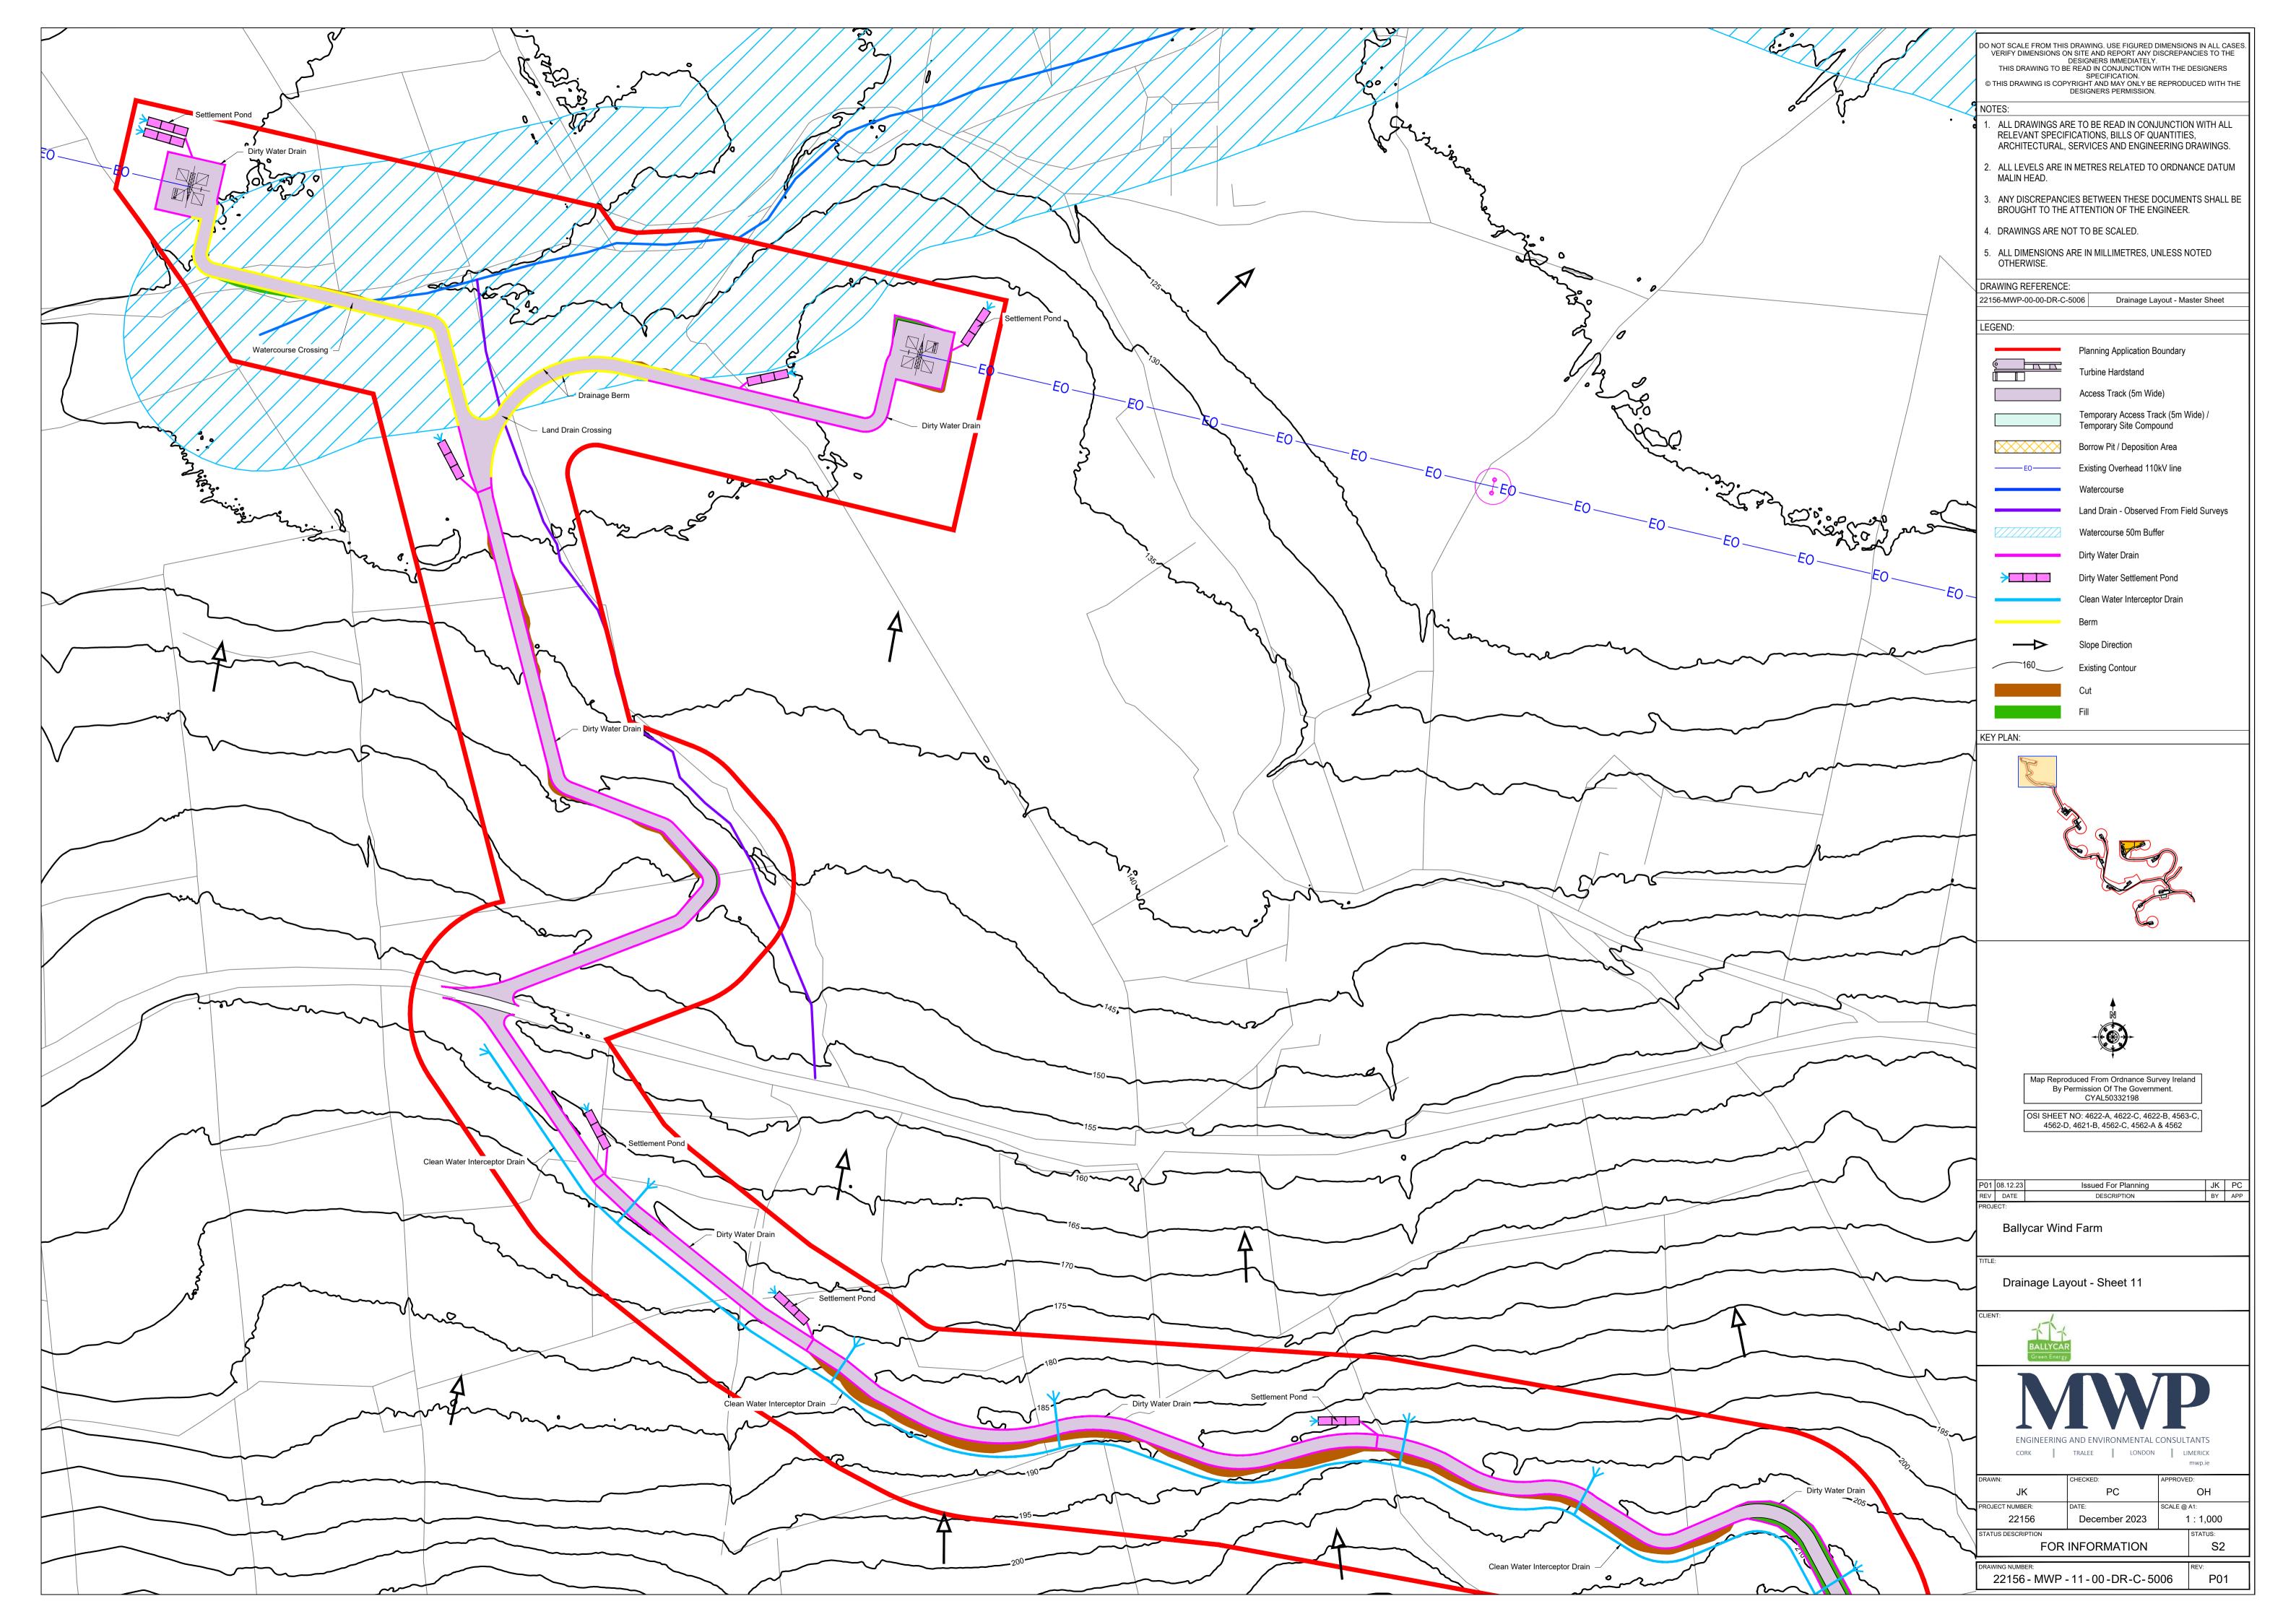


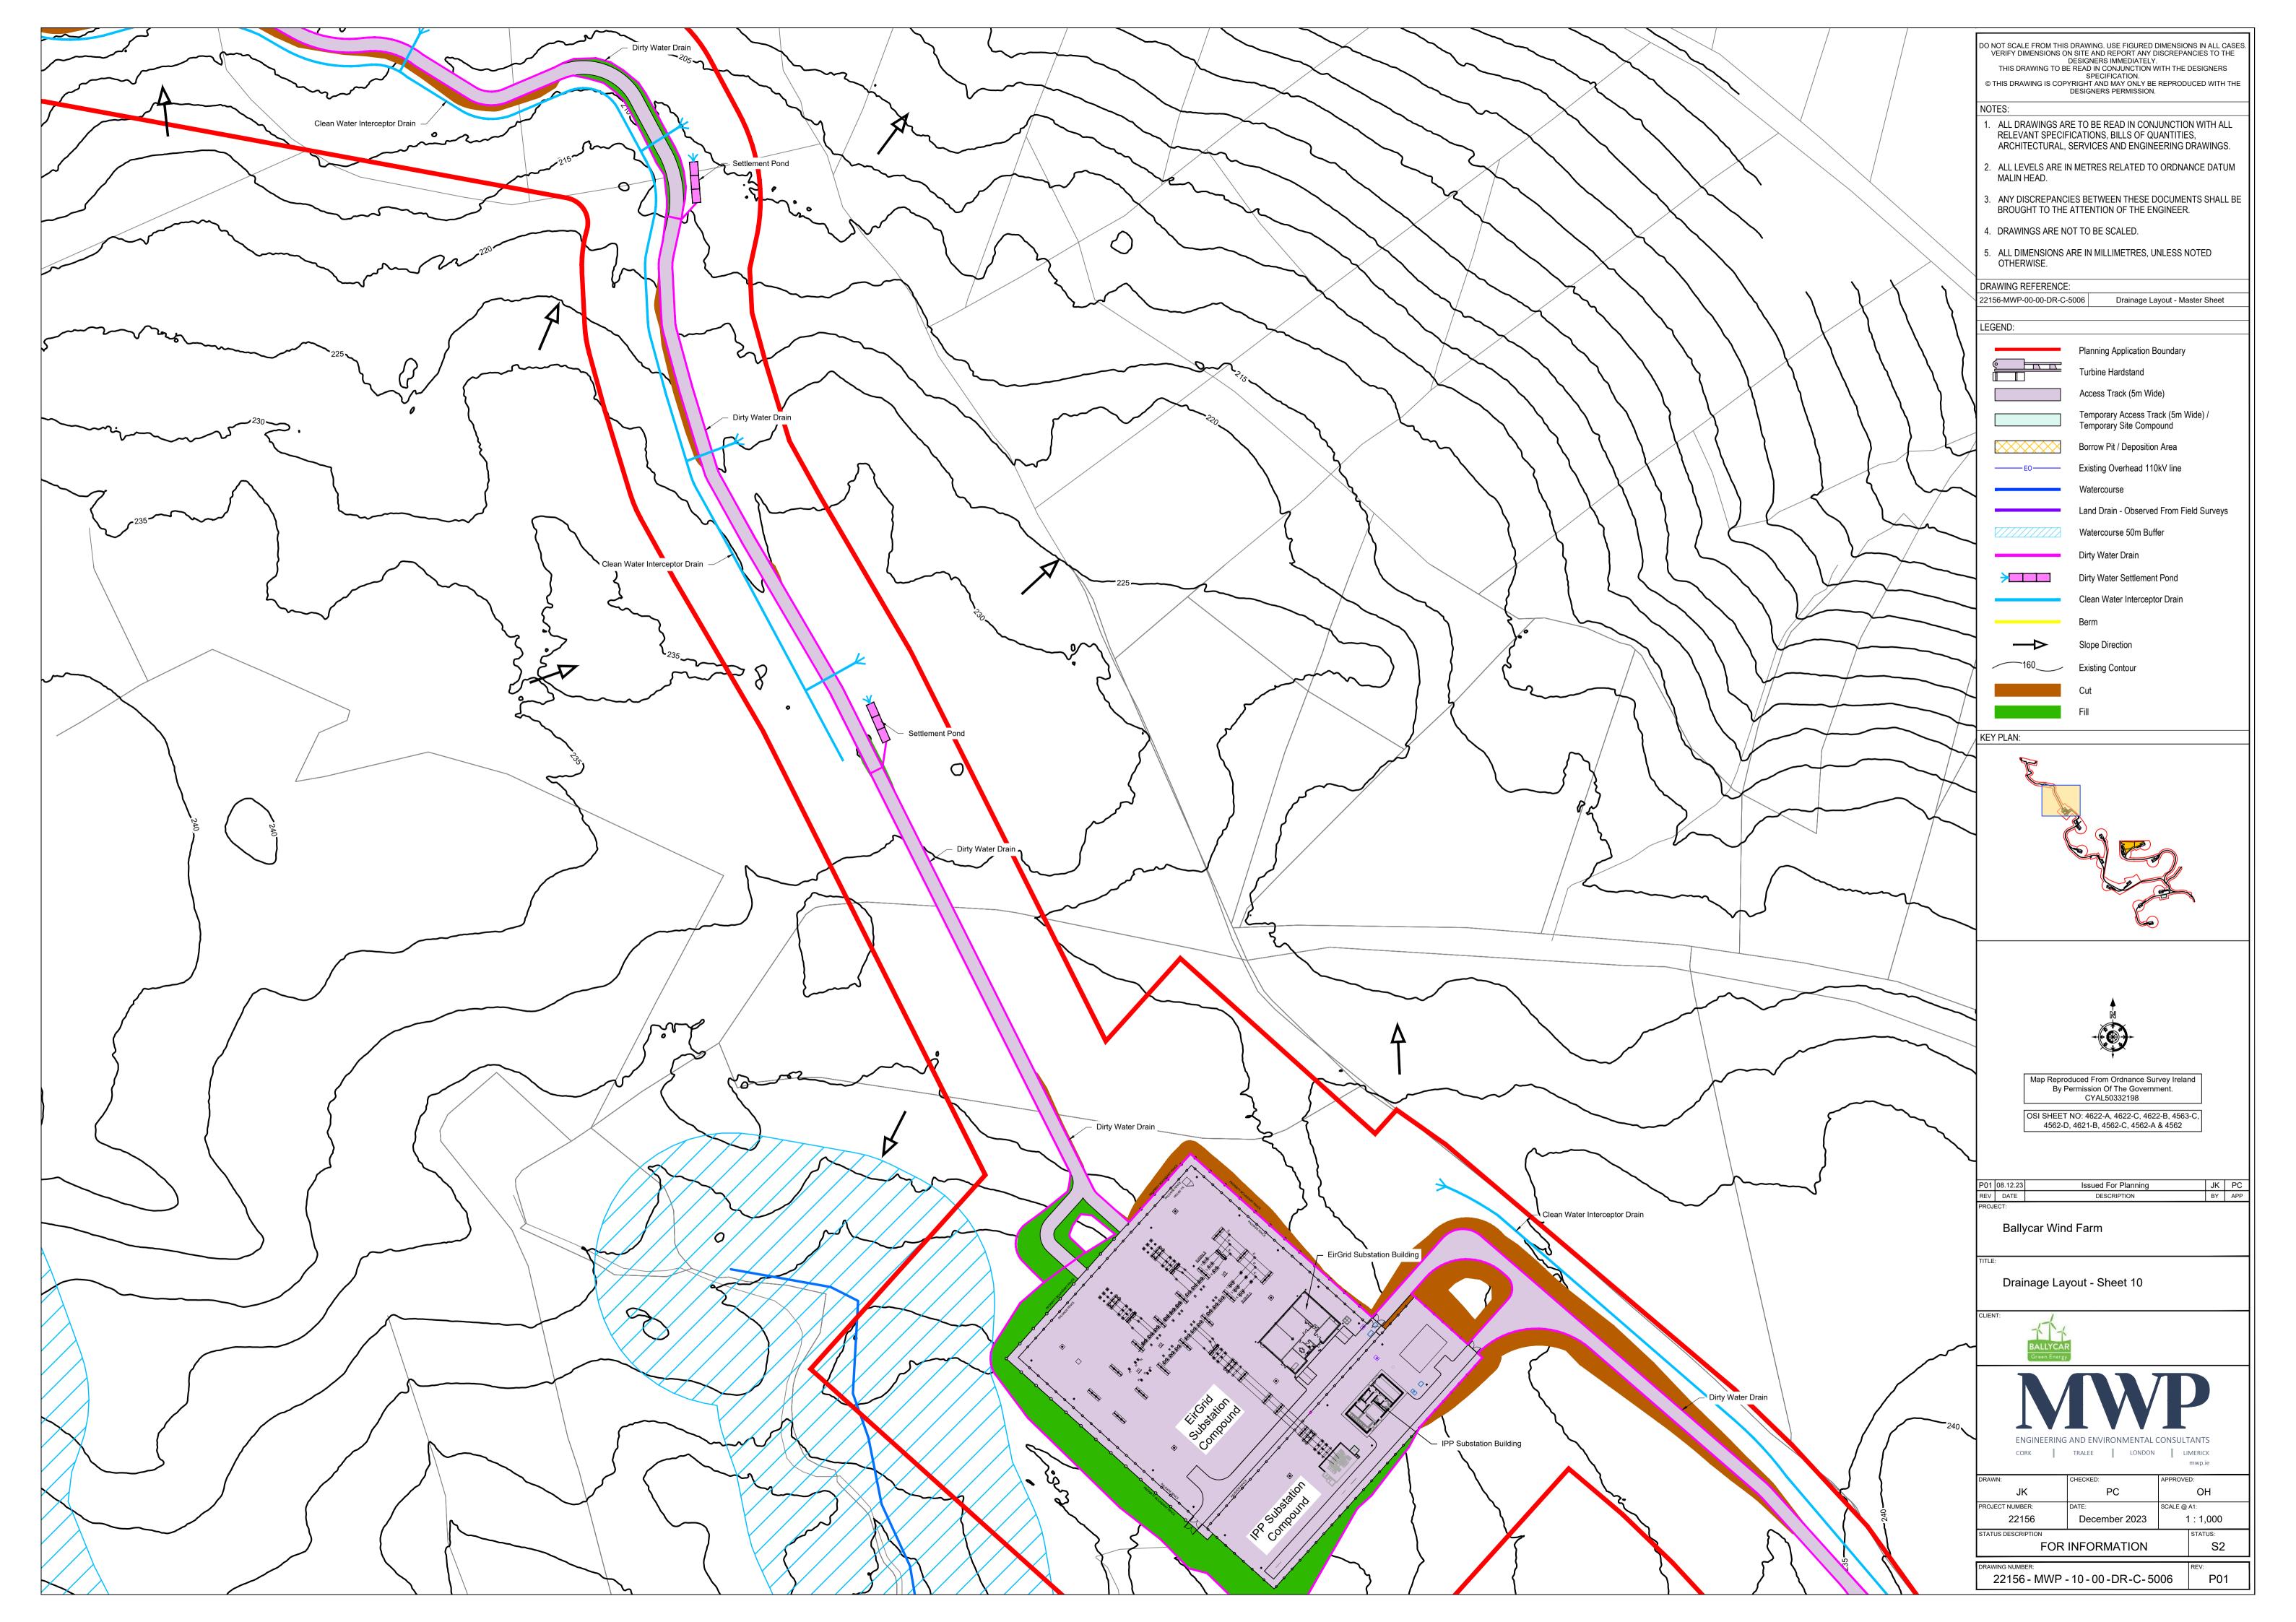


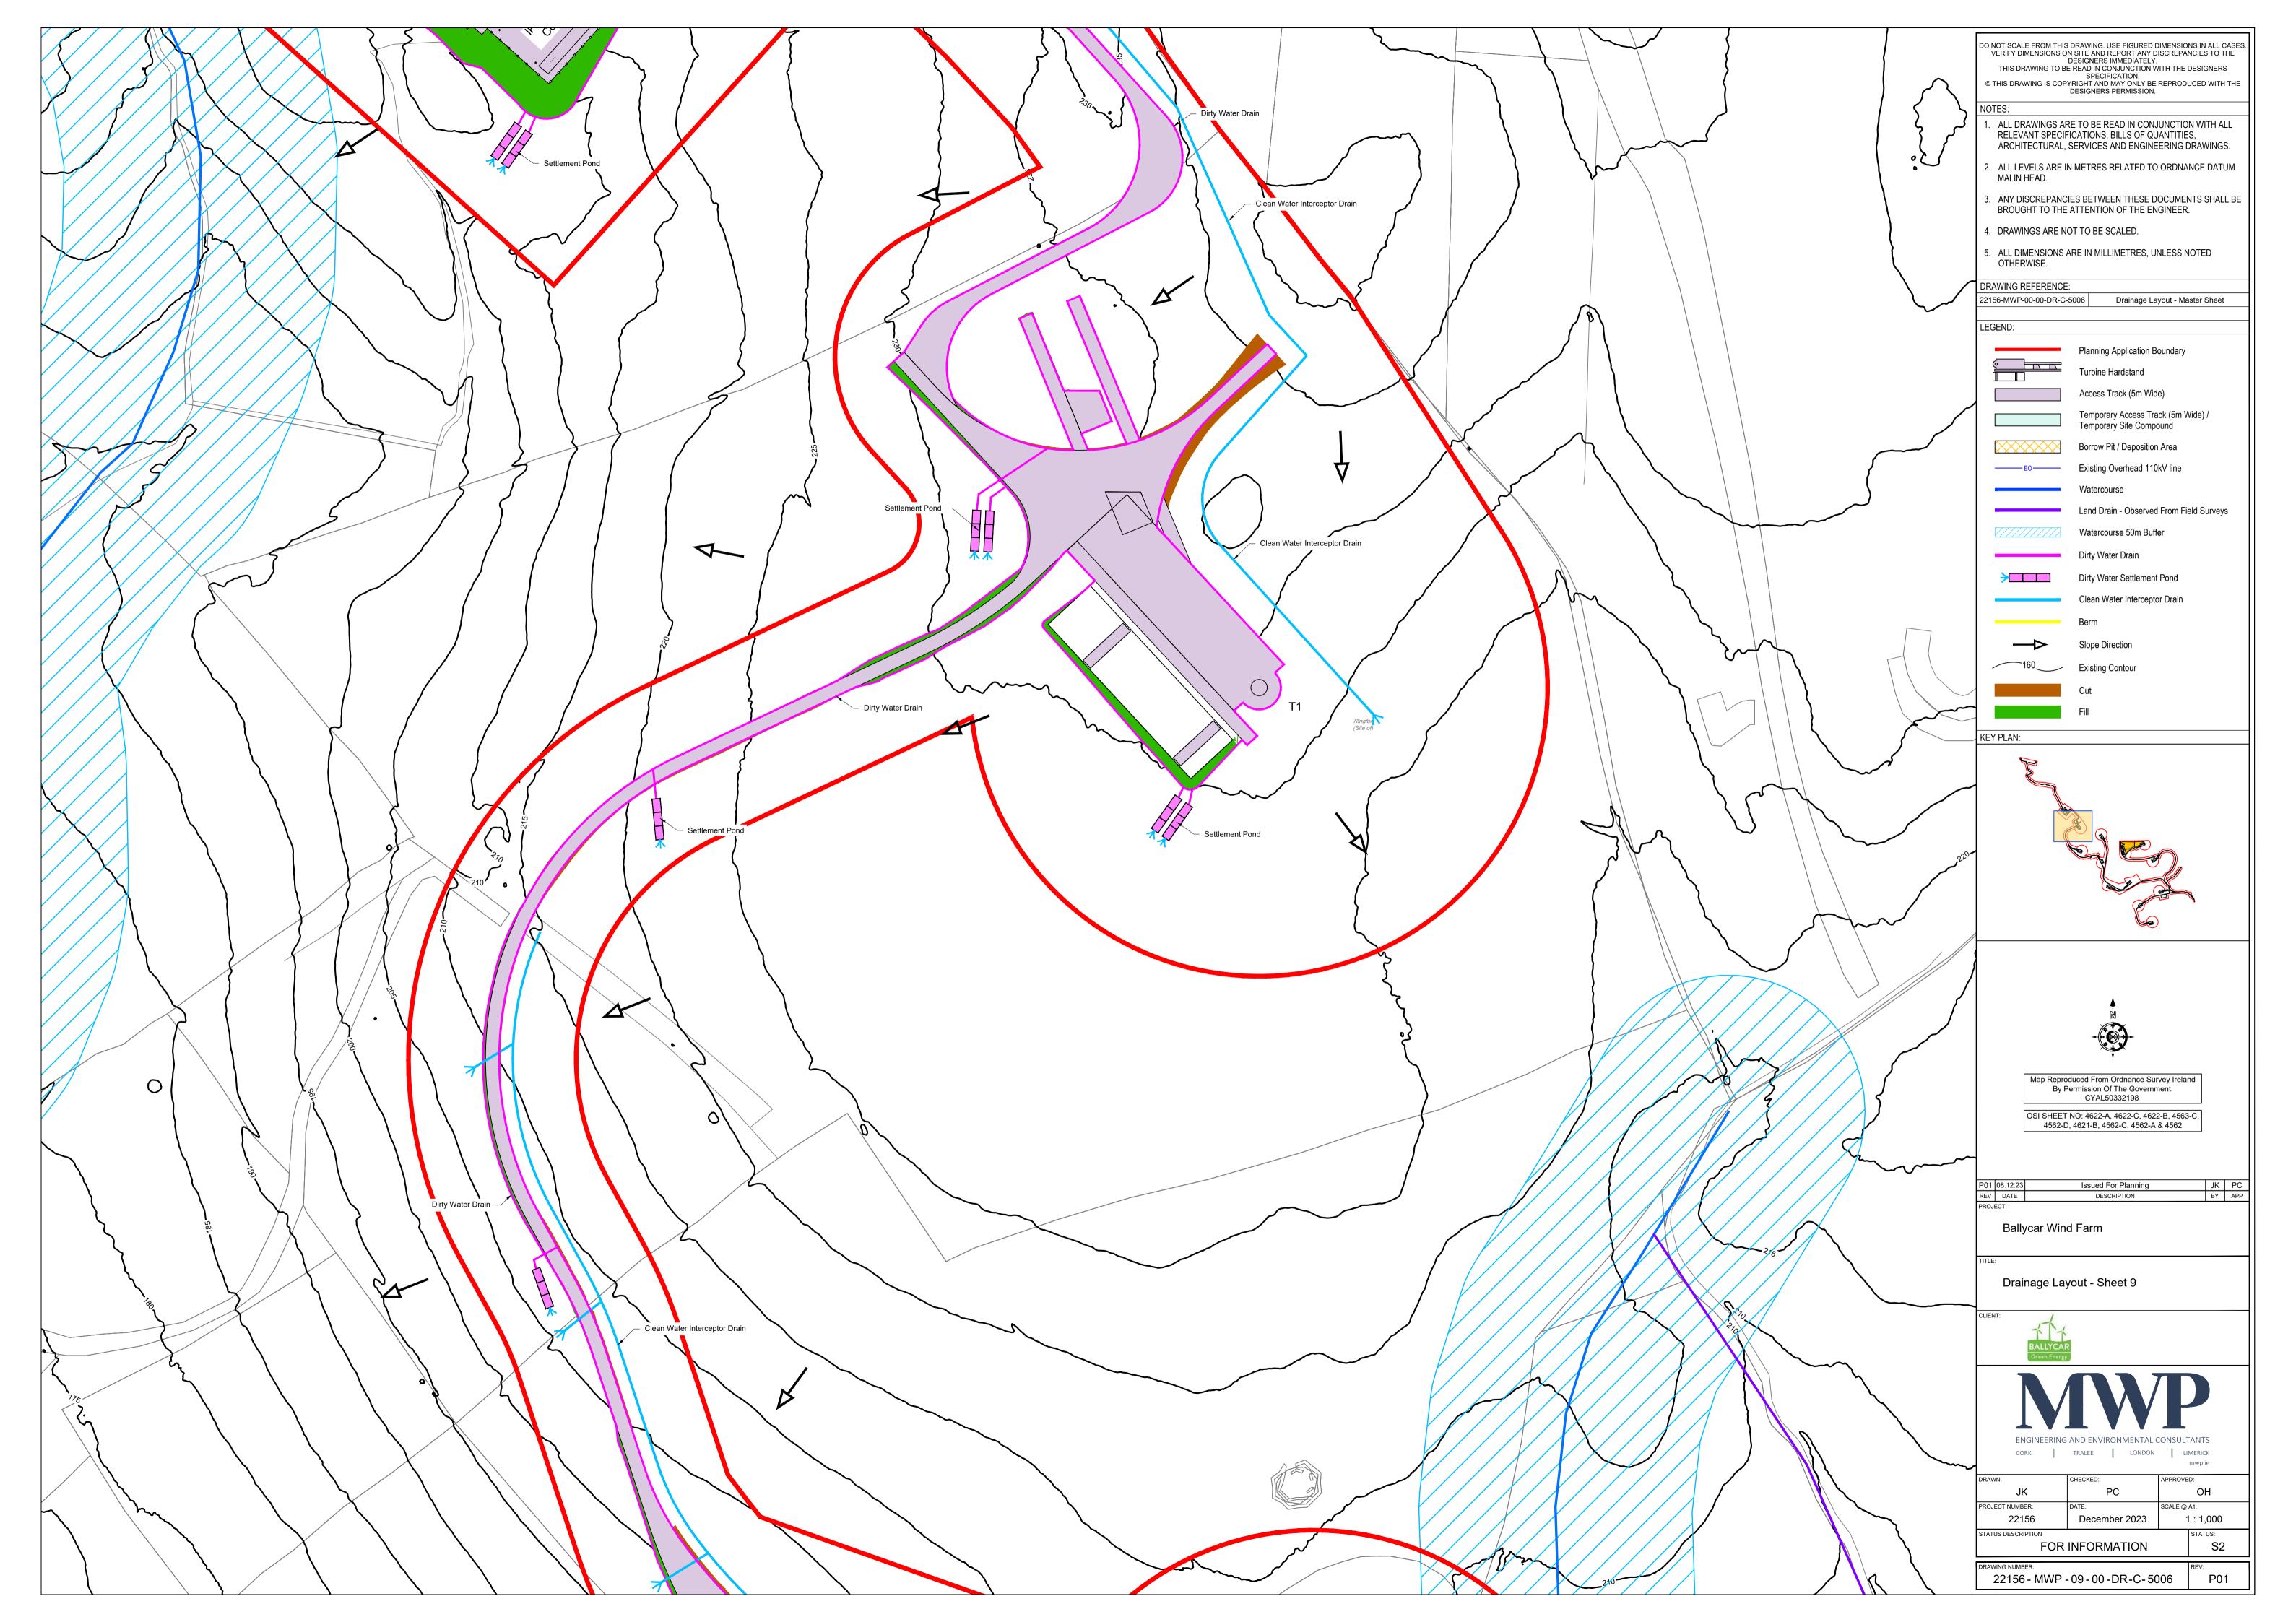


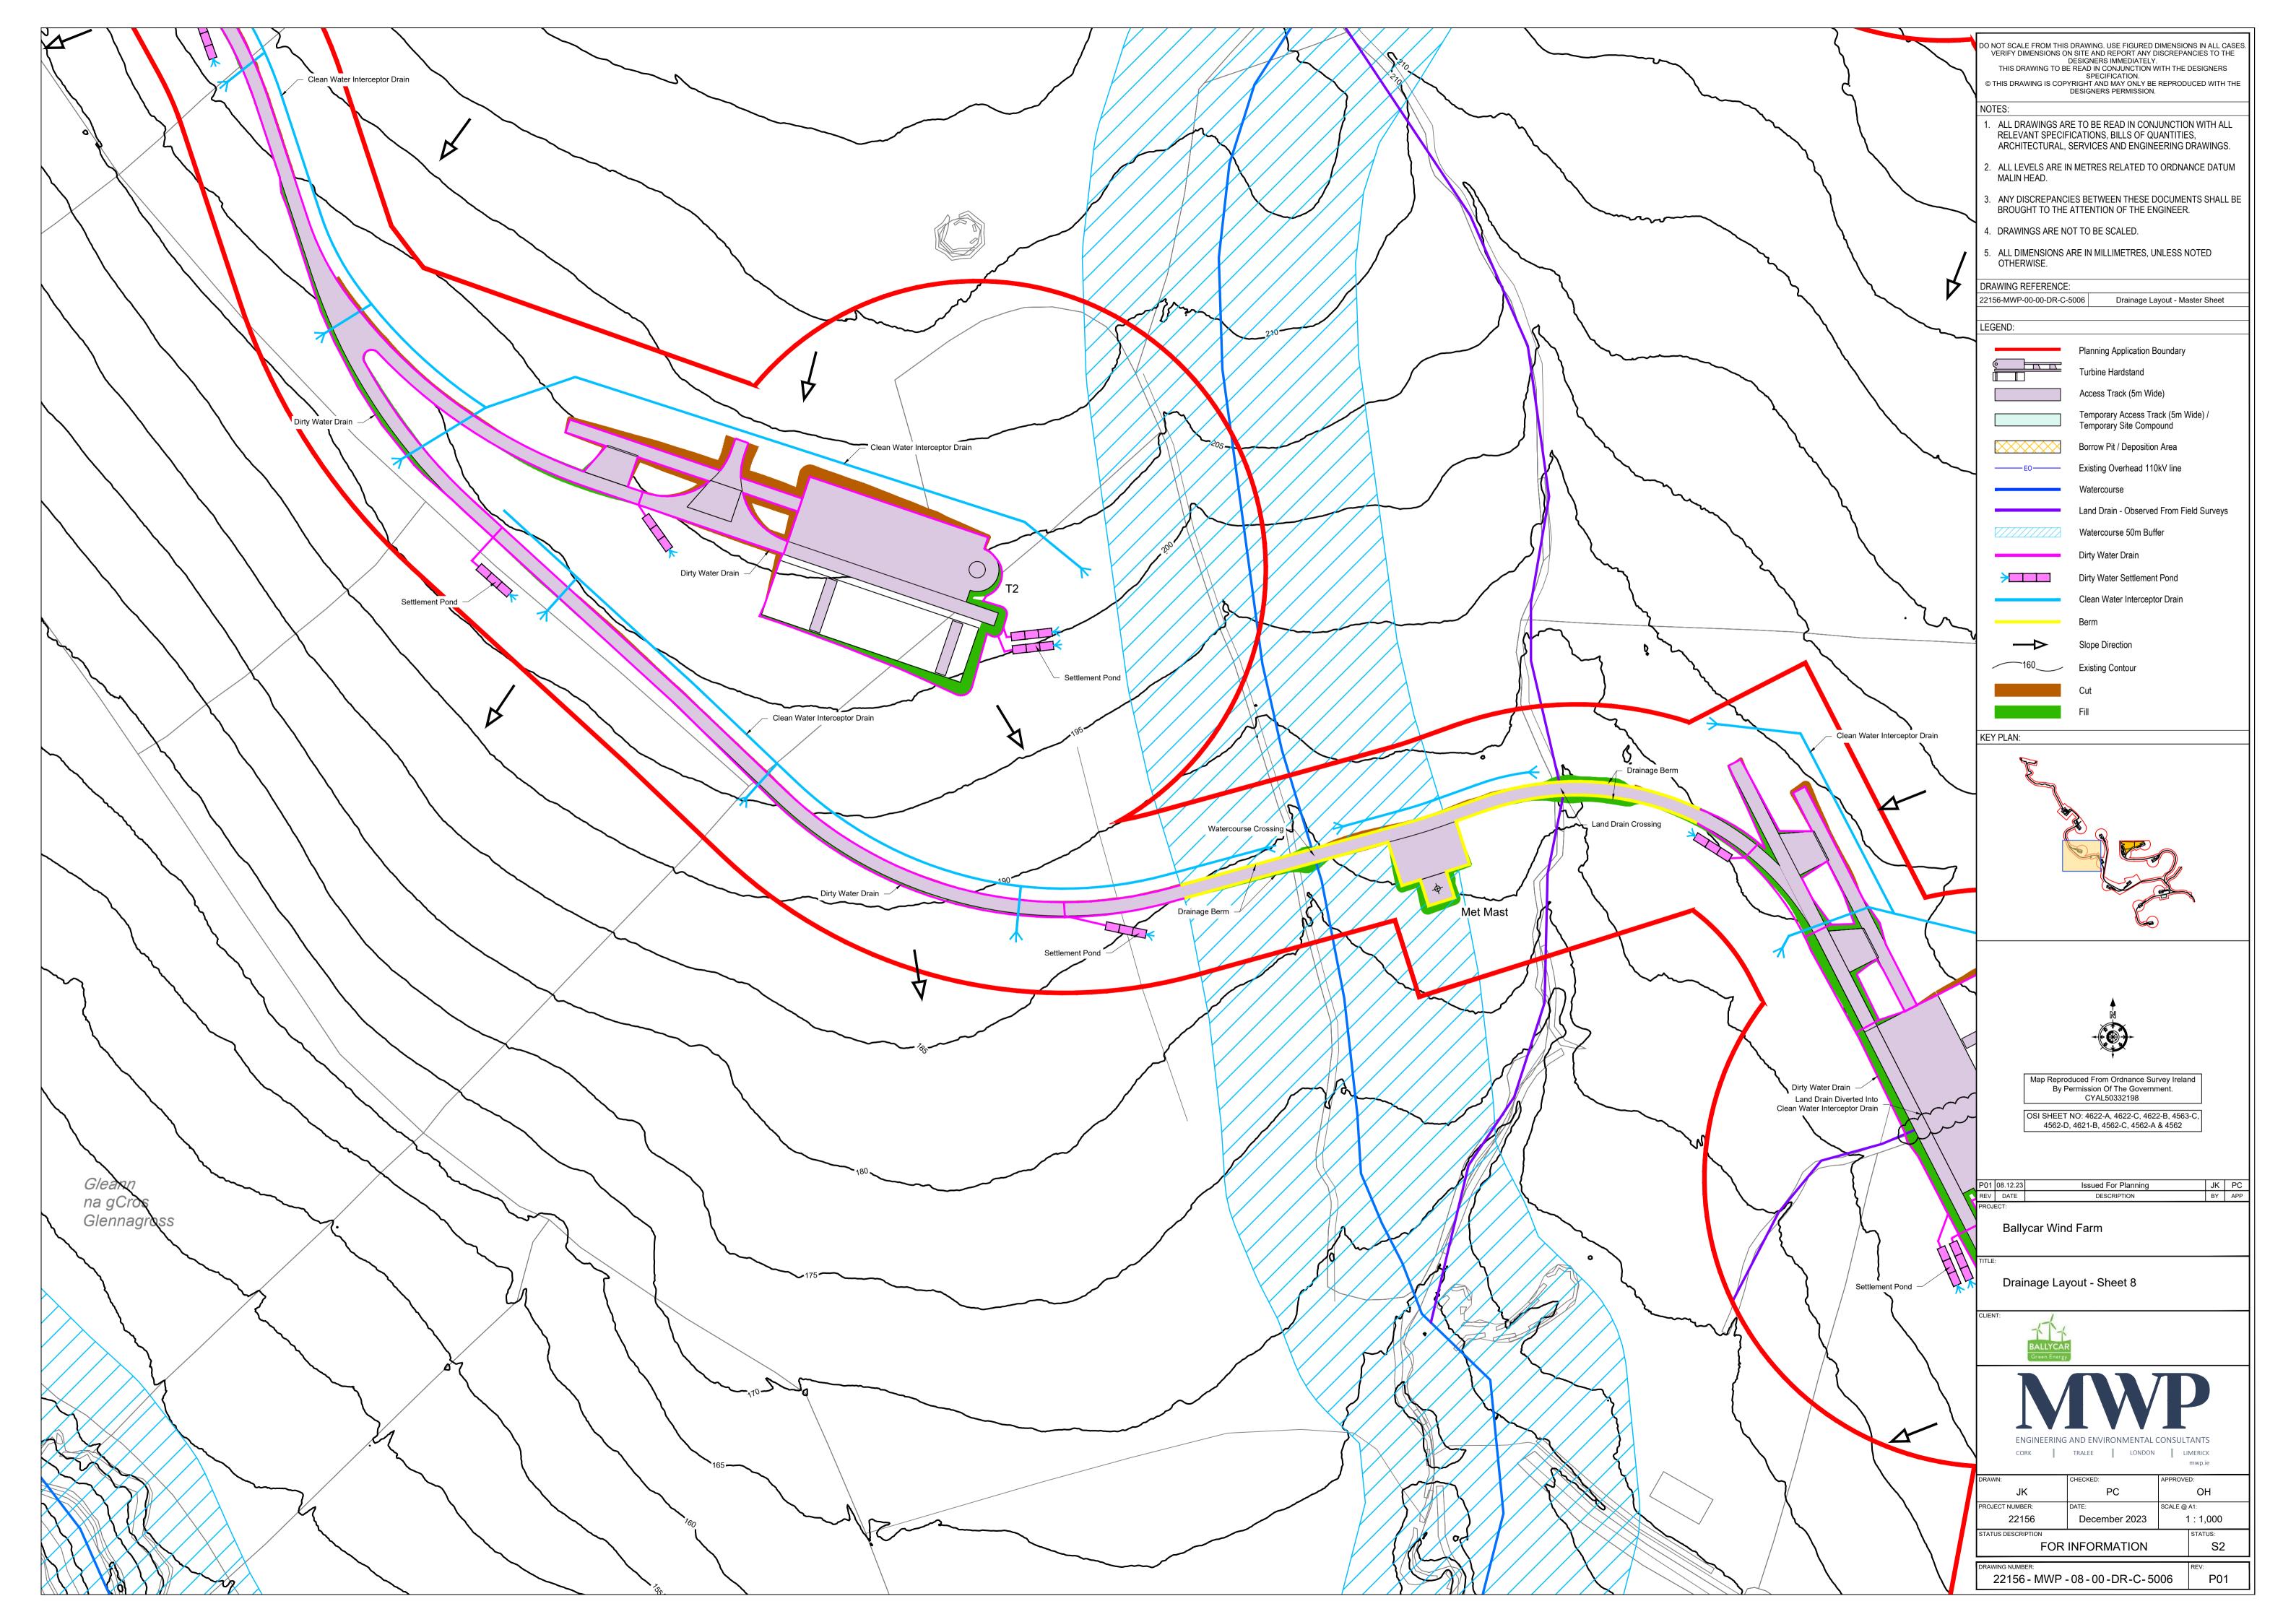


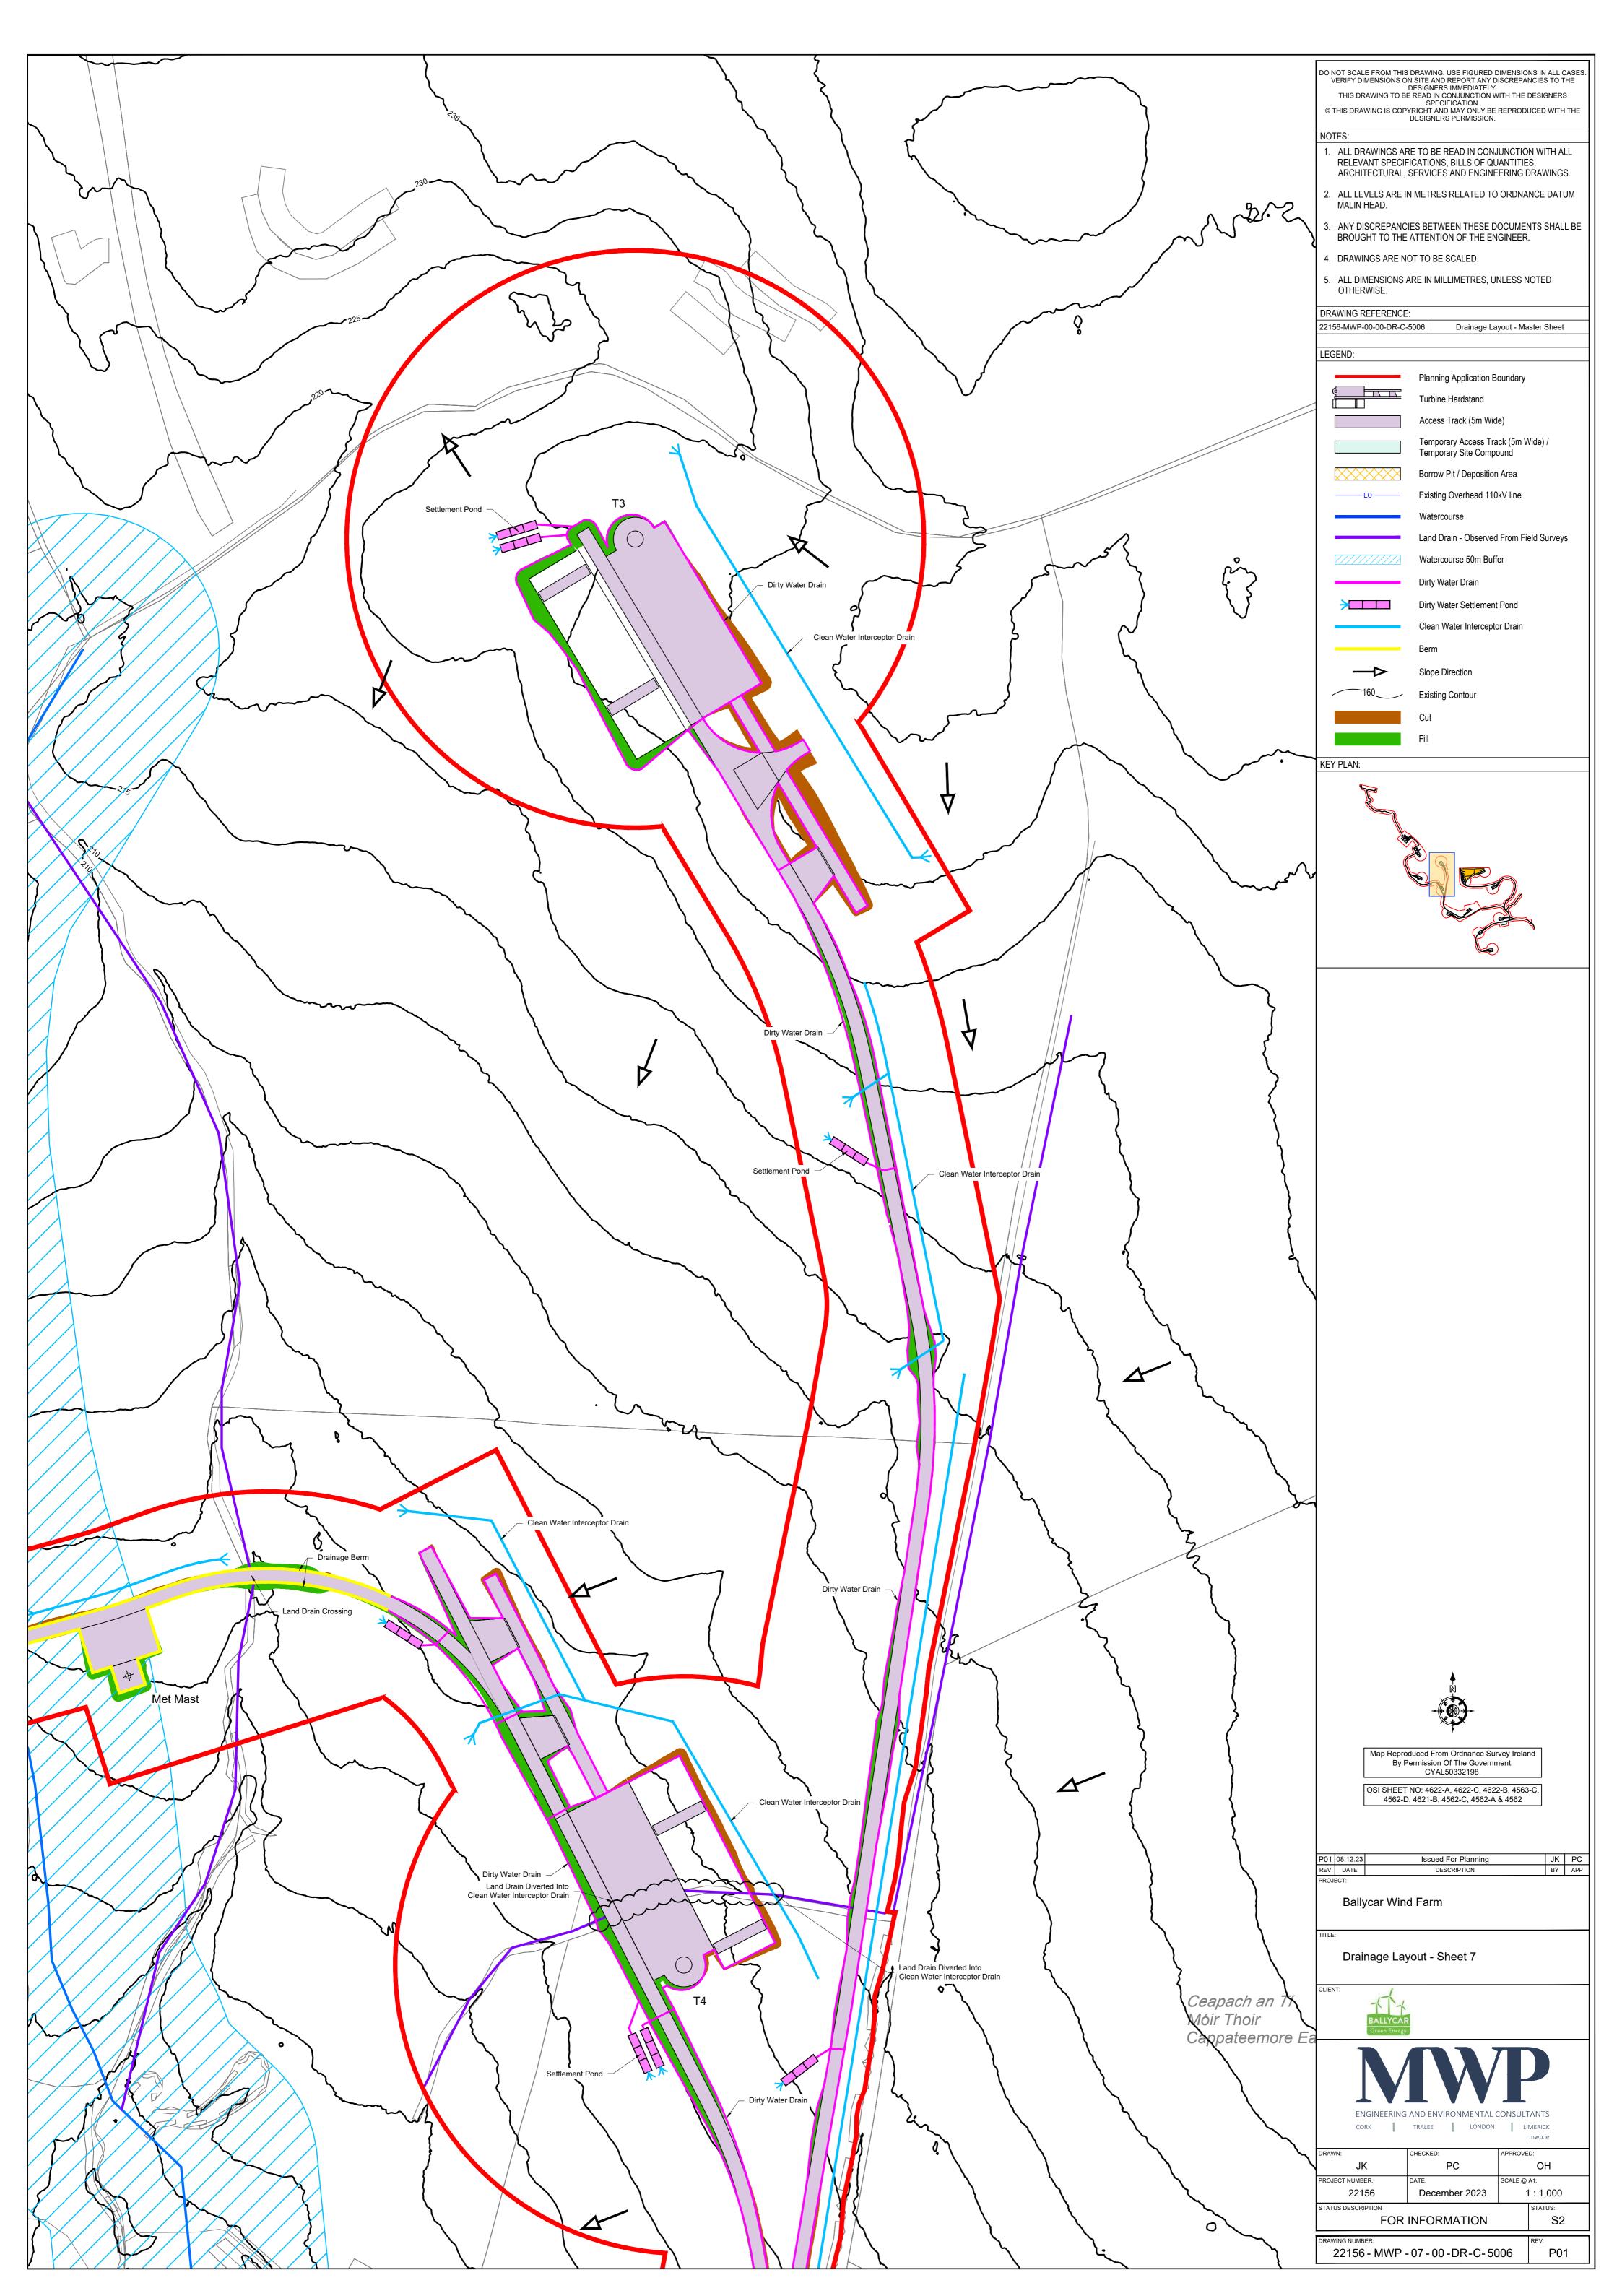


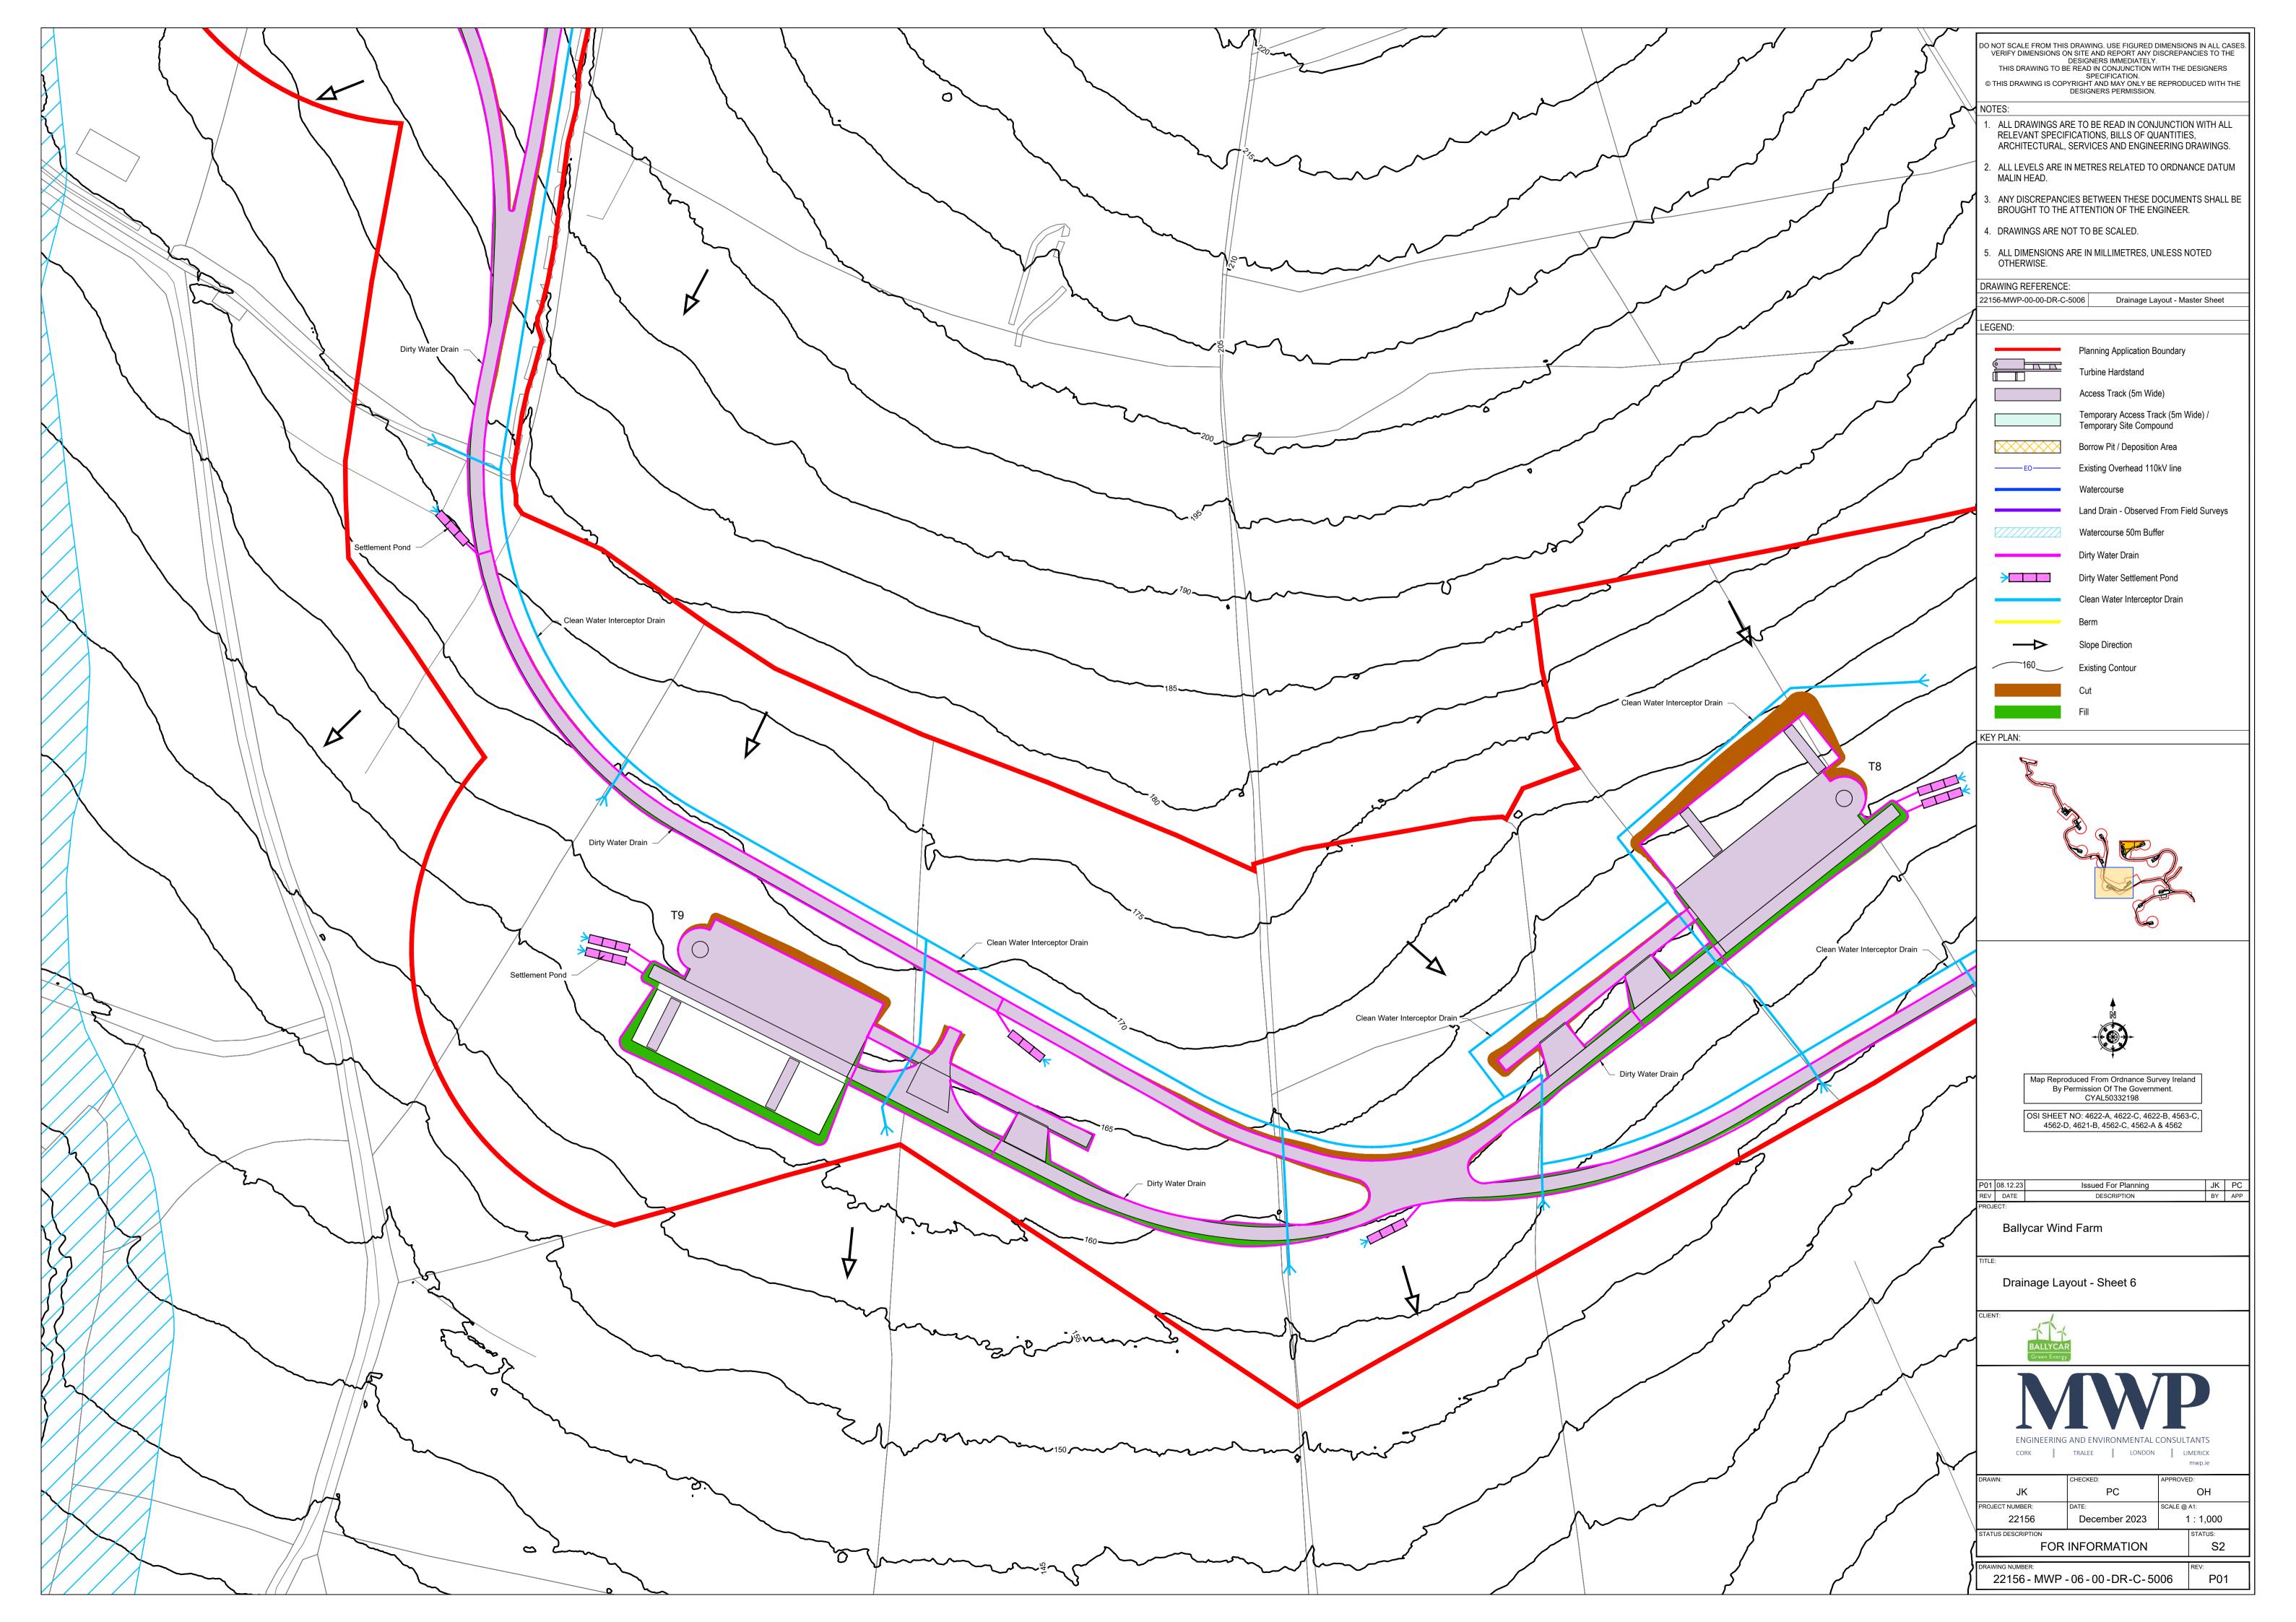


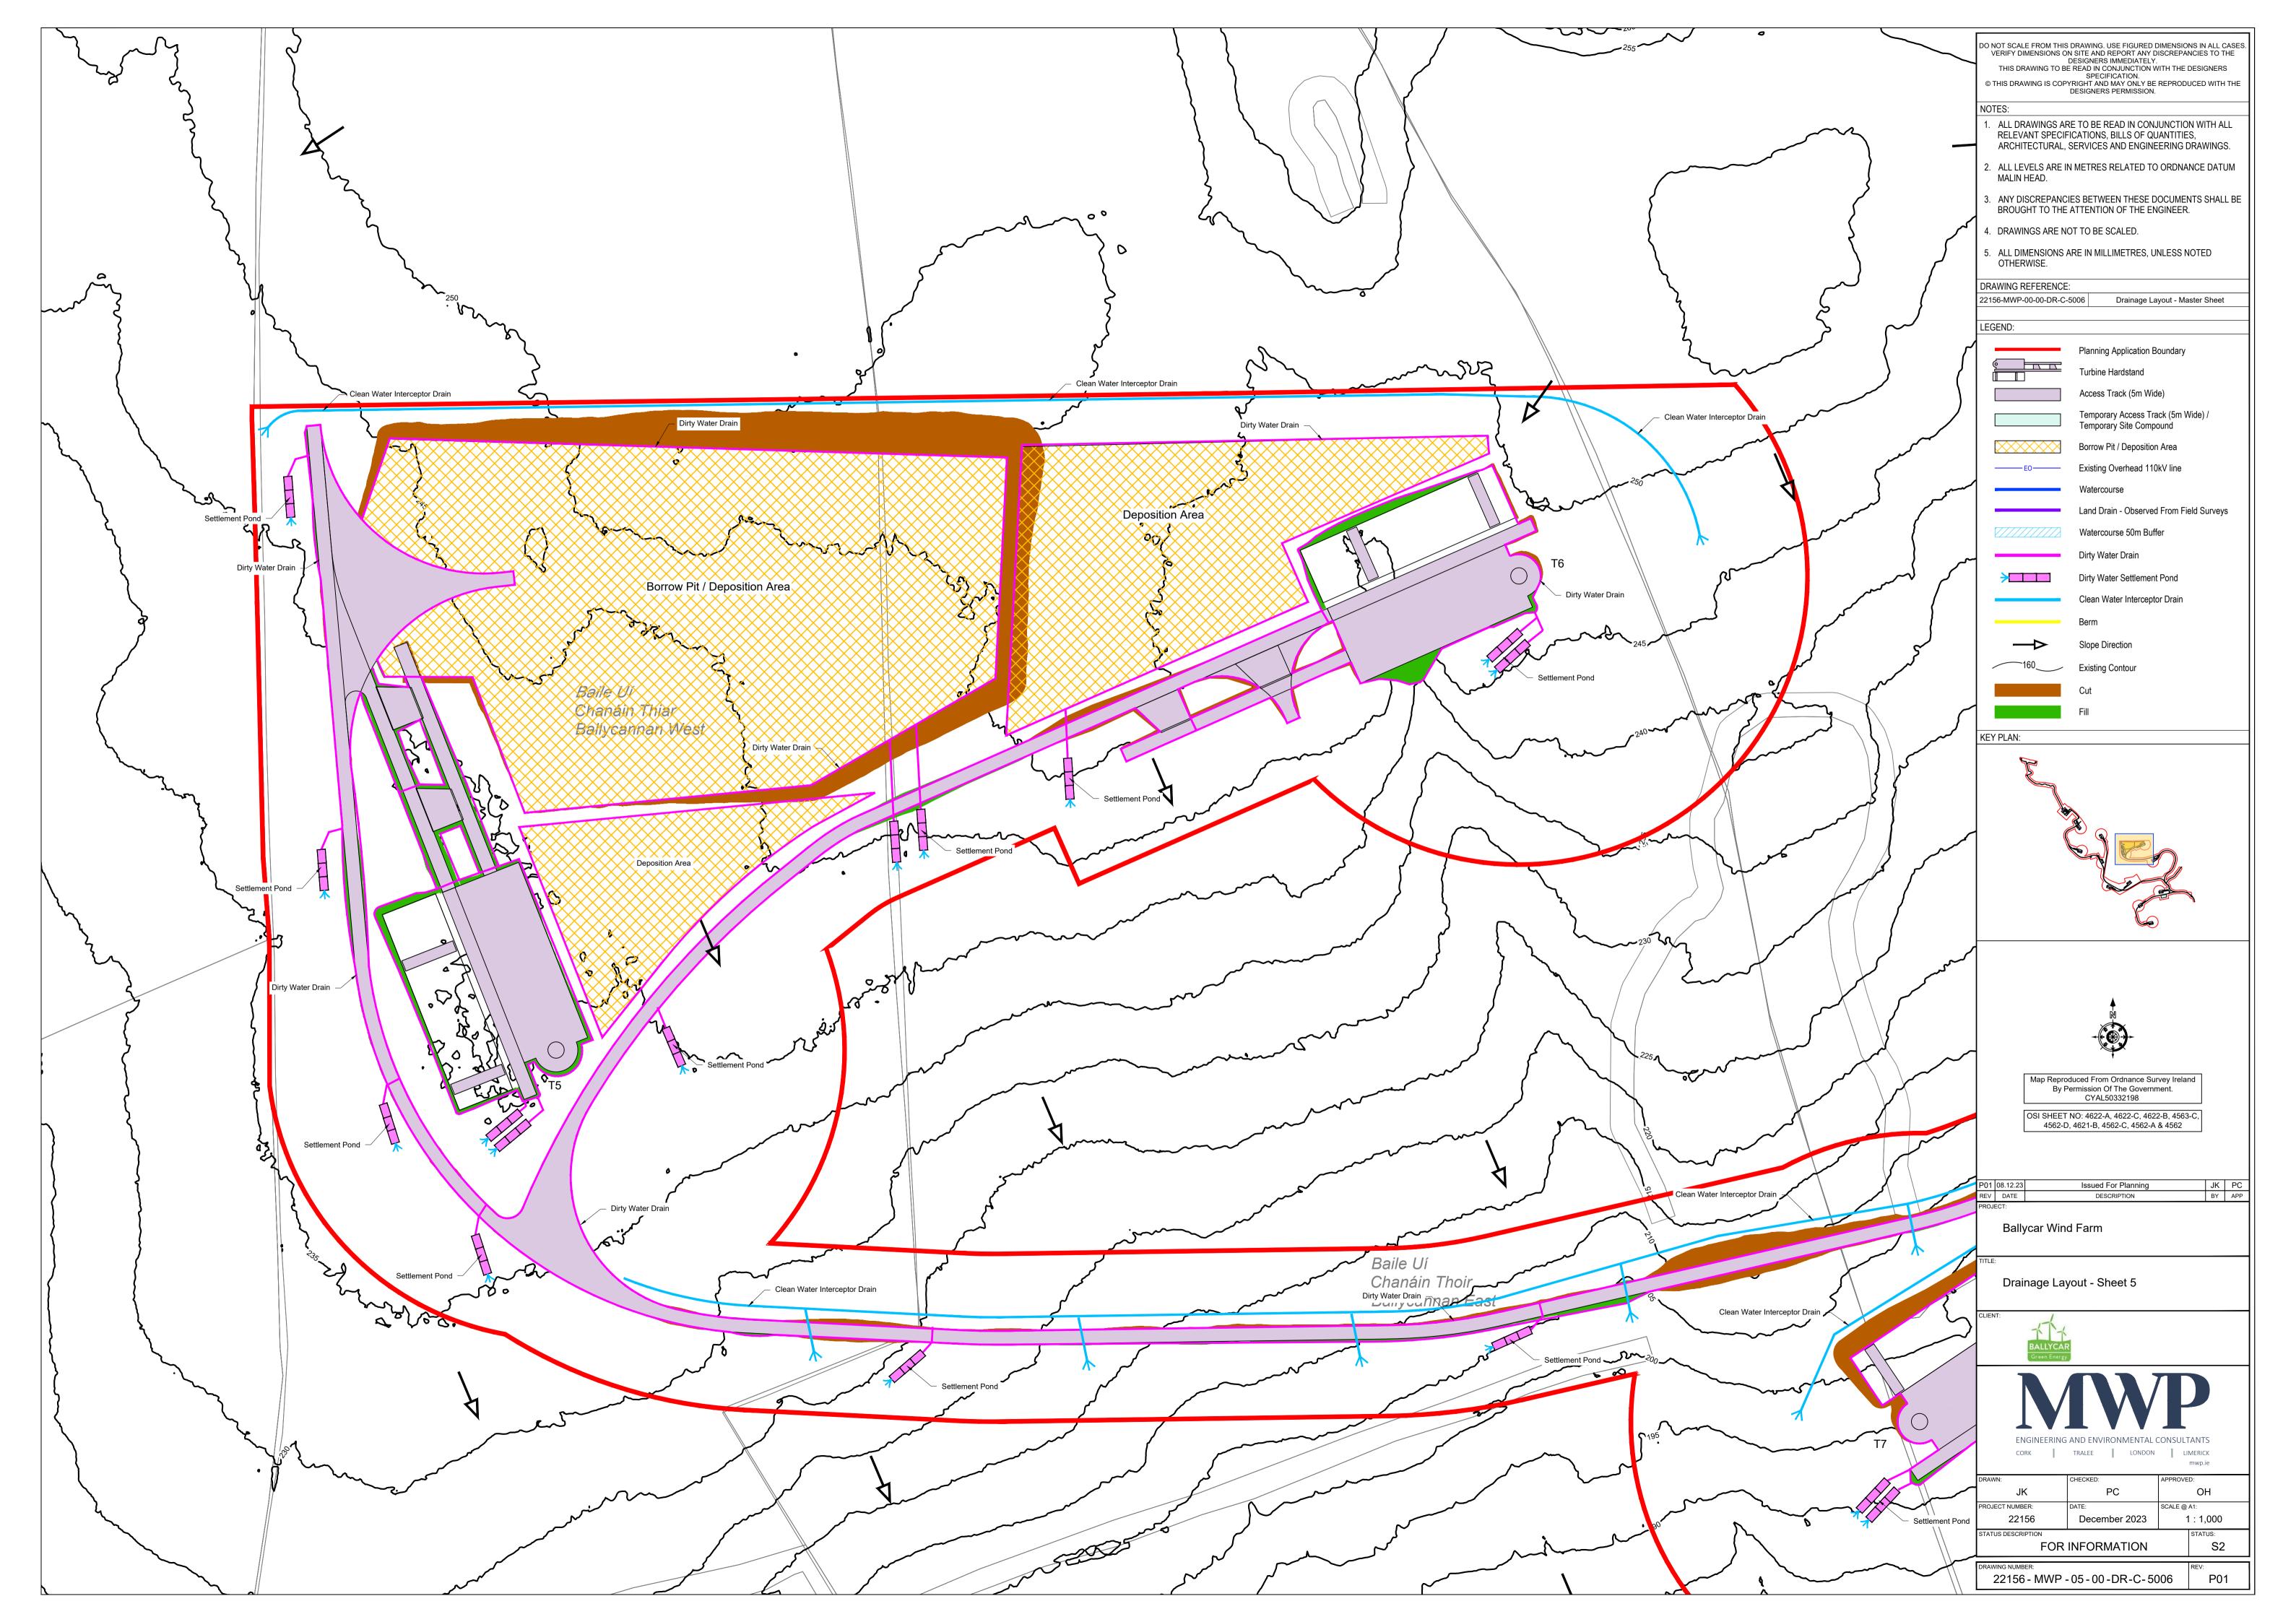


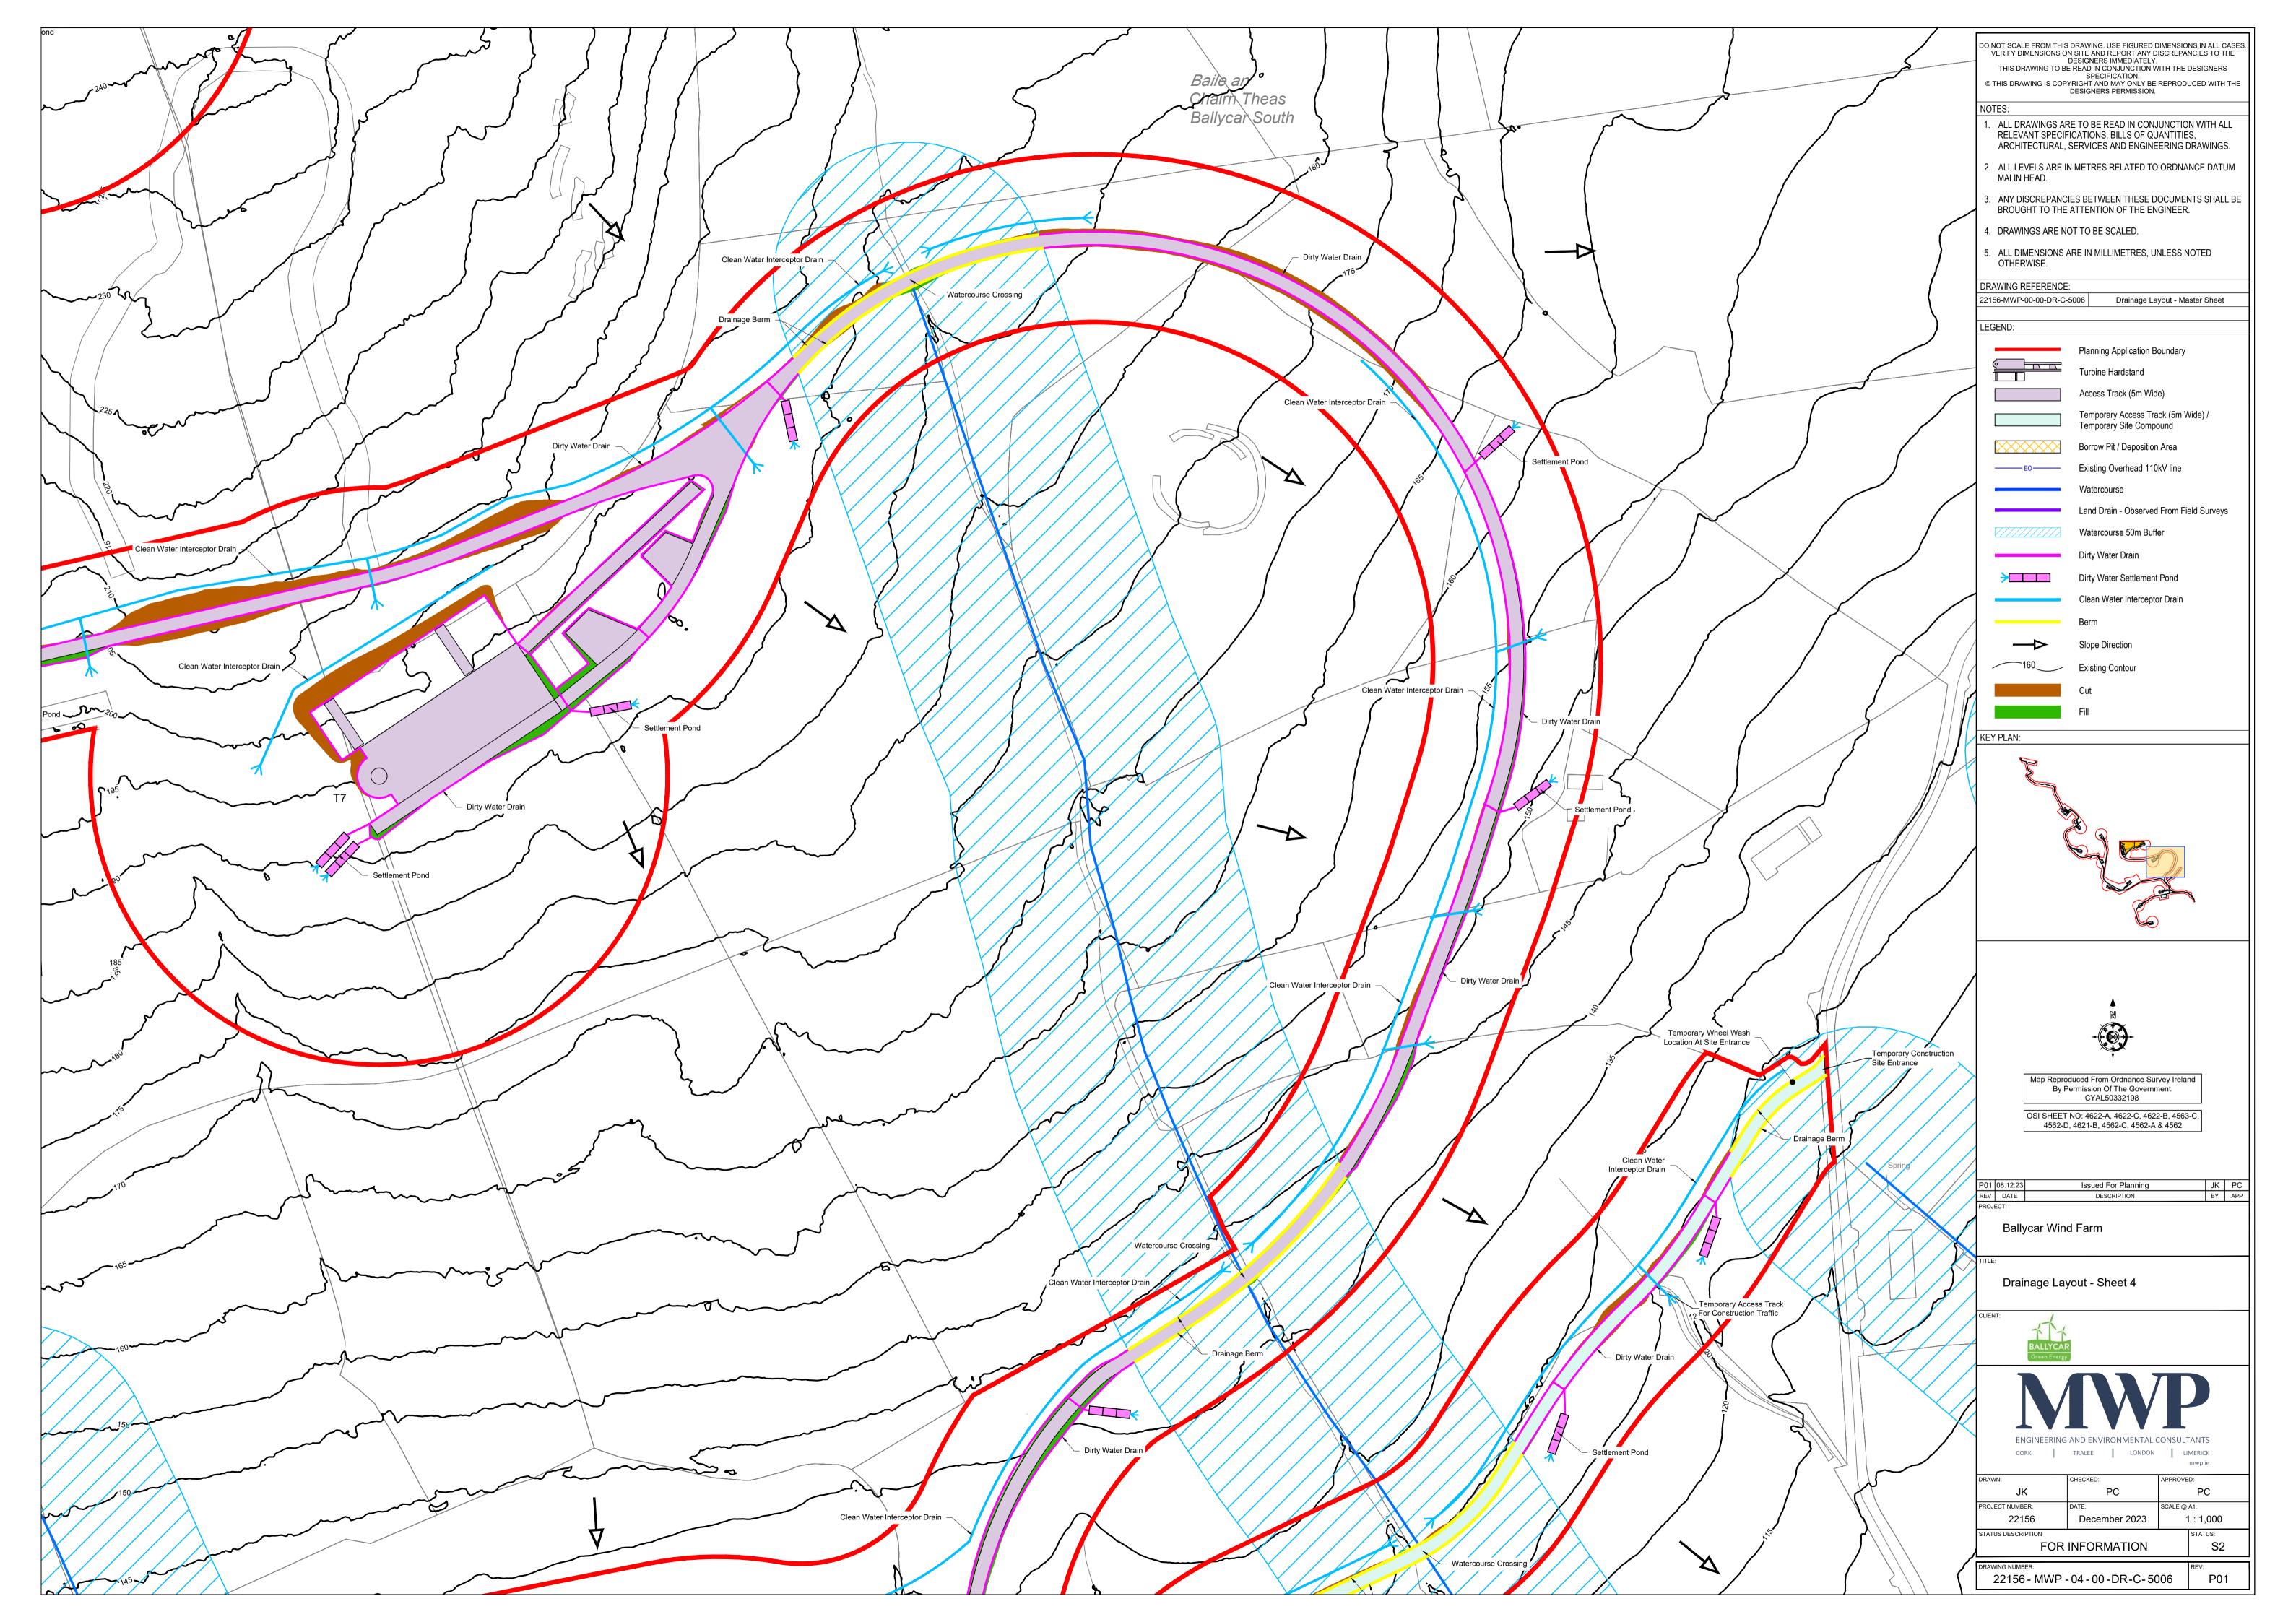


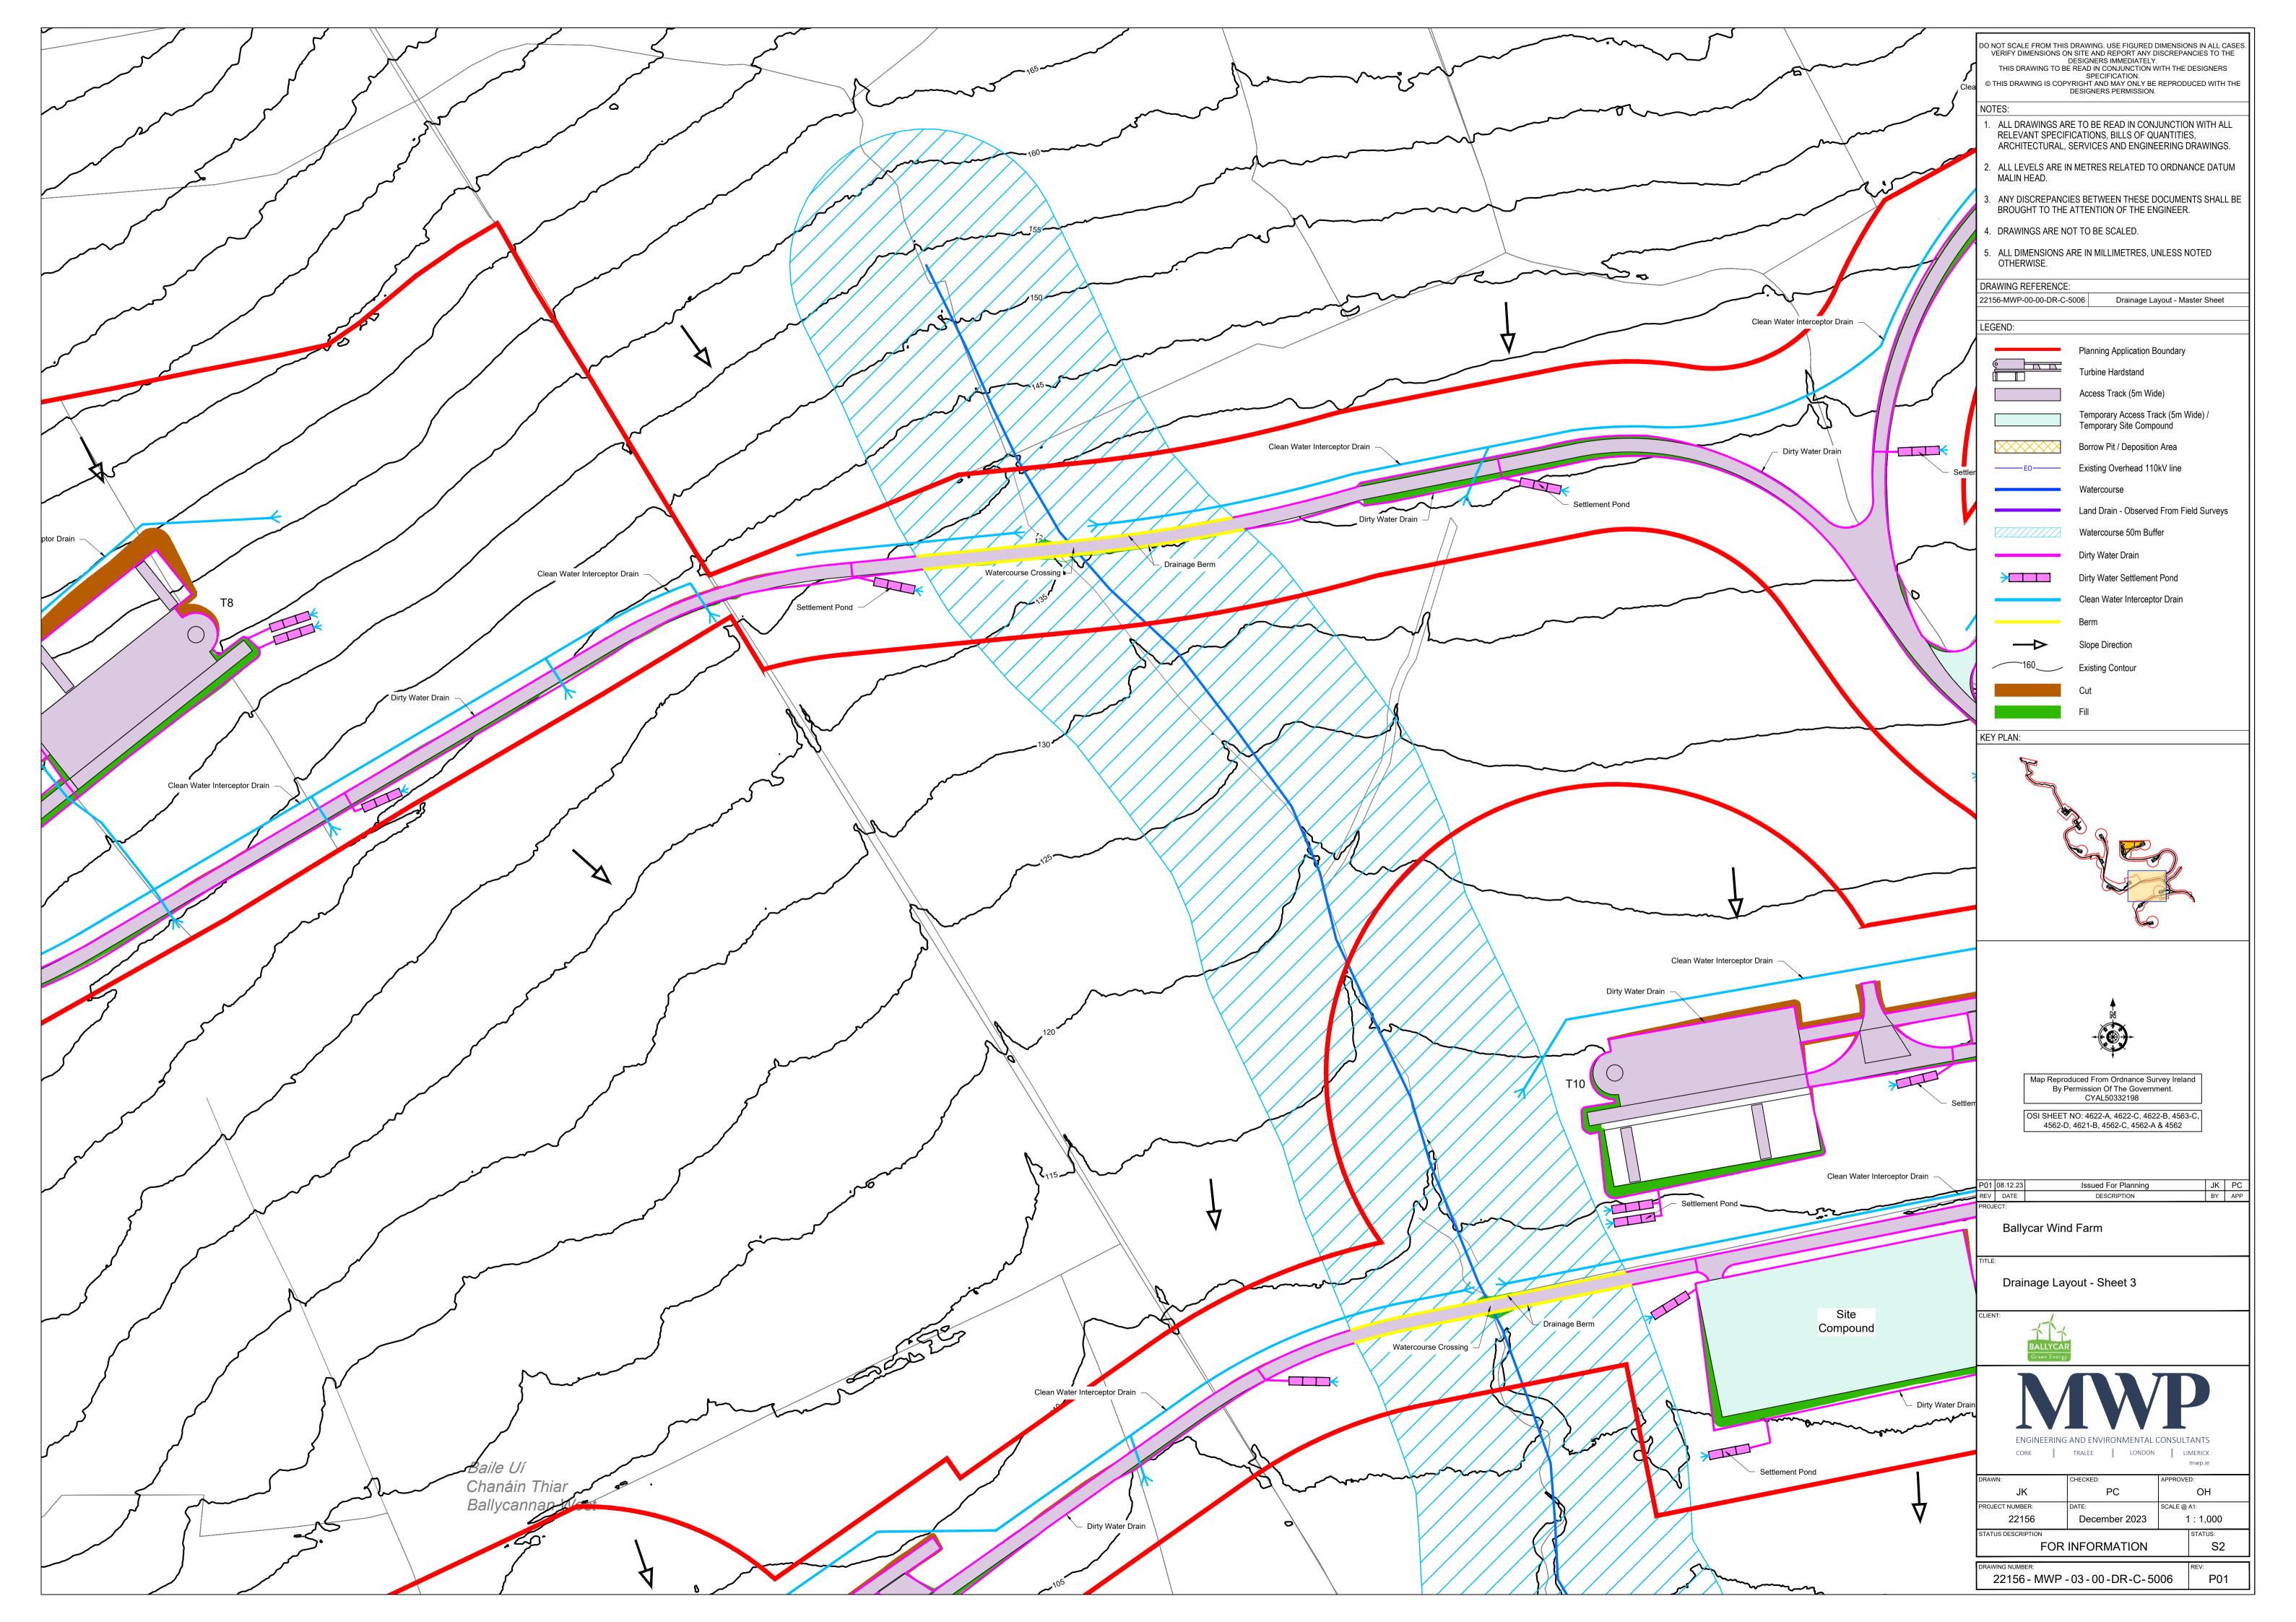


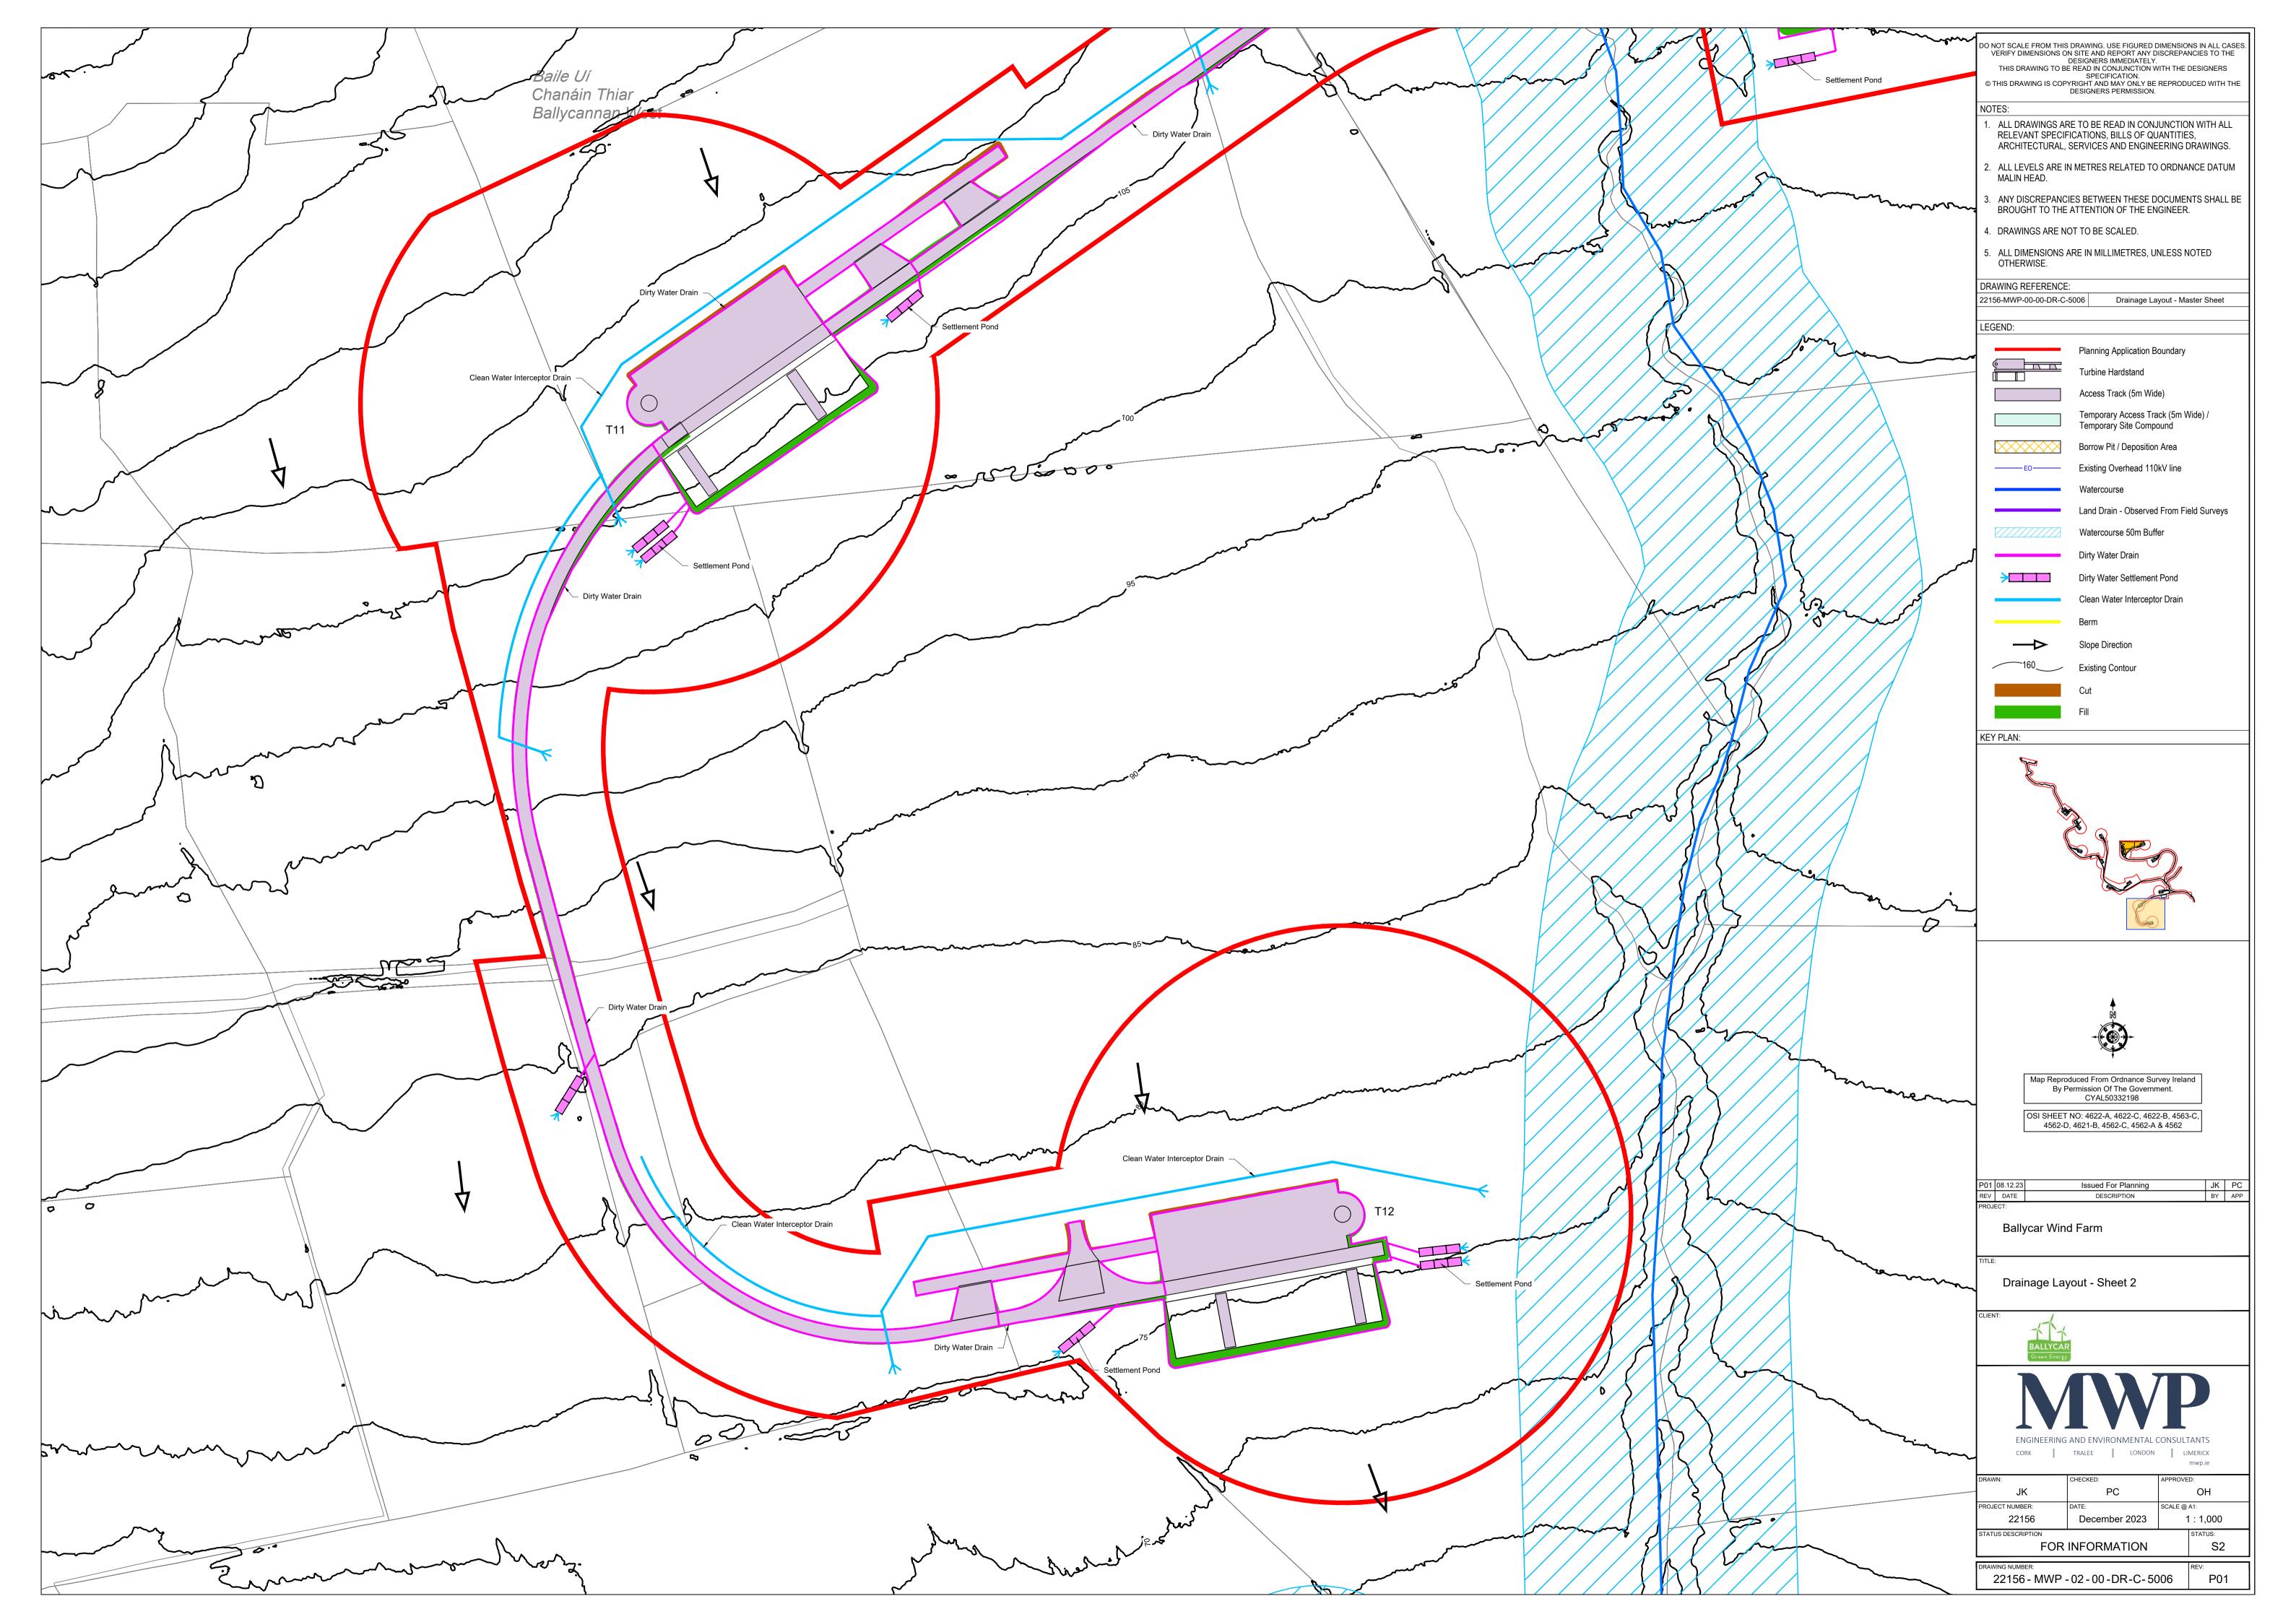


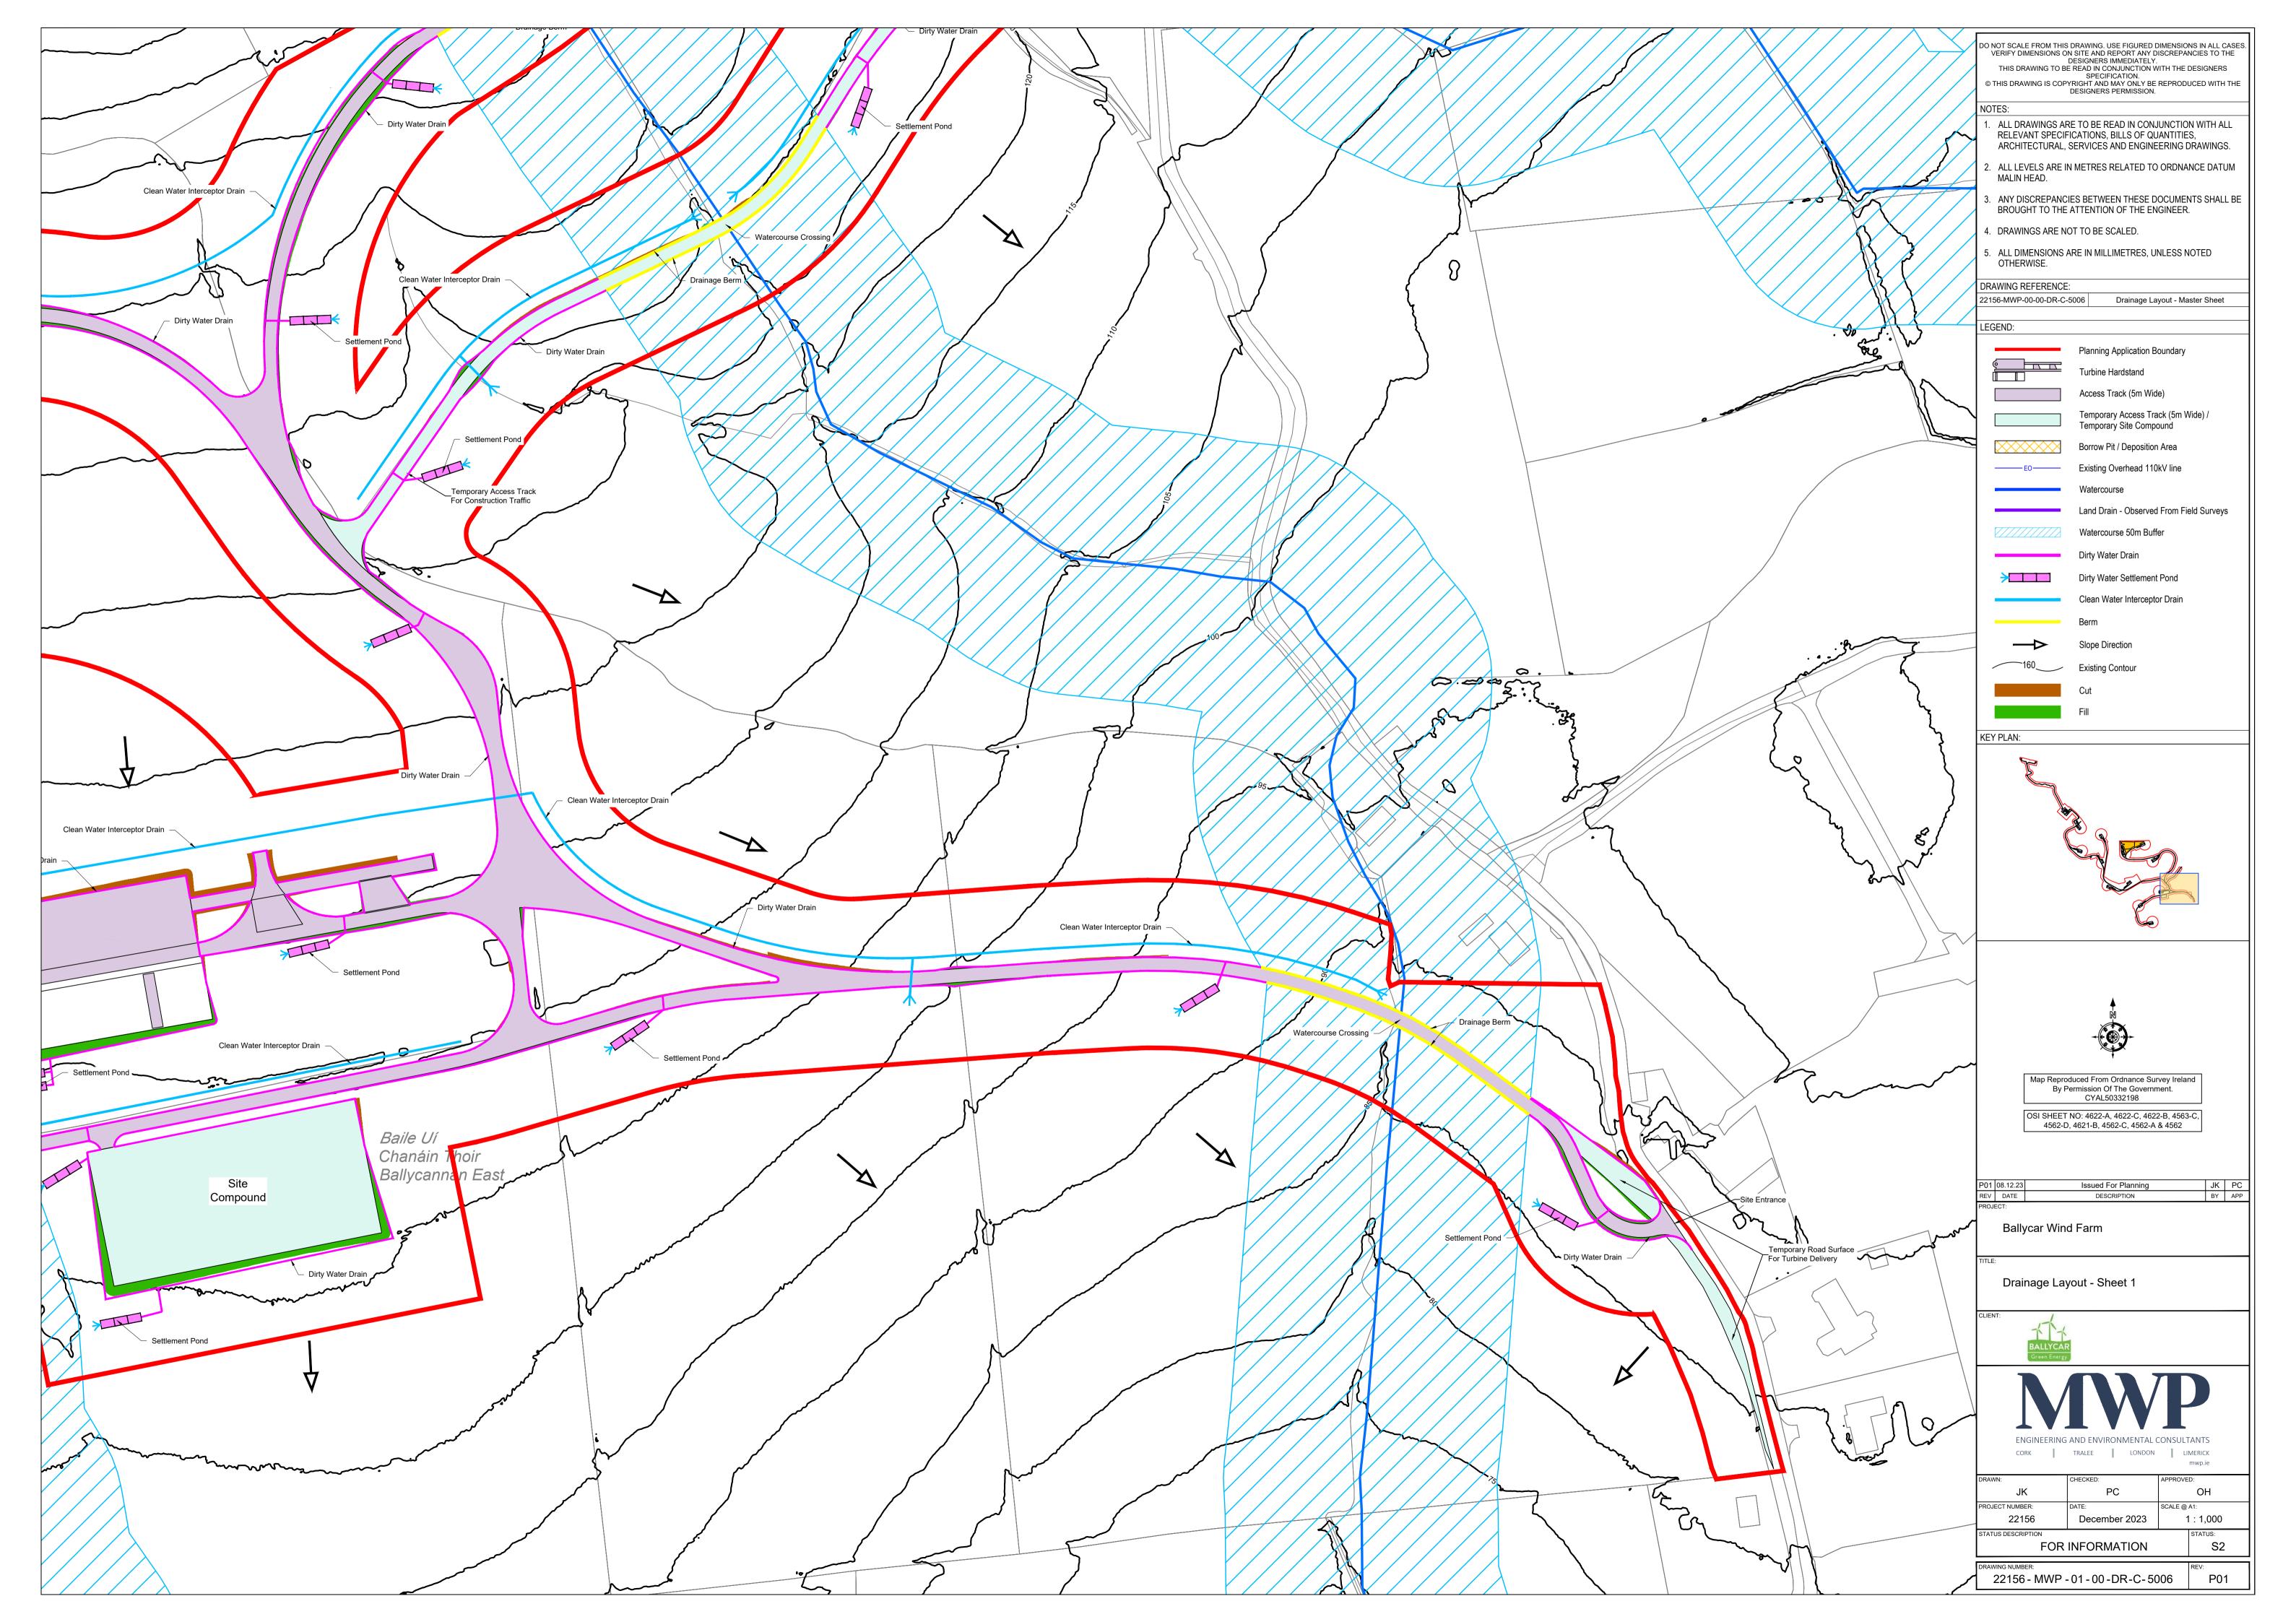

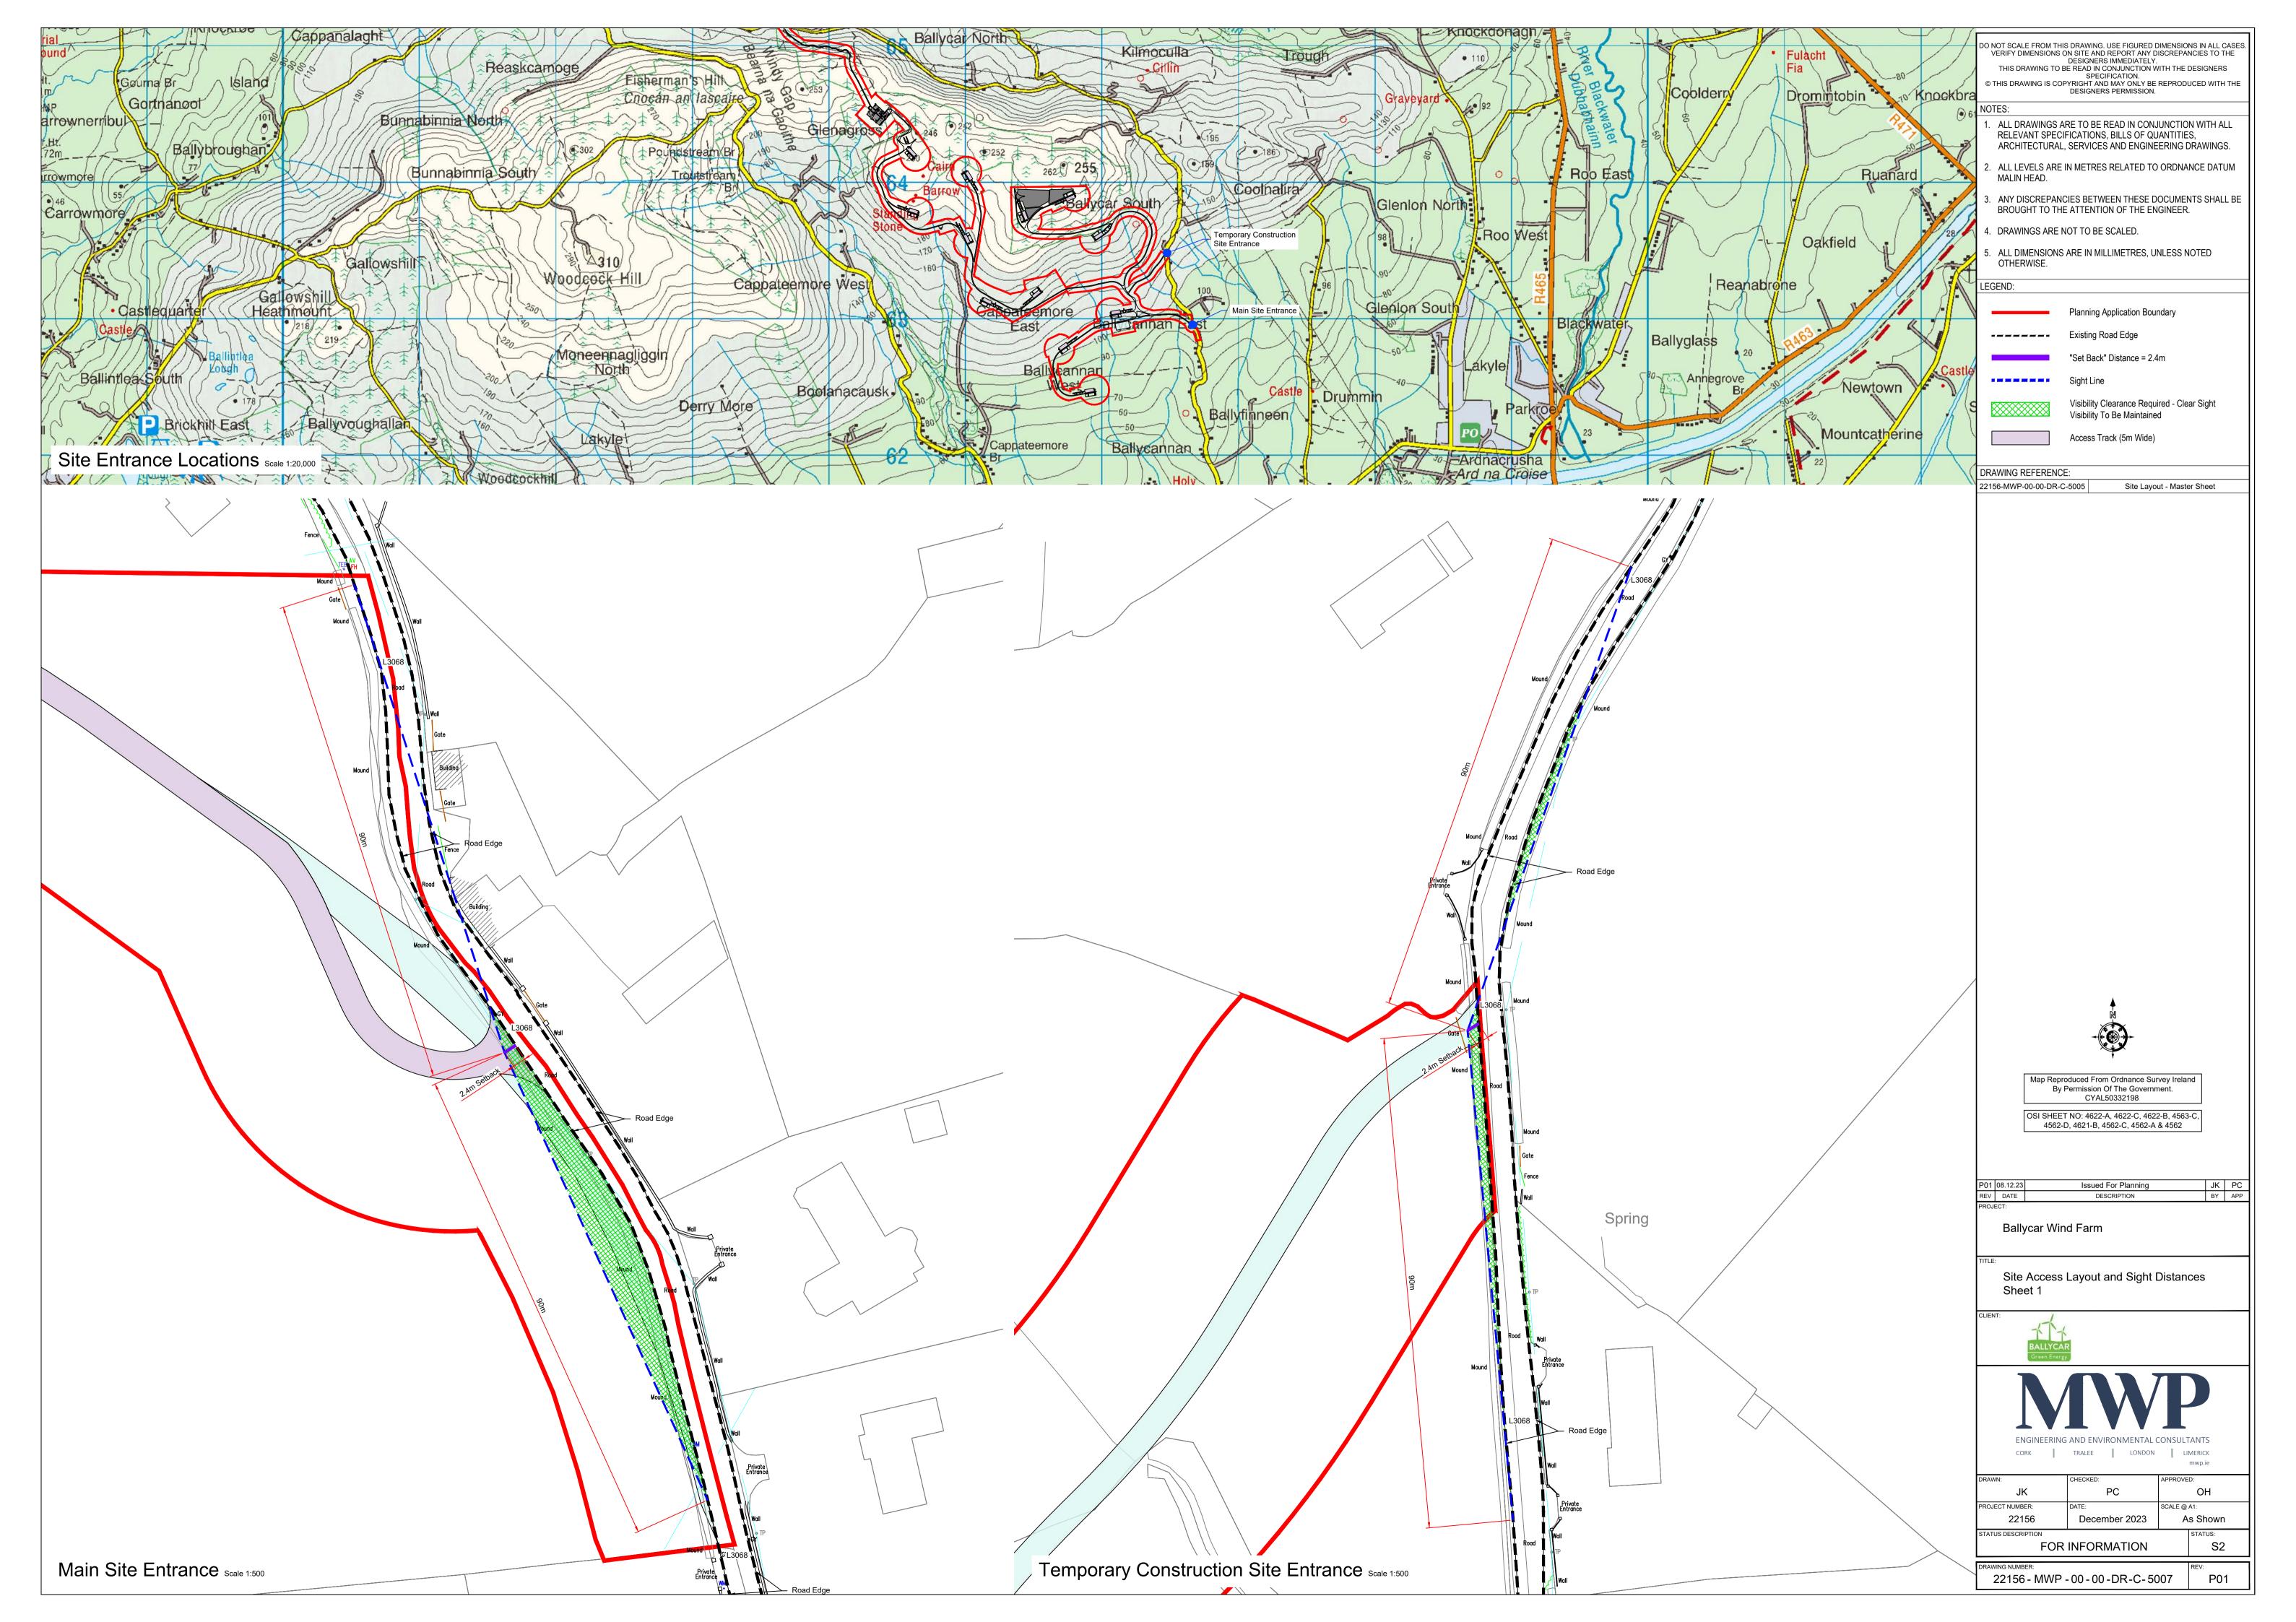


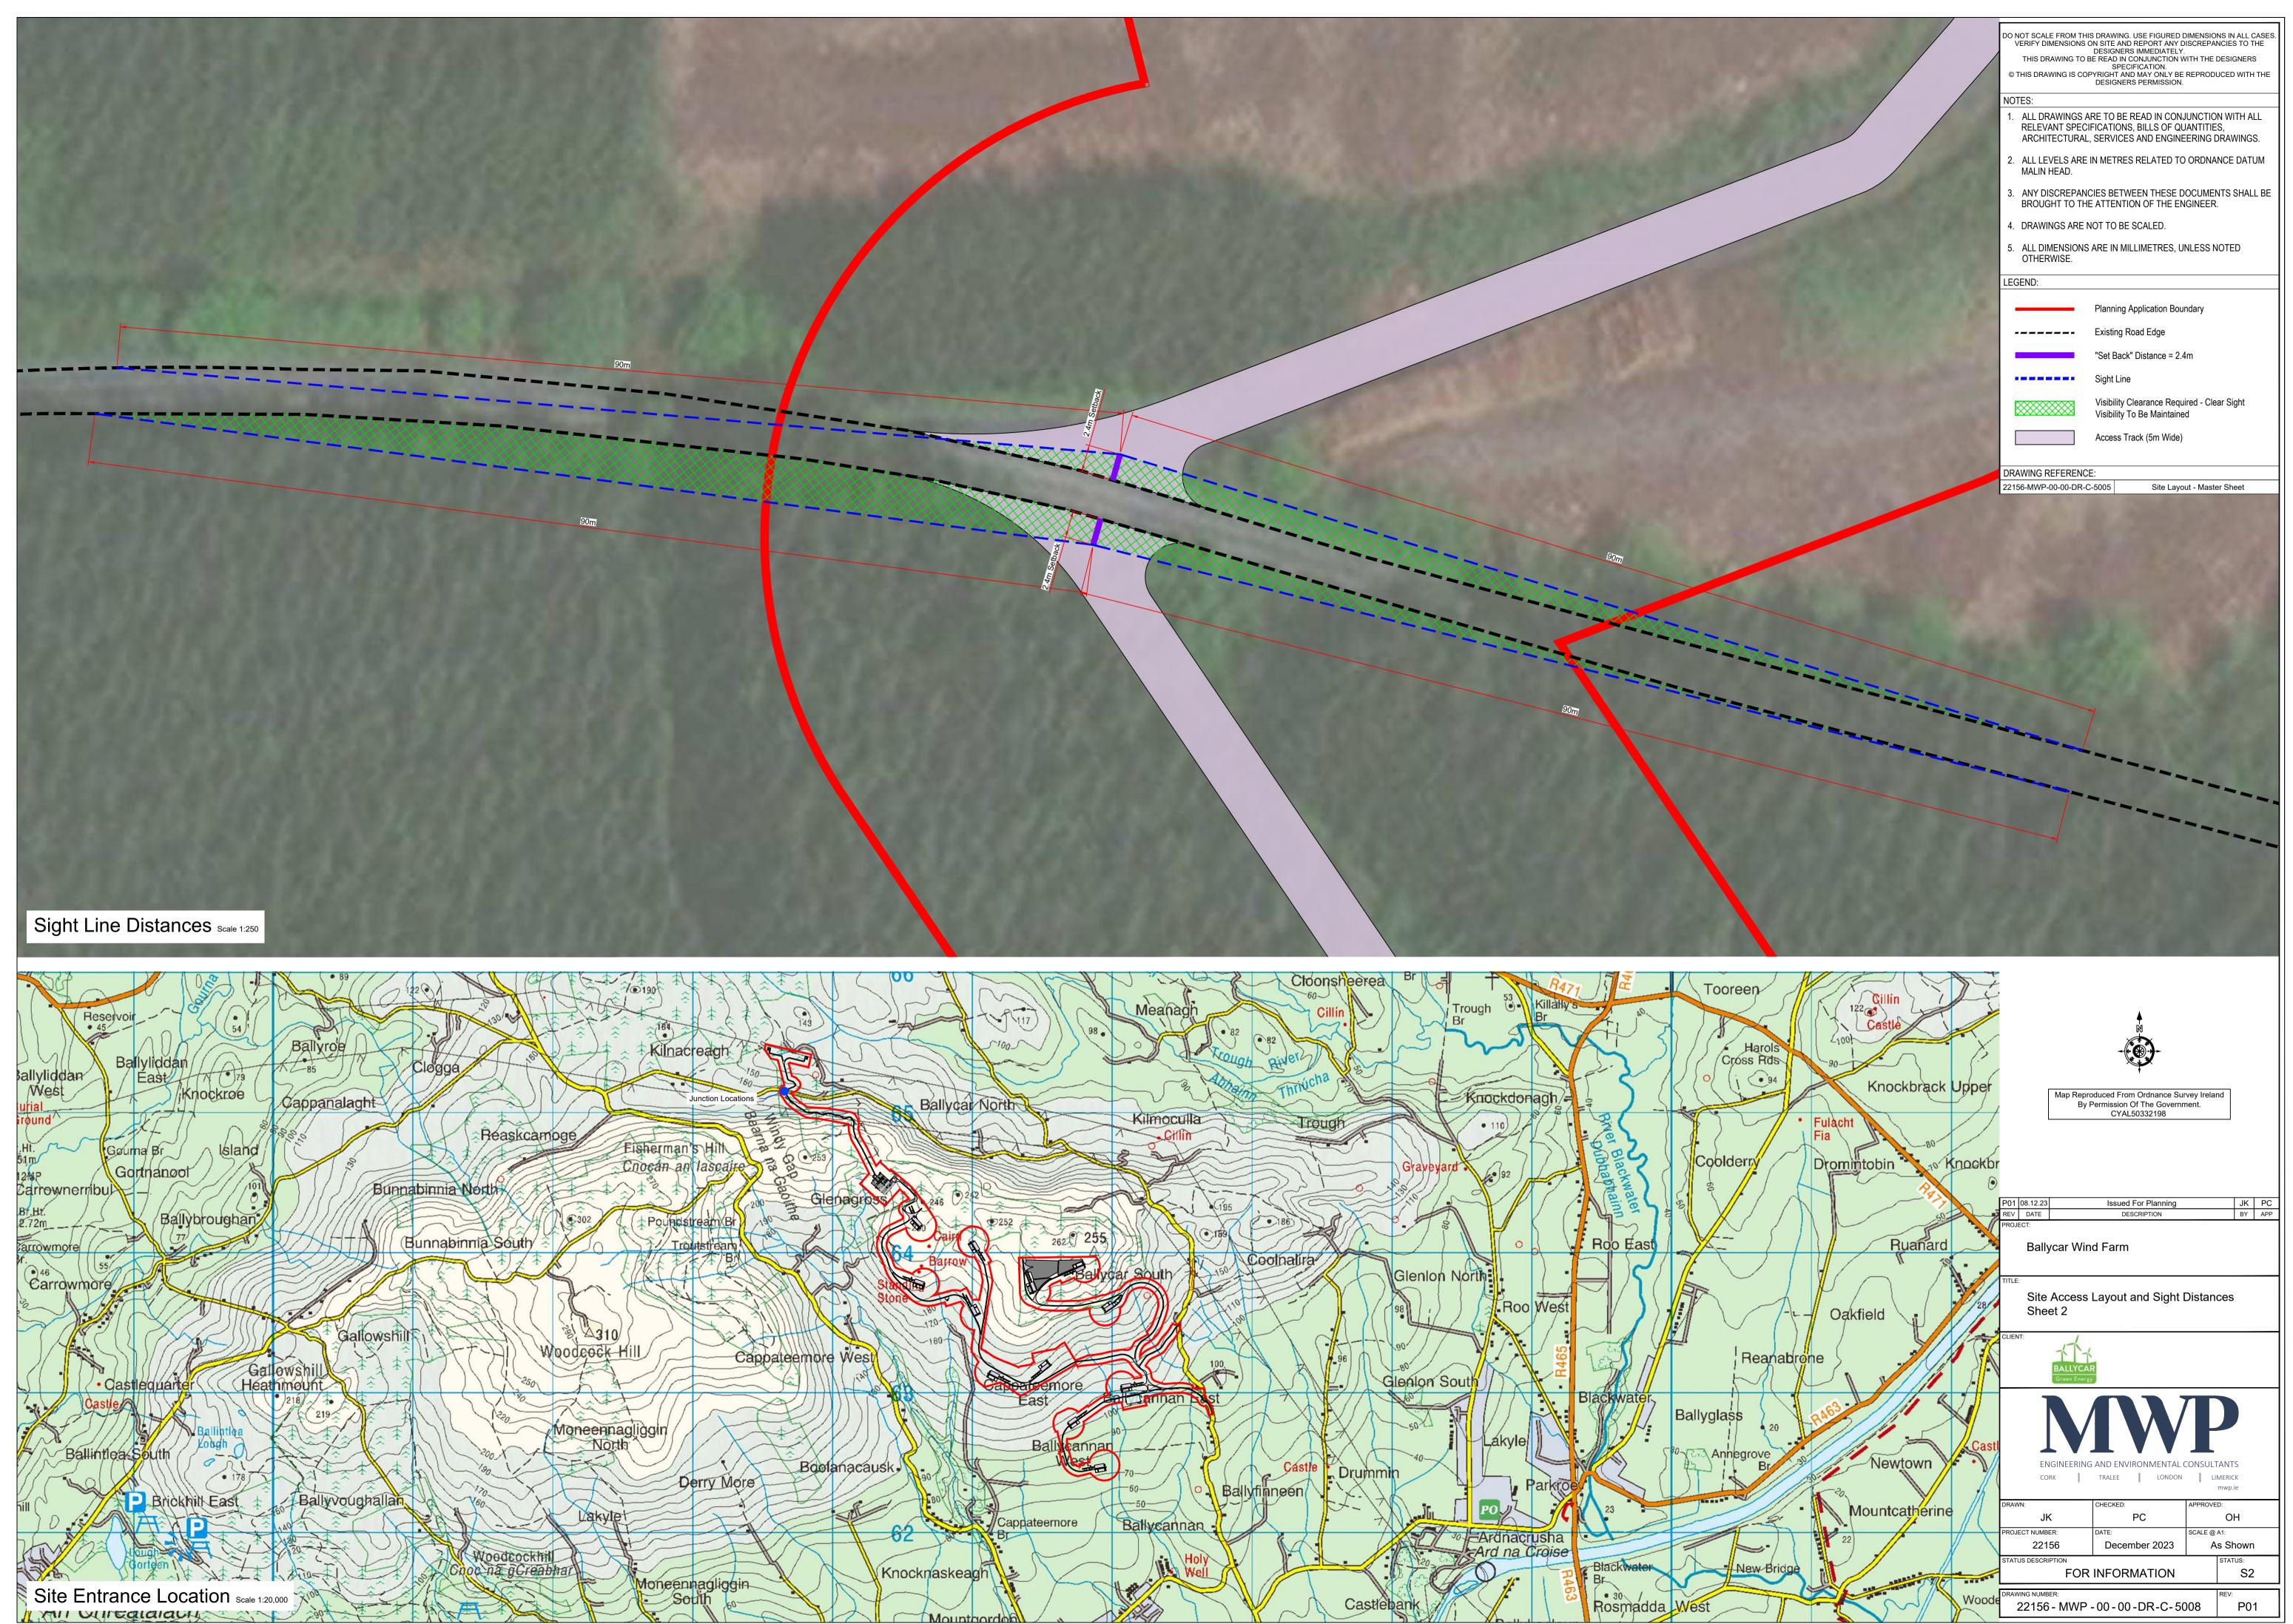


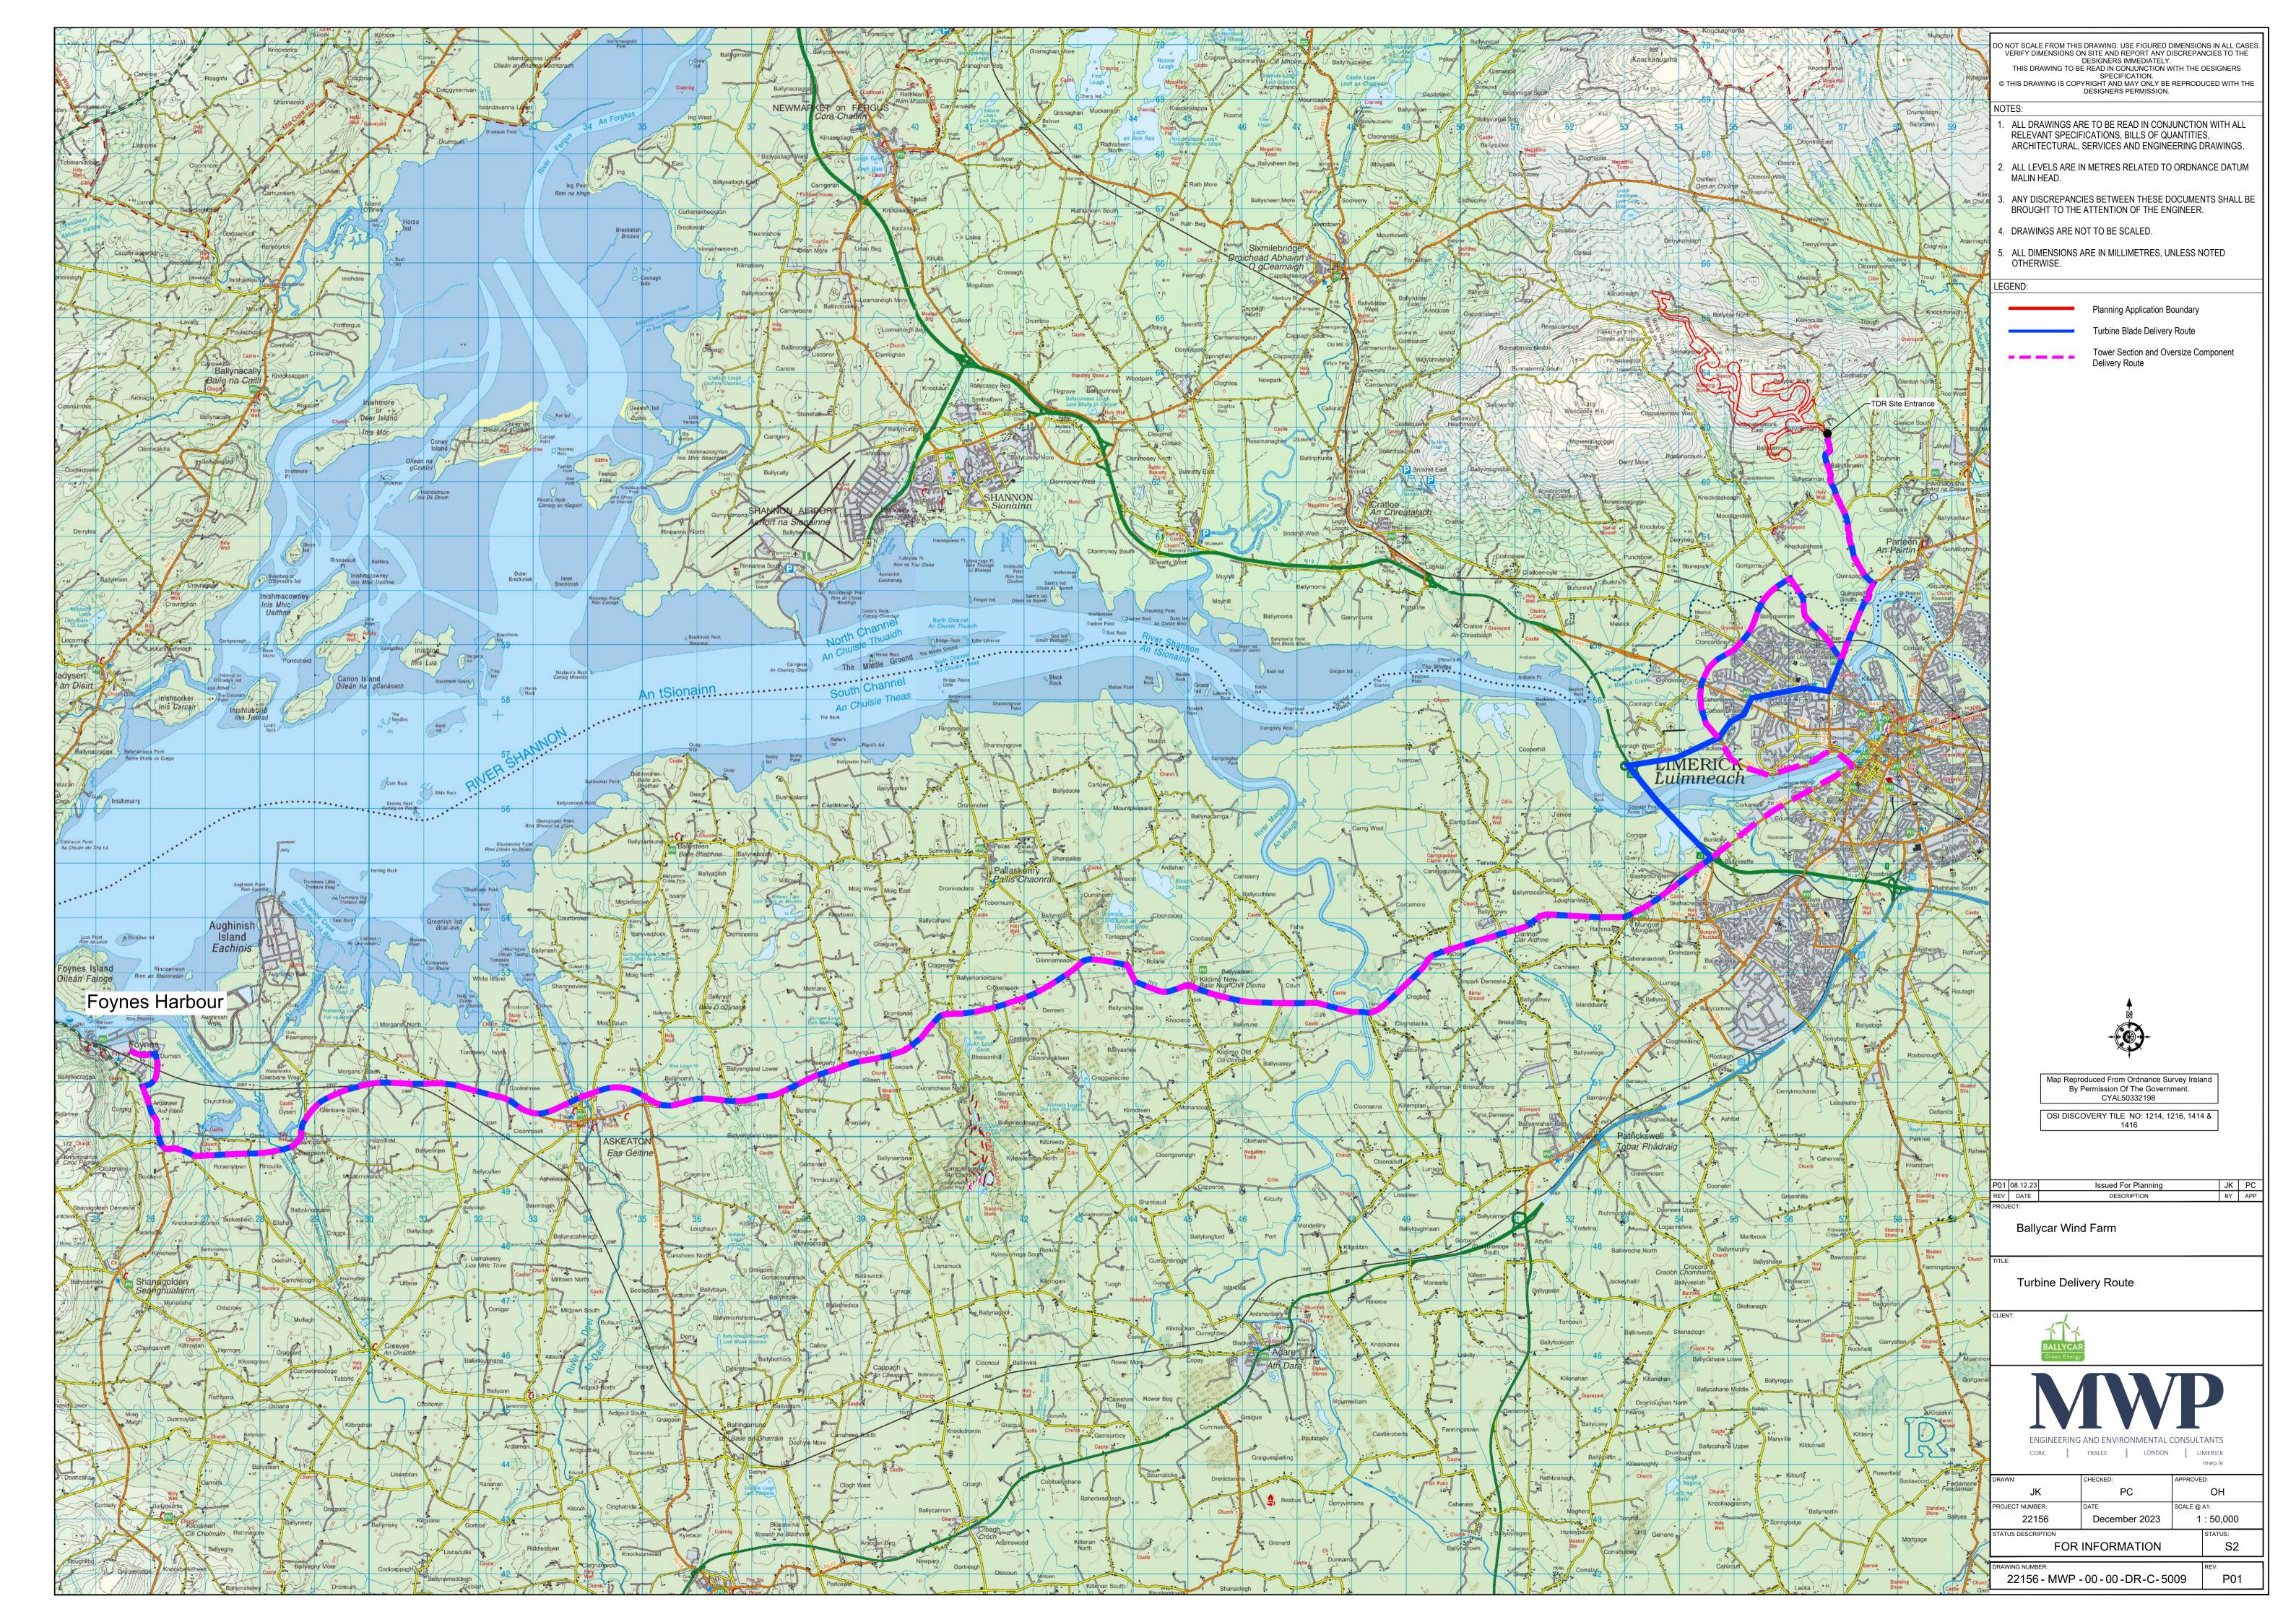

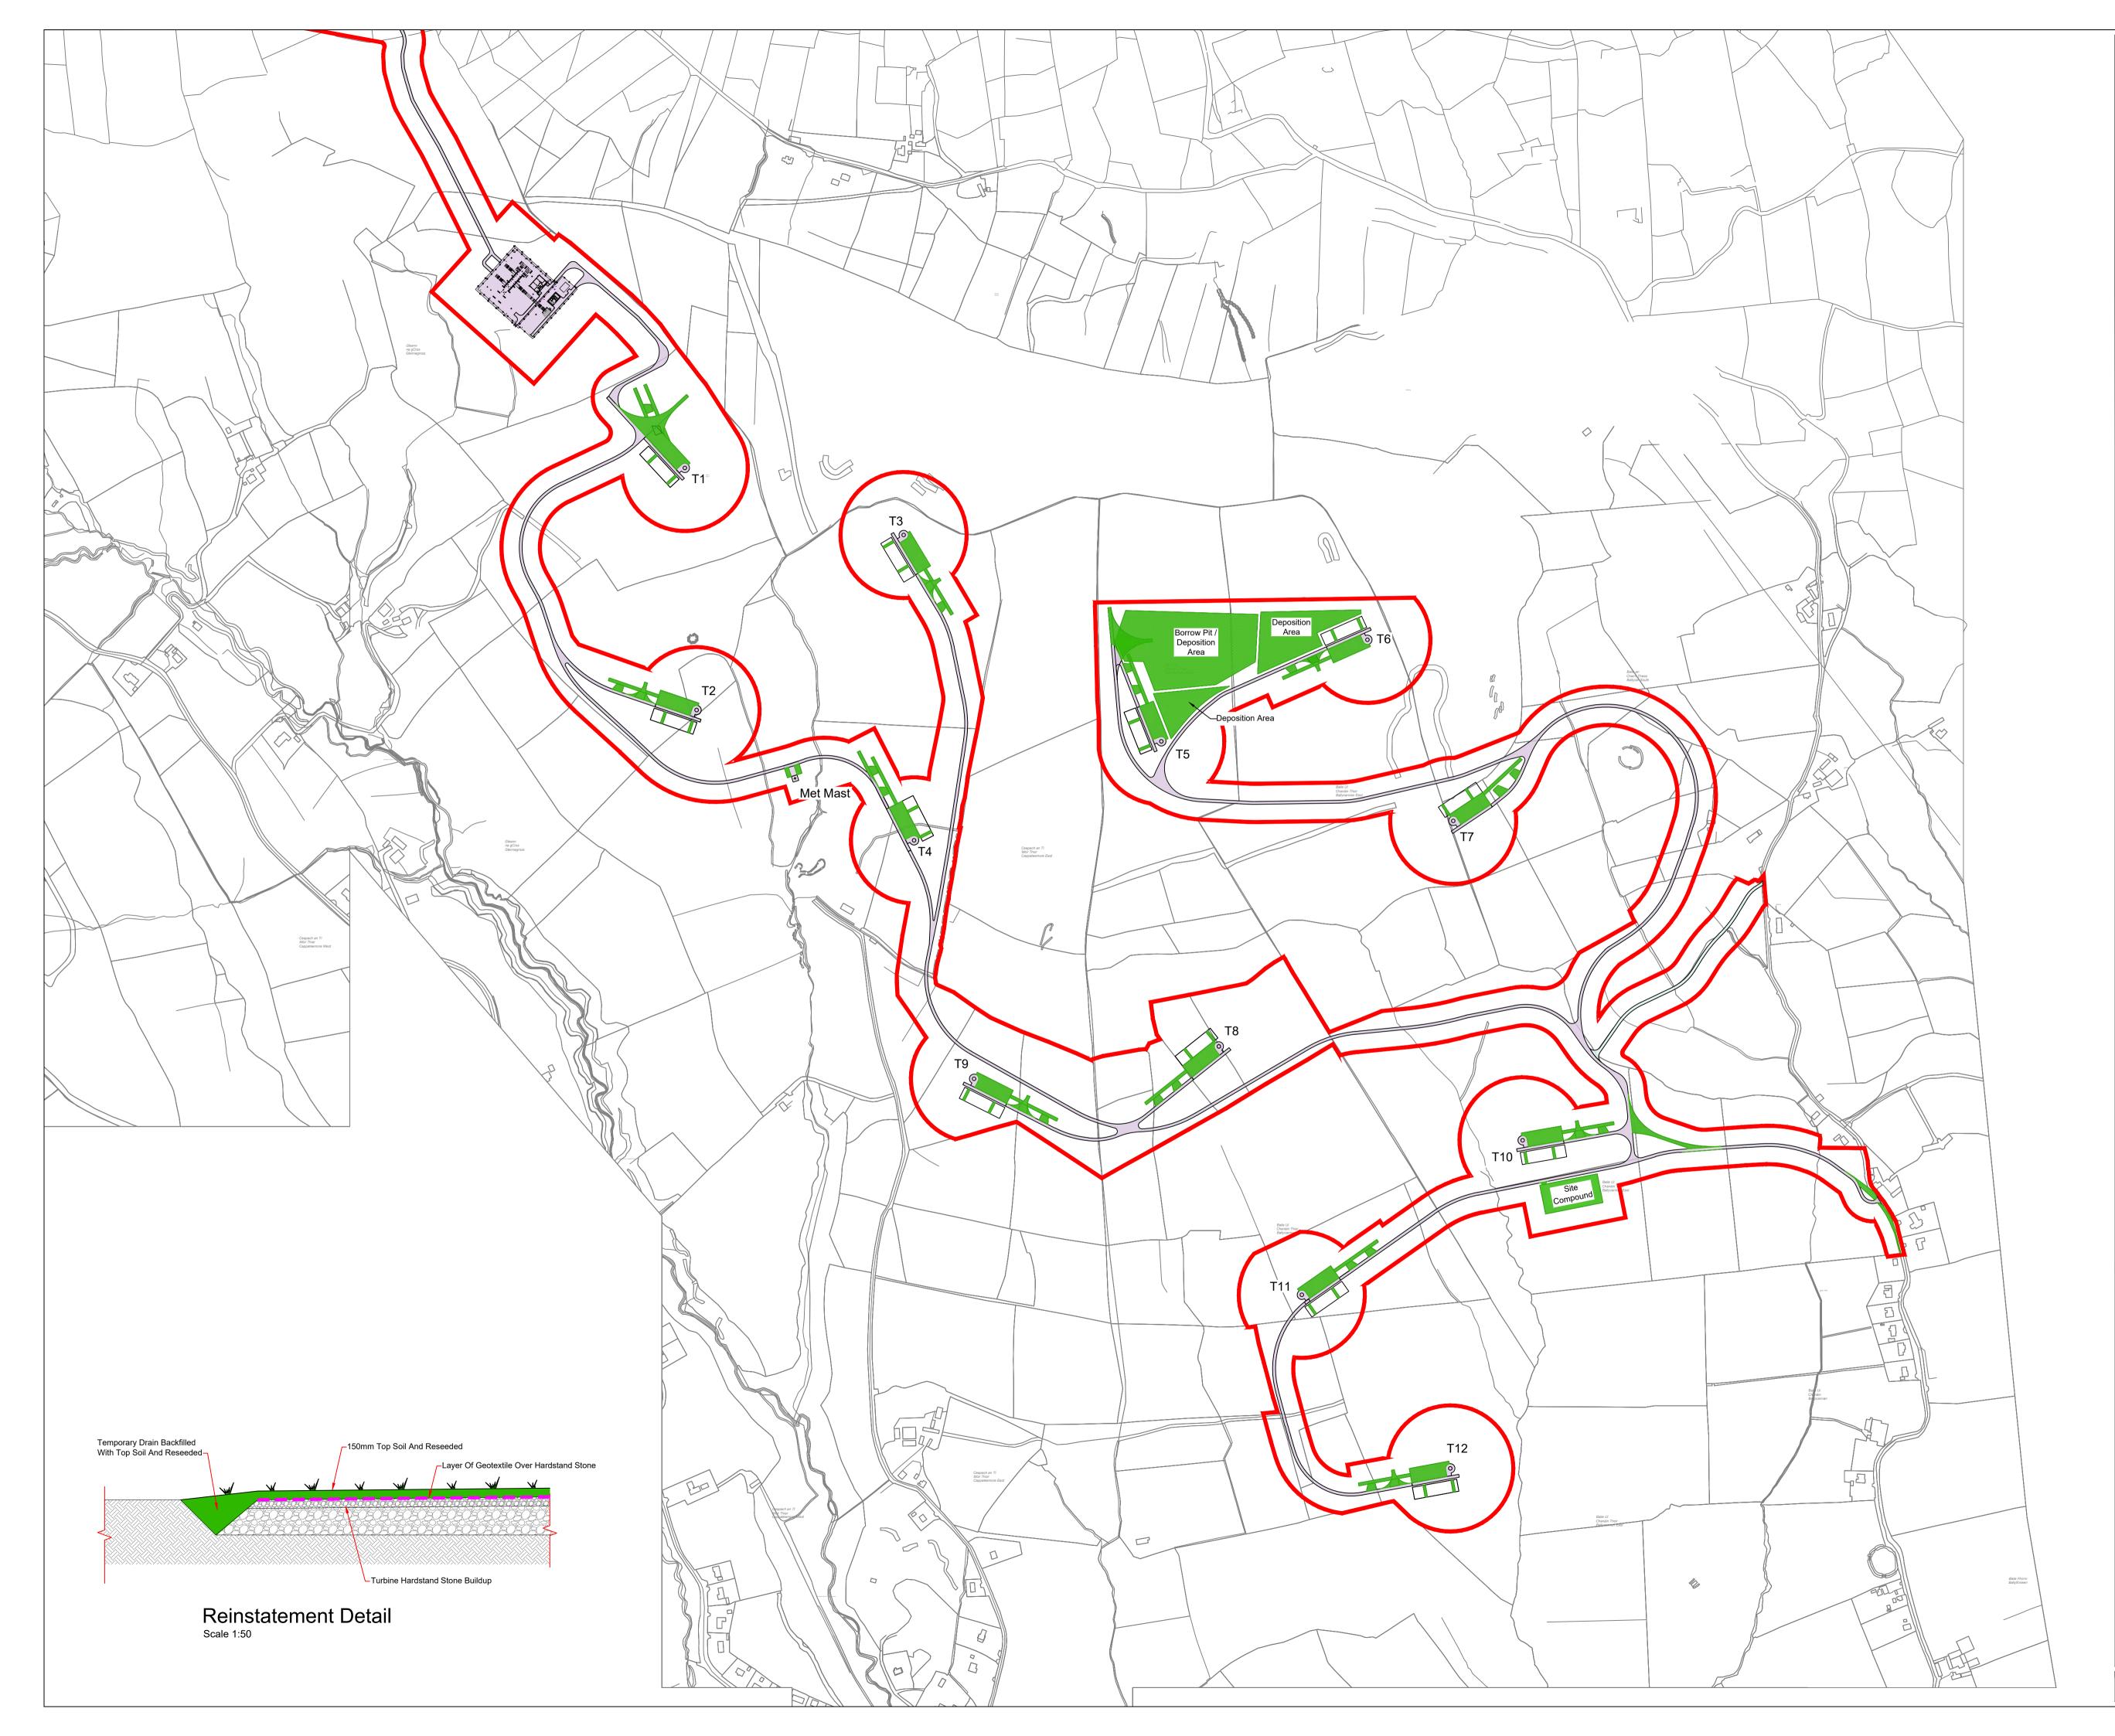



DO NOT SCALE FROM THIS DRAWING. USE FIGURED DIMENSIONS IN ALL CASES. VERIFY DIMENSIONS ON SITE AND REPORT ANY DISCREPANCIES TO THE DESIGNERS IMMEDIATELY. THIS DRAWING TO BE READ IN CONJUNCTION WITH THE DESIGNERS SPECIFICATION. © THIS DRAWING IS COPYRIGHT AND MAY ONLY BE REPRODUCED WITH THE DESIGNERS PERMISSION.				
	DEDIGNERS PERMISSION.			
RELEVANT SPECIF ARCHITECTURAL,	RE TO BE READ IN CONJ ICATIONS, BILLS OF QU SERVICES AND ENGINE	ANTITIE ERING D	s, Drawings.	
2. ALL LEVELS ARE II MALIN HEAD.	N METRES RELATED TO	ORDNA	NCE DATUM	
	IES BETWEEN THESE D ATTENTION OF THE EN OT TO BE SCALED.			
5. ALL DIMENSIONS / OTHERWISE.	ARE IN MILLIMETRES, UI	NLESS N	OTED	
	TO REMAIN FOR THE DU	IRATION	OF THE	
7. AREA TO BE REINS	STATED WITH EXCESS S DPSOIL AND RESEEDED		ATERIAL,	
LEGEND:	Planning Application B	oundary		
	Turbine Hardstand	oundary		
	Access Track			
	Temporary Access Tra Area To Be Revegetate			
	Alea to be nevegetati	50		
DRAWING REFERENCE 22569-MWP-00-00-DR-C-		ut - Maste	er Sheet	
	≜			
	duced From Ordnance Sur ermission Of The Governn		nd	
	CYAL50332198. NO: 4622-A, 4622-C, 4622			
	NO: 4622-A, 4622-C, 4622 , 4621-B, 4562-C, 4562-A		<u>,</u>	
P01 08.12.23	Issued For Planning		JK PC	
REV DATE PROJECT:	DESCRIPTION		BY APP	
Ballycar Wind Farm				
Revegetation of Temporary Works Areas				
CLIENT:				
BALLYCAR Green Energy				
M				
ENGINEERING AND ENVIRONMENTAL CONSULTANTS CORK TRALEE LONDON LIMERICK mwp.ie				
drawn: JK	CHECKED: PC	APPROVE	D: OH	
PROJECT NUMBER: 22156	DATE: December 2023	SCALE @	•••	
STATUS DESCRIPTION	INFORMATION		status: S2	
DRAWING NUMBER:		10	REV:	
22156 - MWP -	00-00-DR-C-50	JTU	P01	

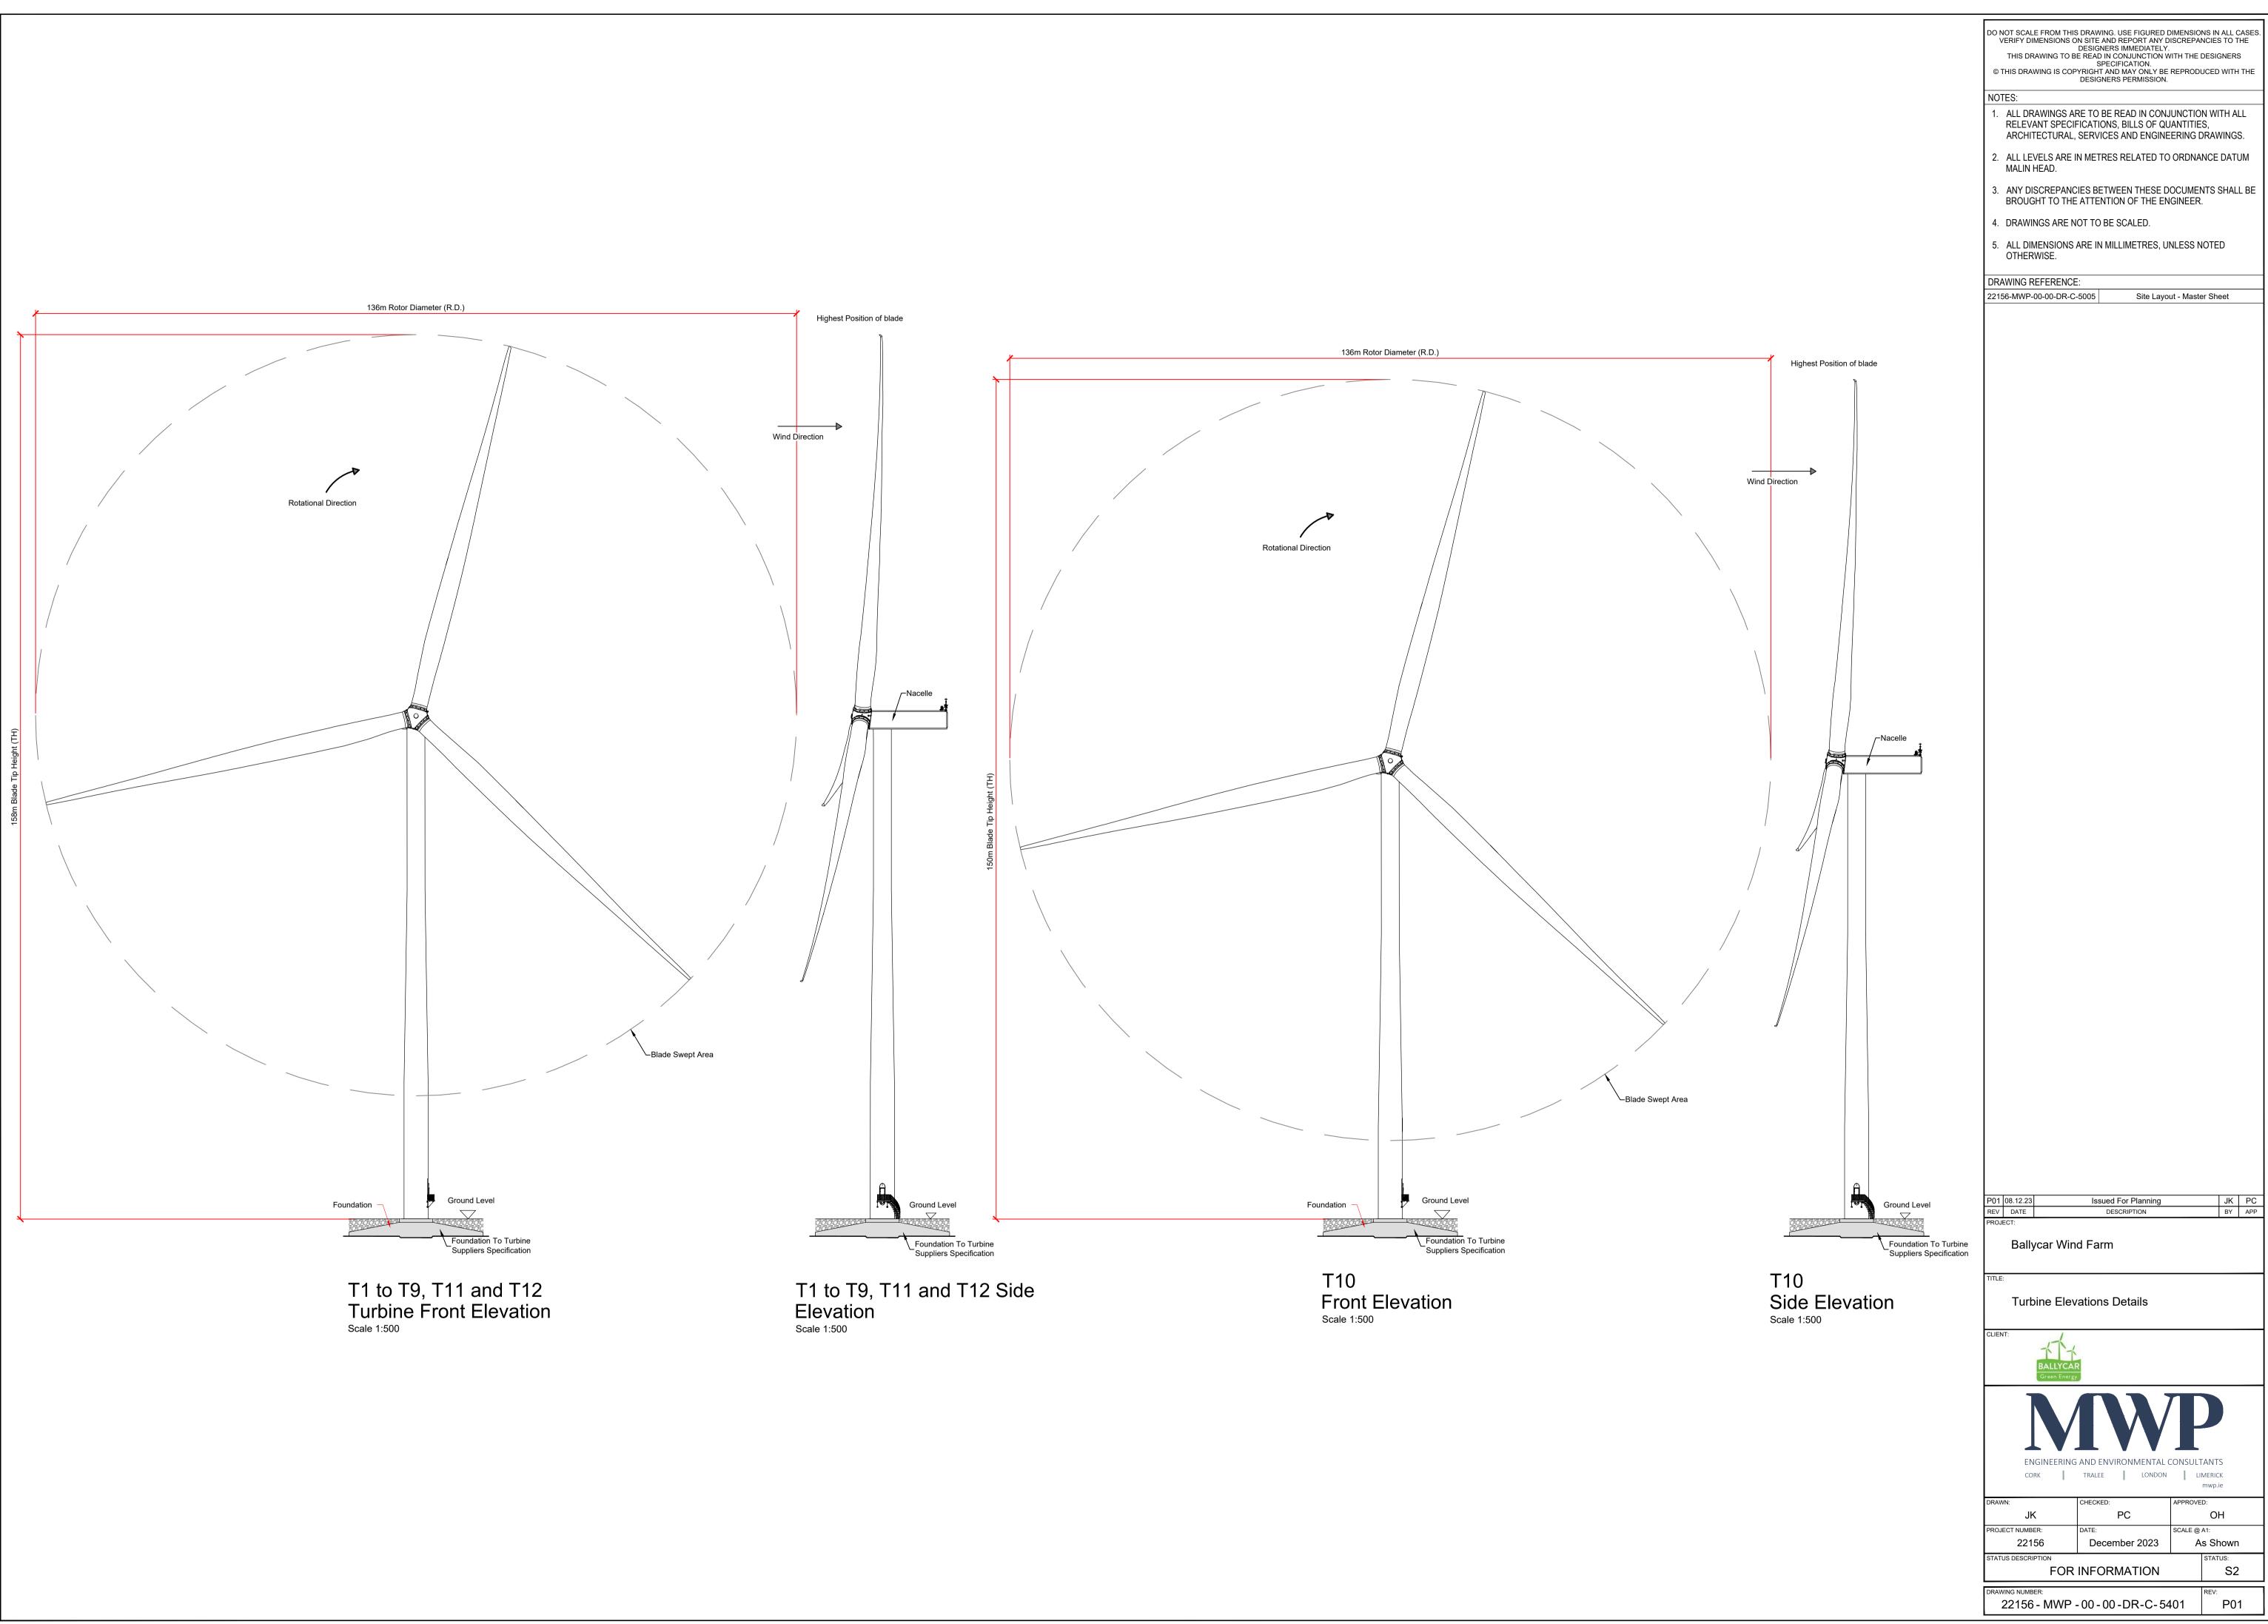

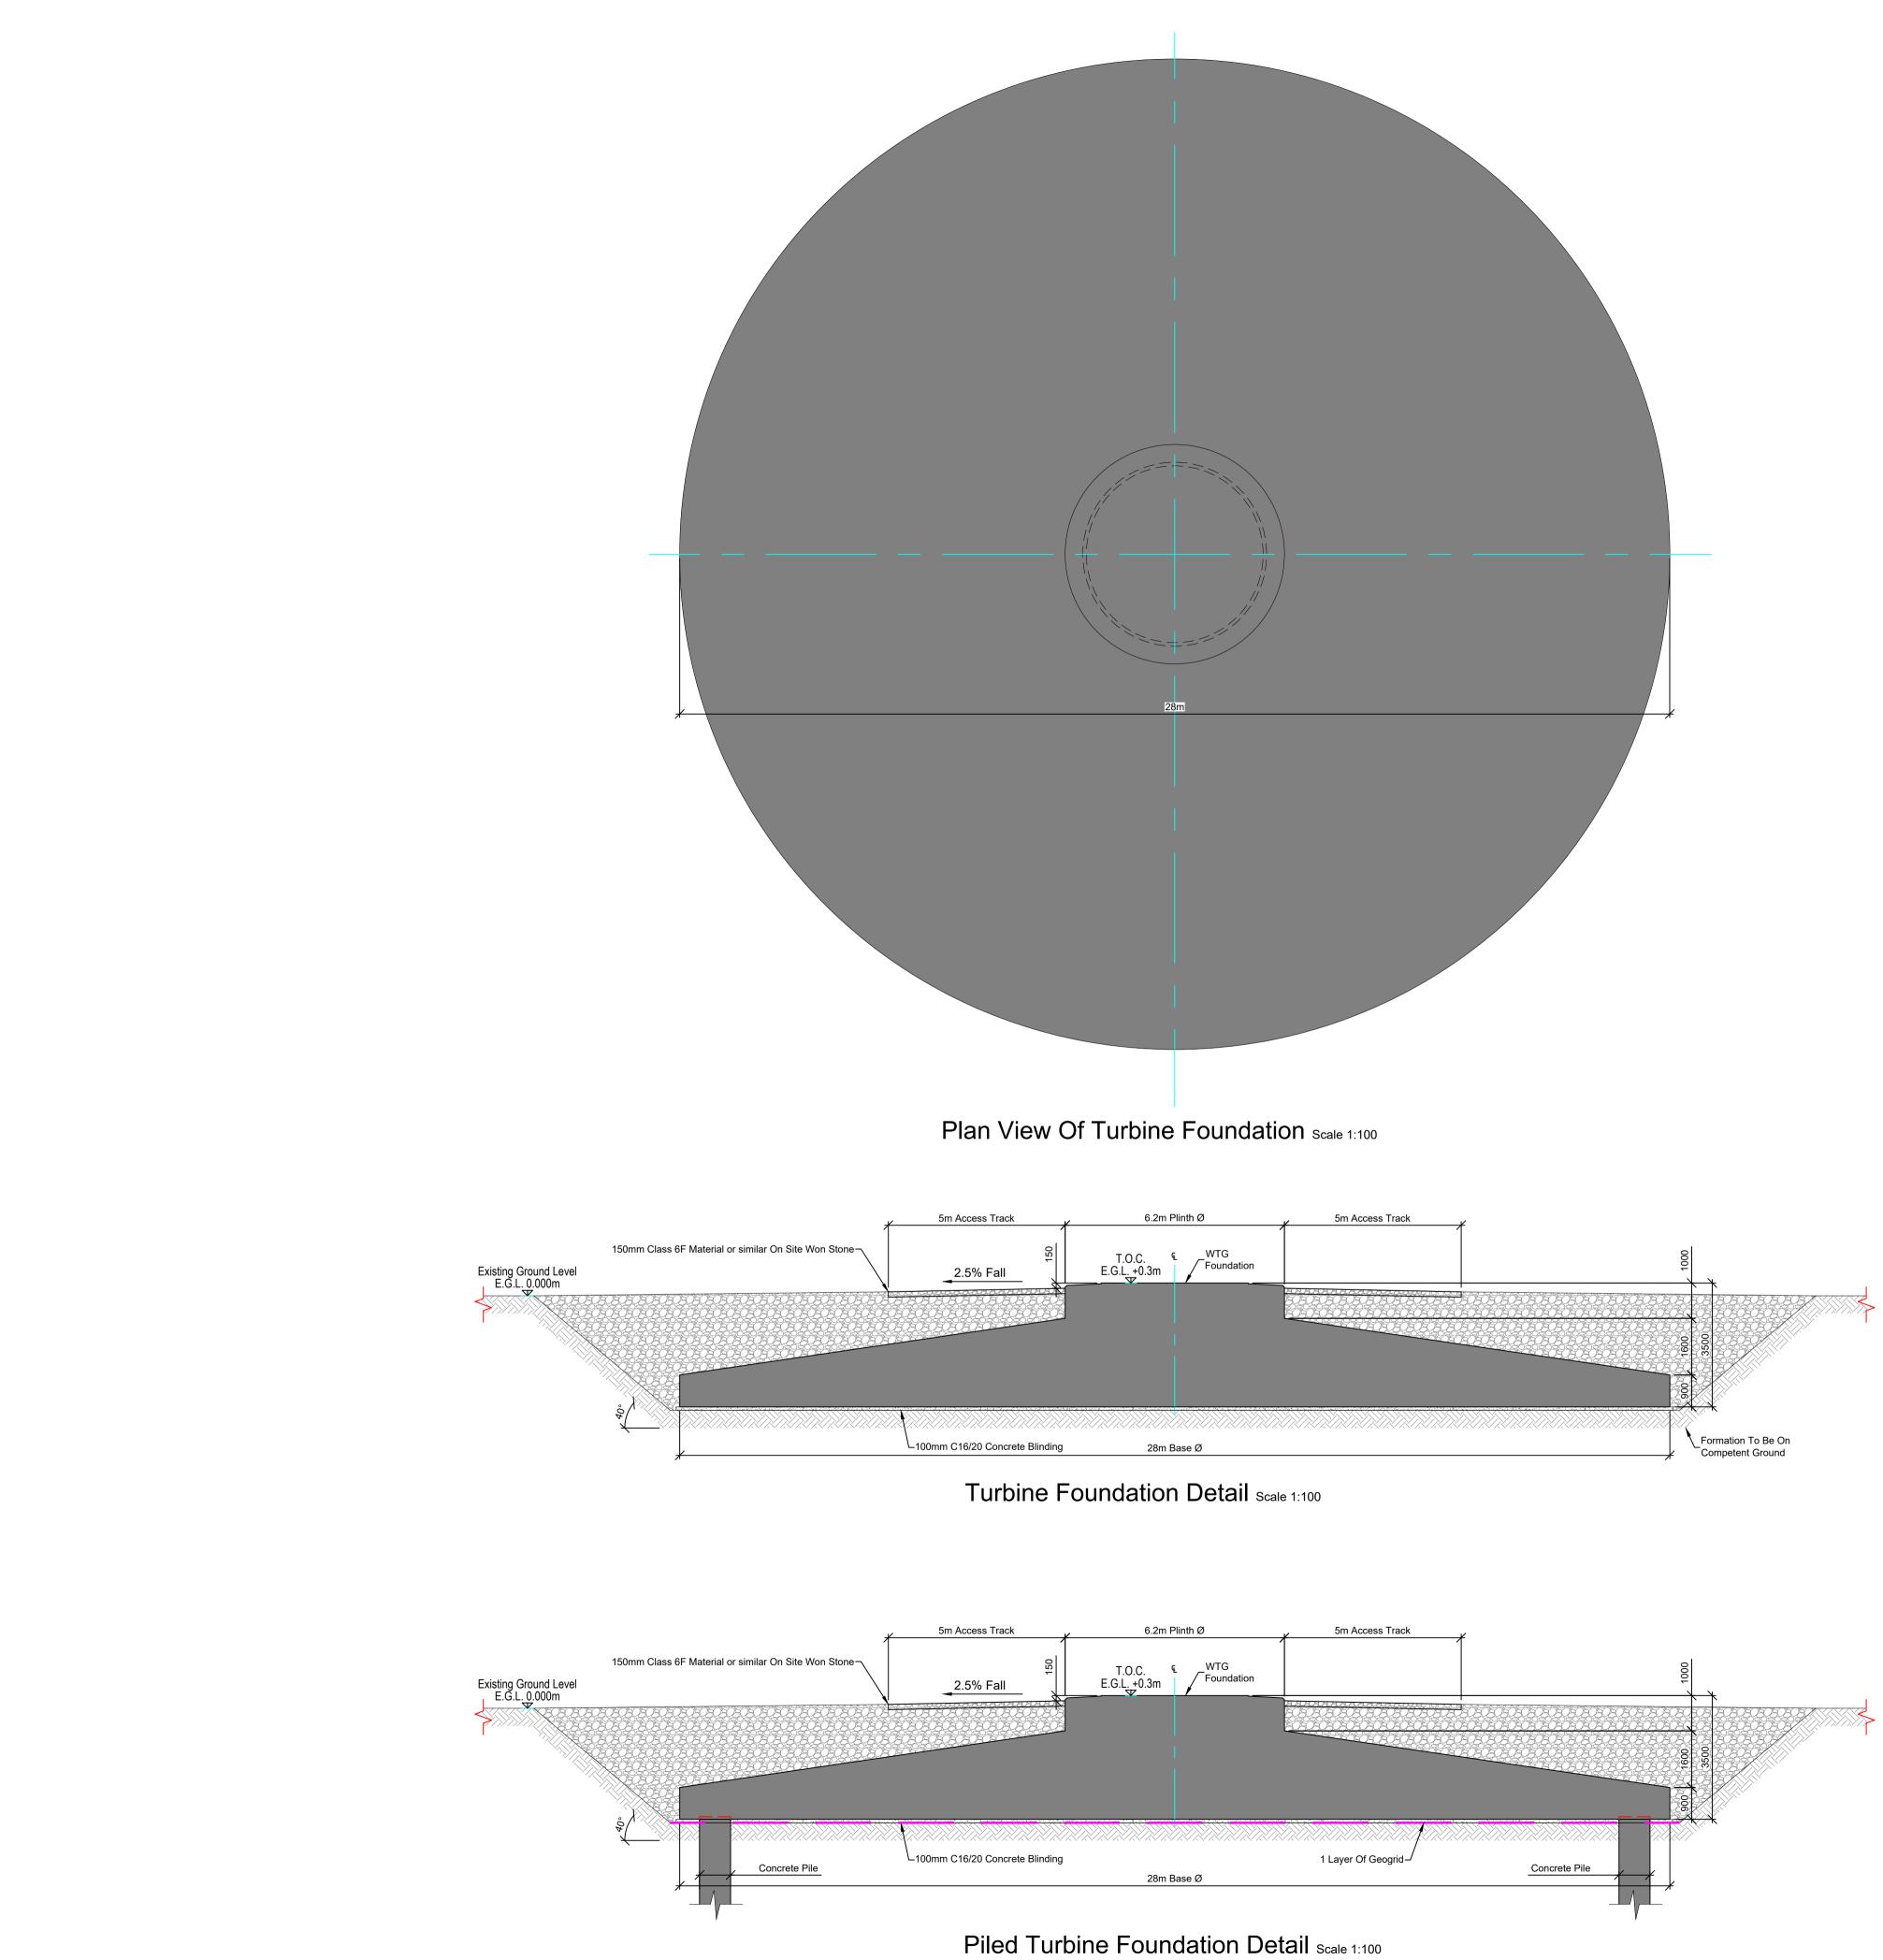

DO NOT SCALE FROM THIS DRAWING. USE FIGURED DIMENSION VERIFY DIMENSIONS ON SITE AND REPORT ANY DISCREPA DESIGNERS IMMEDIATELY. THIS DRAWING TO BE READ IN CONJUNCTION WITH THE SPECIFICATION. © THIS DRAWING IS COPYRIGHT AND MAY ONLY BE REPROD DESIGNERS PERMISSION.	NCIES TO THE DESIGNERS
NOTES: 1. ALL DRAWINGS ARE TO BE READ IN CONJUNCTIO RELEVANT SPECIFICATIONS, BILLS OF QUANTITIE ARCHITECTURAL, SERVICES AND ENGINEERING I 2. ALL LEVELS ARE IN METRES RELATED TO ORDNA	es, Drawings.
MALIN HEAD. 3. ANY DISCREPANCIES BETWEEN THESE DOCUME	NTS SHALL BE
BROUGHT TO THE ATTENTION OF THE ENGINEER 4. DRAWINGS ARE NOT TO BE SCALED.	
 ALL DIMENSIONS ARE IN MILLIMETRES, UNLESS NOTHERWISE. SITE LAYOUT BASED ON VESTAS V136 TURBINE 	NOTED
SPECIFICATION. BLADE TIP HEIGHT = 158M (T10 IS HEIGHT = 90M AND BLADE LENGTH = 68M.	S 150M), HUB
DRAWING REFERENCE: 22156-MWP-00-00-DR-C-5005 Site Layout - Mast	er Sheet
P01 08.12.23 Issued For Planning REV DATE DESCRIPTION	JK PC BY APP
PROJECT: Ballycar Wind Farm	ВҮ АРР
TITLE: Turbine Foundation Details	
CLIENT:	
BALLYCAR Green Energy	
ENGINEERING AND ENVIRONMENTAL CONSUL) TANTS
	IMERICK mwp.ie
JK PC PROJECT NUMBER: DATE: SCALE @	OH A1:
22156 December 2023 A STATUS DESCRIPTION FOR INFORMATION	IS Shown STATUS: S2
DRAWING NUMBER:	REV:

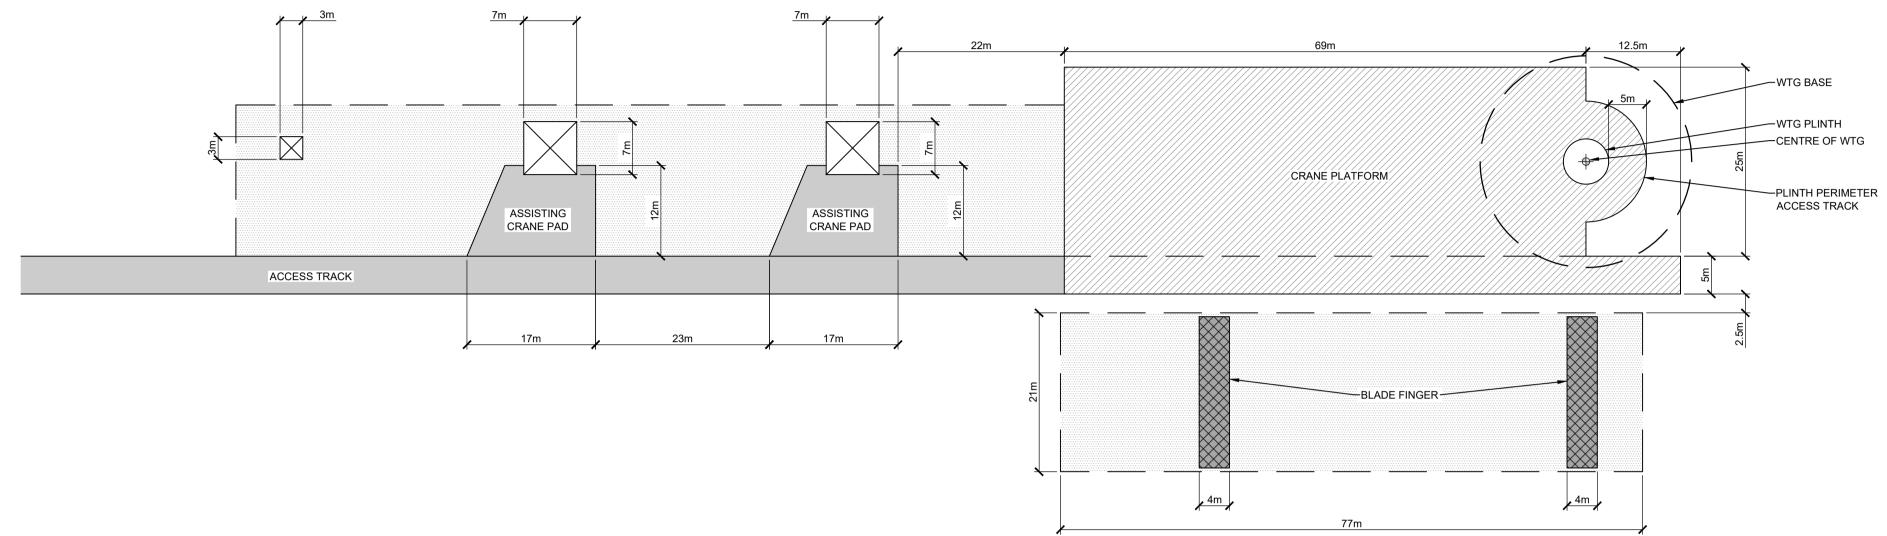


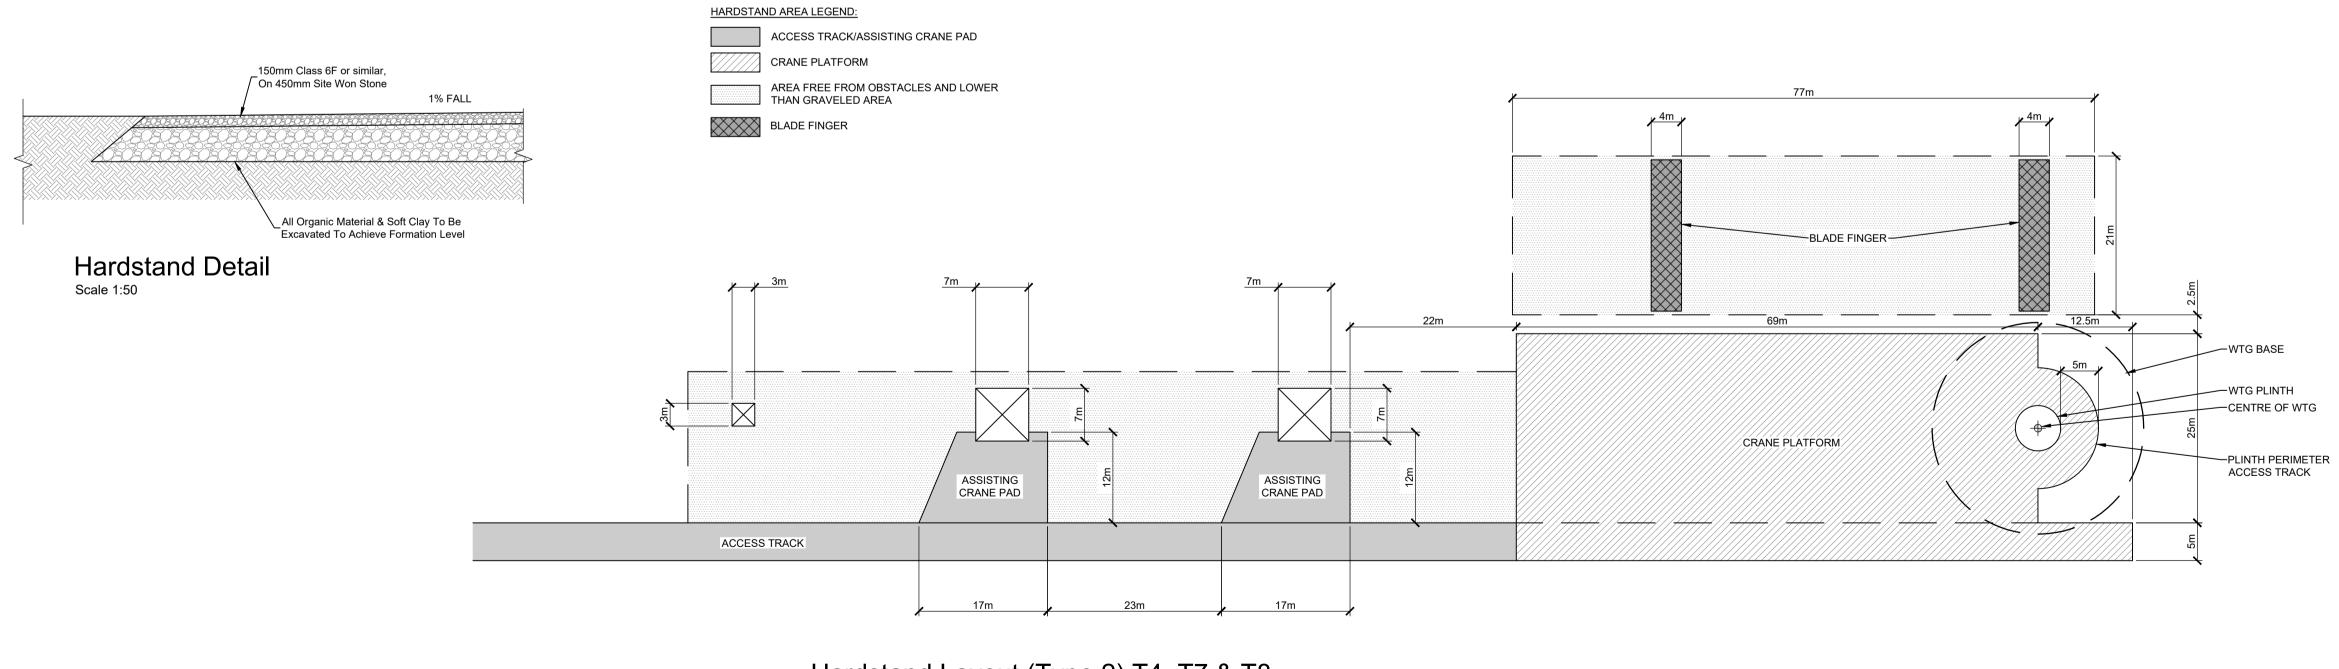



Hardstand Layout (Type 1) All Turbine Except T4, T7 & T8 Scale 1:500


Hardstand Layout (Type 2) T4, T7 & T8 Scale 1:500

NOT	HIS DRAV	VING IS COP		FICATION. D MAY ONLY BE	REPRODUC	SIGNER:	
	ES:		DESIGNER	S PERMISSION.			
	RELEVA	ANT SPECIE	FICATIONS	READ IN CONJ , BILLS OF QU S AND ENGINE	ANTITIES,		
	ALL LEV MALIN H		N METRES	RELATED TO	ORDNAN	CE DAT	UM
3.				een these d In of the en		S SHAL	L B
	ALL DIN			SCALED. .LIMETRES, UI	NLESS NO	TED	
6.		YOUT BAS		STAS V136 TU HEIGHT = 1581		50M) H	IIR
DRA	HEIGHT		D BLADE LI	ENGTH = 68M.			
2215	6-MWP-0	00-00-DR-C	-5005	Site Layo	ut - Master S	Sheet	
P01	08.12.23		Issued	For Planning		JK	P
P01 REV PROJE	DATE			For Planning SCRIPTION		JK BY	P
REV	DATE ECT:	vcar Win	DES	-			
REV	DATE ECT: Bally	vcar Win	DES	-			
REV	DATE ECT: Bally	rcar Win	d Farm	SCRIPTION			
REV PROJE	DATE Bally Turb		d Farm	SCRIPTION			
REV	DATE Bally Turb		d Farm	SCRIPTION			
REV PROJE	DATE Bally Turb		d Farm	SCRIPTION			
REV PROJE	DATE Bally Turb		d Farm	SCRIPTION			
REV PROJE	DATE Bally Turb		d Farm	SCRIPTION			
REV PROJE	DATE ECT: Bally Turb	ine Hard	d Farm	Details		BY	
REV PROJE	DATE ECT: Bally Turb	ine Hard	d Farm	Details	LIME	BY	
REV PROJE	DATE ECT: Bally Turb	ine Hard	d Farm		APPROVED:	NTS RICK vp.ie	
REV PROJE		ine Hard	DES d Farm dstand [dstand [and envi tralee checked: date:	Details	APPROVED: SCALE @ A1:	BY NTS RICK vp.ie OH	
REV PROJE	DATE ECT: Bally Turb T: T: UN: JK	ine Hard	DES d Farm dstand [dstand [and envi tralee checked: date:		LIME mv APPROVED: SCALE @ A1: 1	BY NTS RICK vp.ie OH	-

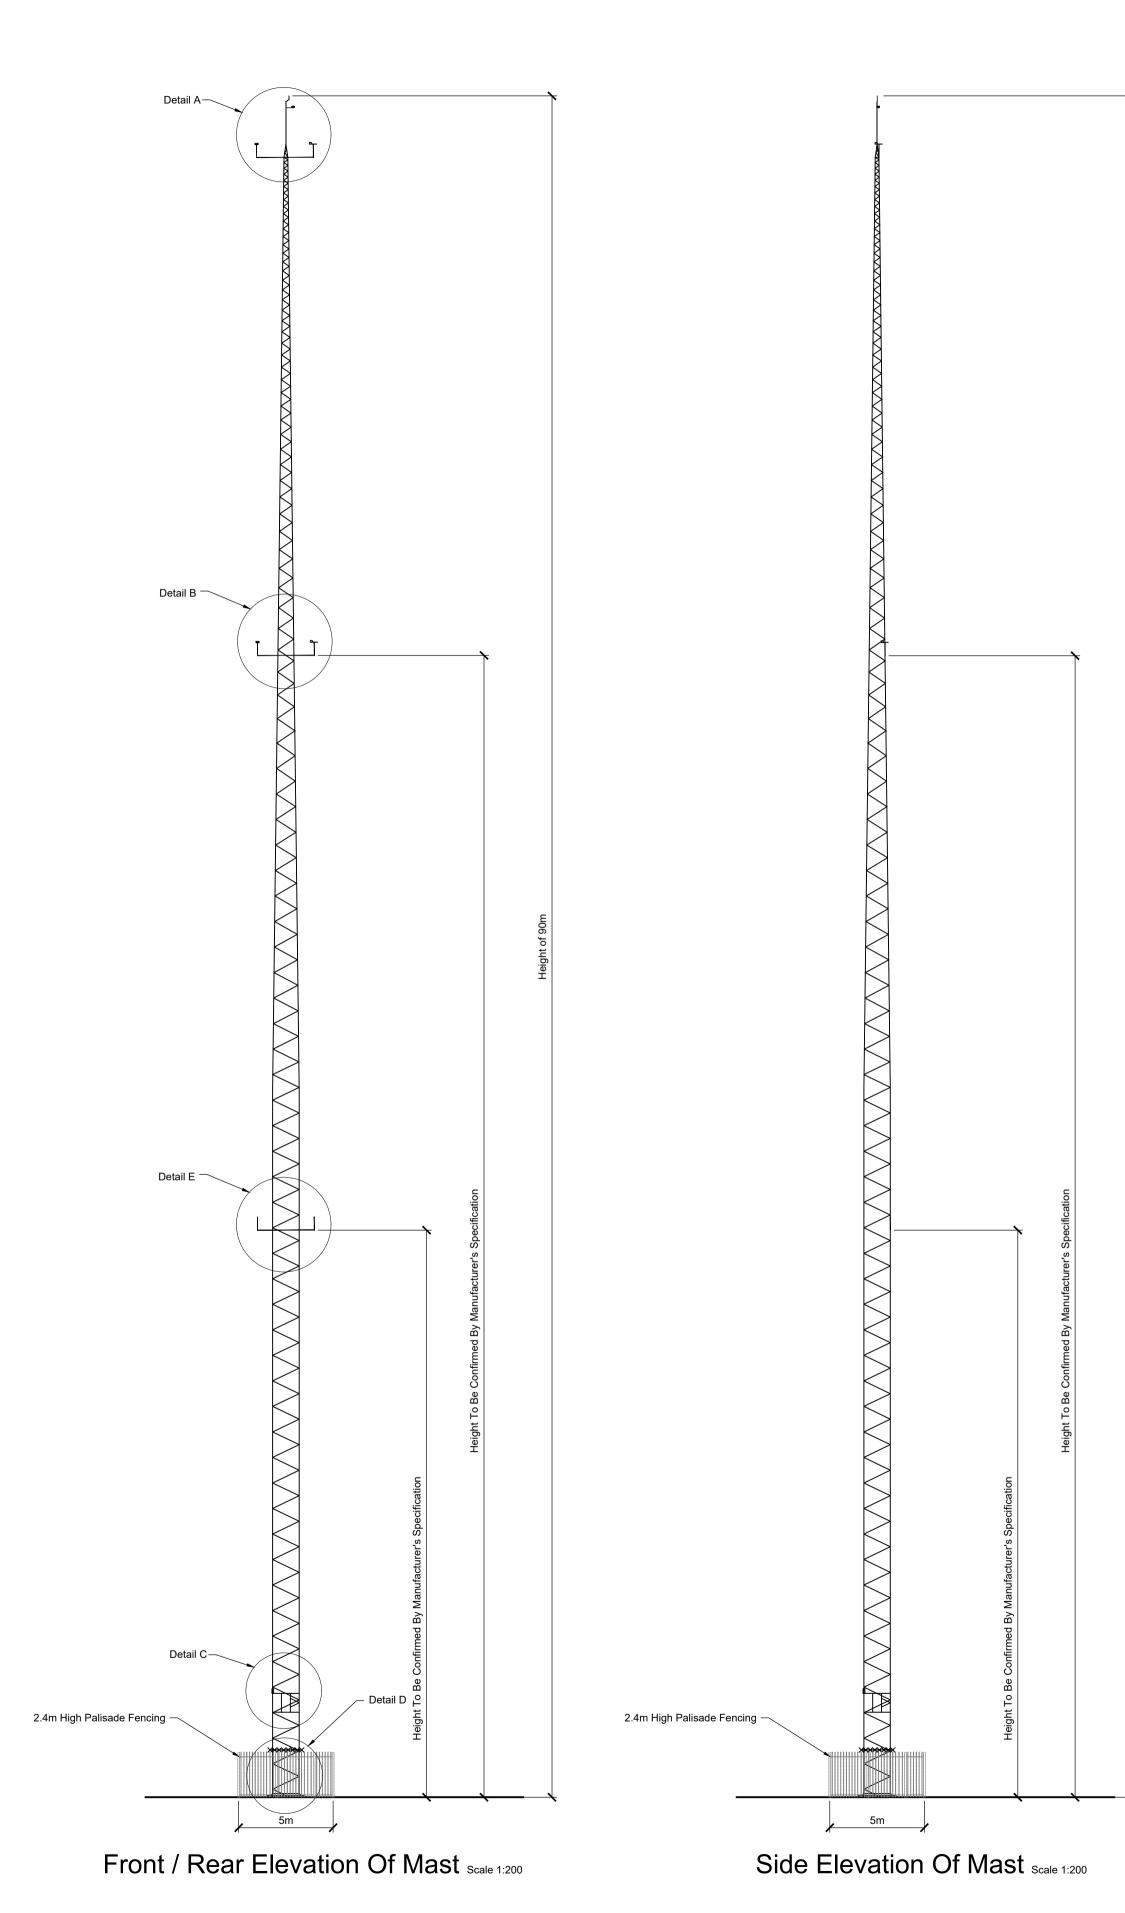

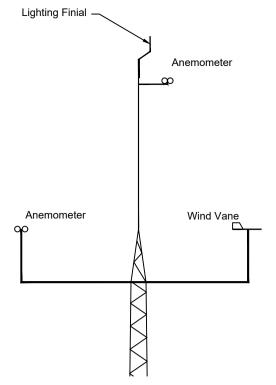


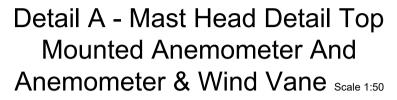

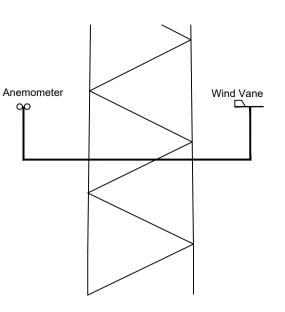


Meteorological Cabinet Together With Rain Collector And — Temperature Sensor Mounted On Beam With Fixture



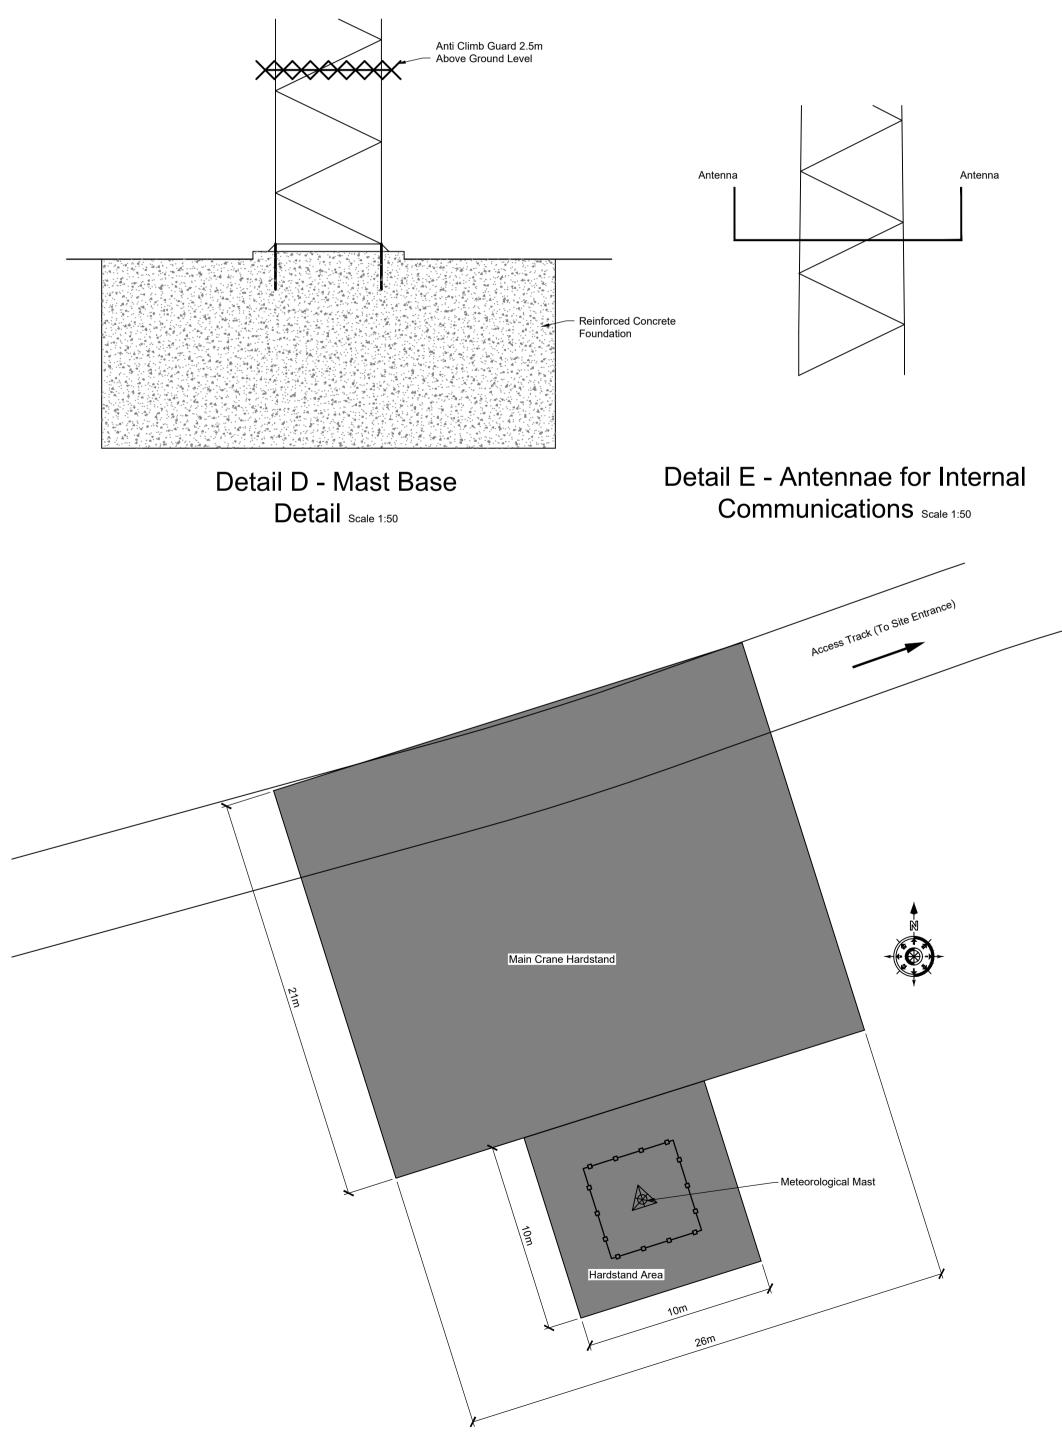



Meteorological Mast Layout Scale 1:200

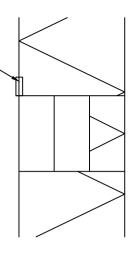


Detail C Scale 1:50


DO NOT SCALE FROM THIS DRAWING. USE FIGURED DIMENSIO VERIFY DIMENSIONS ON SITE AND REPORT ANY DISCREPA DESIGNERS IMMEDIATELY.	
THIS DRAWING TO BE READ IN CONJUNCTION WITH THE SPECIFICATION. © THIS DRAWING IS COPYRIGHT AND MAY ONLY BE REPRODU DESIGNERS PERMISSION.	
NOTES: 1. ALL DRAWINGS ARE TO BE READ IN CONJUNCTIO	N WITH ALL
RELEVANT SPECIFICATIONS, BILLS OF QUANTITIE ARCHITECTURAL, SERVICES AND ENGINEERING D	
2. ALL LEVELS ARE IN METRES RELATED TO ORDNA MALIN HEAD.	NCE DATUM
3. ANY DISCREPANCIES BETWEEN THESE DOCUMER BROUGHT TO THE ATTENTION OF THE ENGINEER	
 DRAWINGS ARE NOT TO BE SCALED. ALL DIMENSIONS ARE IN MILLIMETRES, UNLESS N 	IOTED
OTHERWISE.	
DRAWING REFERENCE: 22156-MWP-00-00-DR-C-5005 Site Layout - Master	er Sheet
KEY PLAN	
Meteorological	
Mast Location	
(Barriel Contraction of the Cont	, v
P01 08.12.23 Issued For Planning REV DATE DESCRIPTION	JK PC BY APP
Ballycar Wind Farm	
TITLE:	
Met Mast Details	
CLIENT:	
BALLYCAR Green Energy	
ENGINEERING AND ENVIRONMENTAL CONSULT	TANTS MERICK
DRAWN: CHECKED: APPROVE	mwp.ie
JK PC PROJECT NUMBER: DATE: SCALE @	
22156 December 2023 A STATUS DESCRIPTION FOR INFORMATION	IS Shown STATUS: S2
DRAWING NUMBER: 22156 - MWP - 00 - 00 - DR-C- 5404	REV:
22130-111117 - 00-00-DK-6-3404	P01

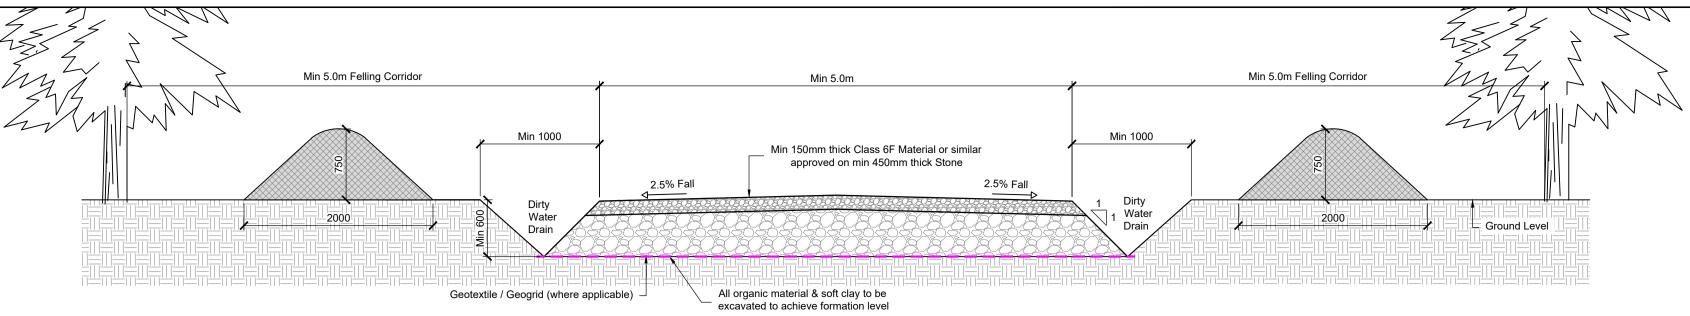


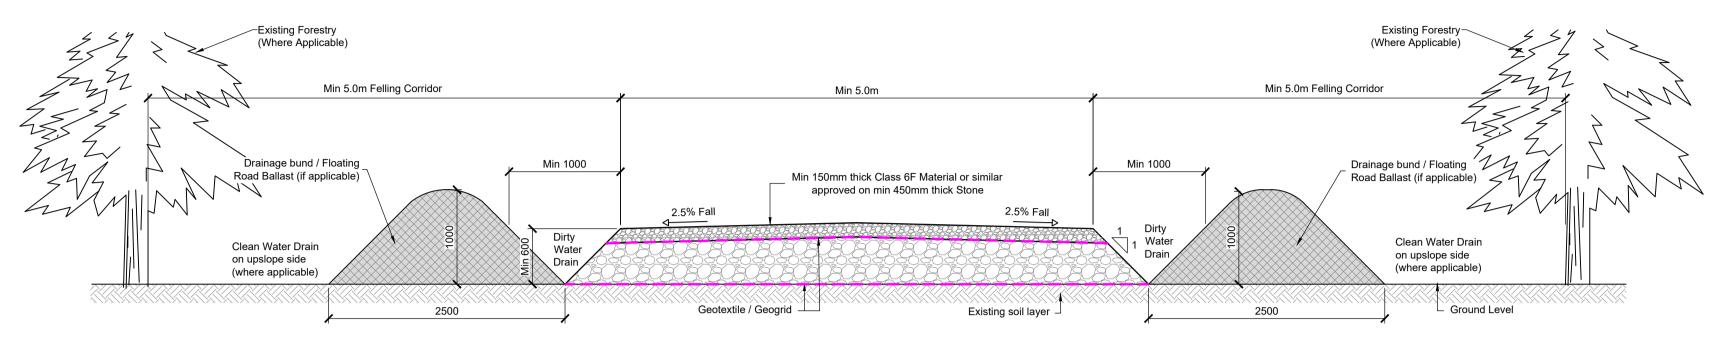



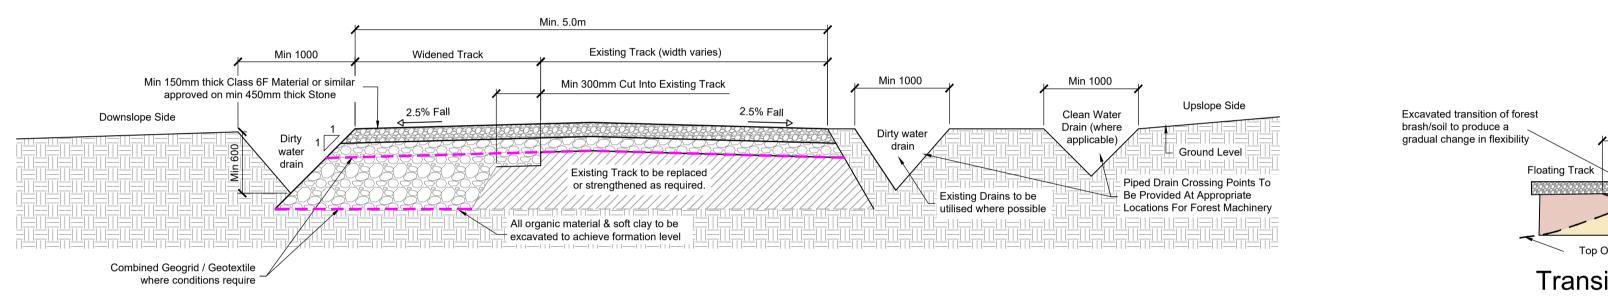

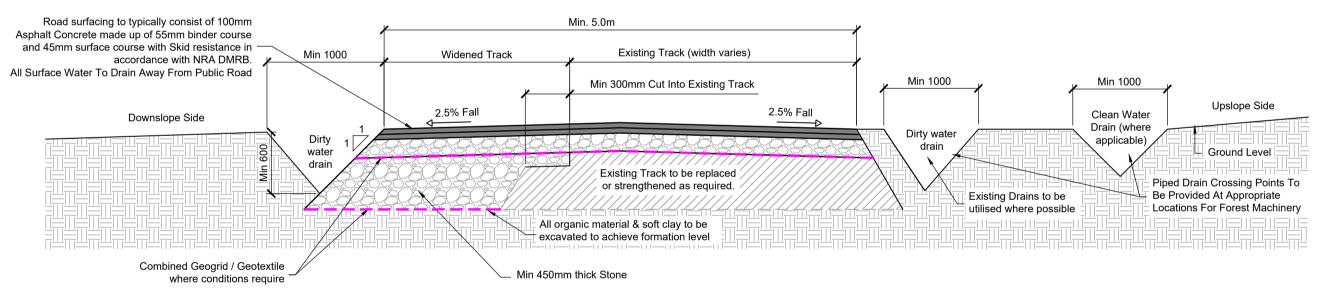

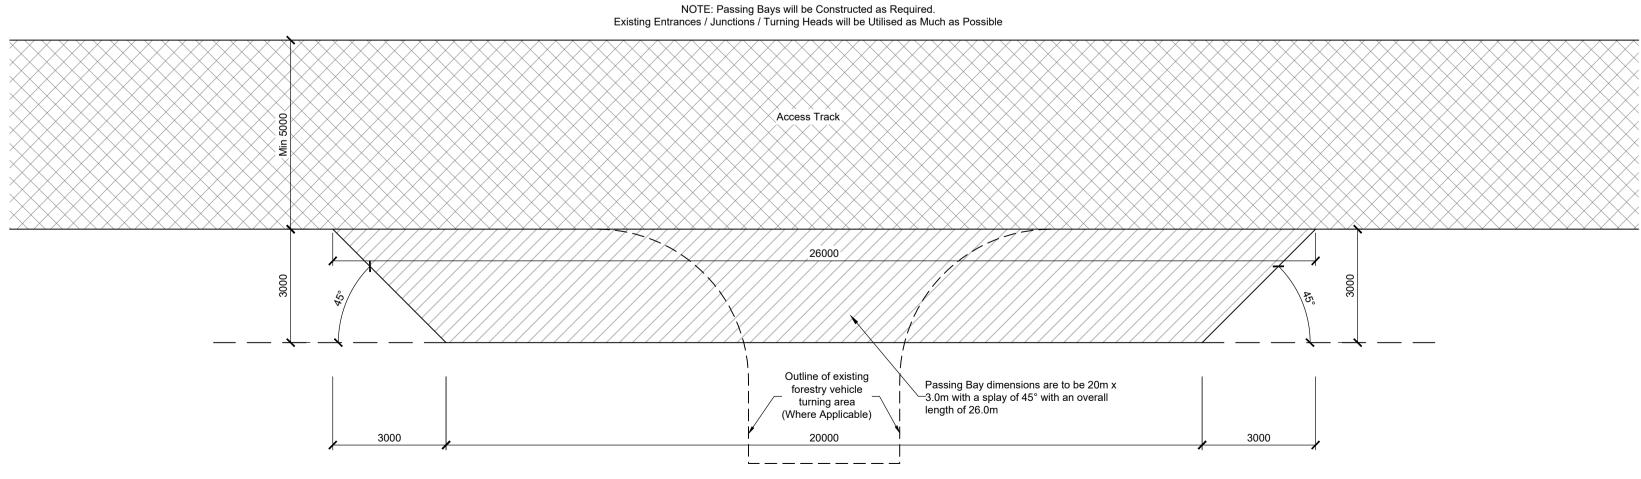

Access Track Type 1 - Excavated Access Track Detailscale 1:40

Access Track Type 2 - Floating Access Track Detail Scale 1:40


Access Track Type 3 - Detail for Upgrading / Widening Existing Track Scale 1:40


Top Of Mineral Soil Transition From Floating To Solid Access Track Not To Scale


Access Track Type 4 - Detail for Upgrading / Widening Existing Track (Bitumen Surface) Scale 1:40

Passing Bay Plan Detail Scale 1:100

VER	T SCALE FROM THIS RIFY DIMENSIONS C HIS DRAWING TO E S DRAWING IS COF	ON SITE AND RE DESIGNERS IN E READ IN COM SPECIFIC	EPORT ANY DIS MEDIATELY. NJUNCTION WI CATION. MAY ONLY BE F	SCREPAN	CIES TO THE
R	S: LL DRAWINGS A ELEVANT SPECI RCHITECTURAL,	FICATIONS, E	BILLS OF QUA	NTITIES	3
	LL LEVELS ARE ALIN HEAD.	IN METRES R	ELATED TO	ORDNAN	CE DATUM
	NY DISCREPANO ROUGHT TO THE				TS SHALL BE
	RAWINGS ARE N				
0	LL DIMENSIONS THERWISE.		METRES, UN	LESS NC	DTED
22156-	ING REFERENCE MWP-00-00-DR-C MWP-00-00-DR-C	-5005	Site Layou Drainage Lay		
	DATE		Pr Planning		JK PC BY APF
PROJECT	[⊪] Ballycar Win	d Farm			
	, i i i i i				
TITLE:	Access Trac	k Details			
	Access Trac	k Details			
	BALLYCA	R			
	TT-	R		P	
	BALLYCA		DNMENTAL CO LONDON		NTS ERICK
			LONDON	LIM	ERICK wp.ie
CLIENT:		AND ENVIRO TRALEE	LONDON	LIM rr	ERICK Iwp.ie OH
CLIENT: DRAWN: PROJECT	BALLYCA Green Energy ENGINEERING CORK	AND ENVIRO TRALEE	LONDON C	LIM M APPROVED SCALE @ A As	ERICK Iwp.ie OH

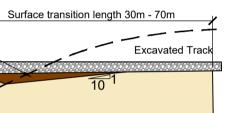

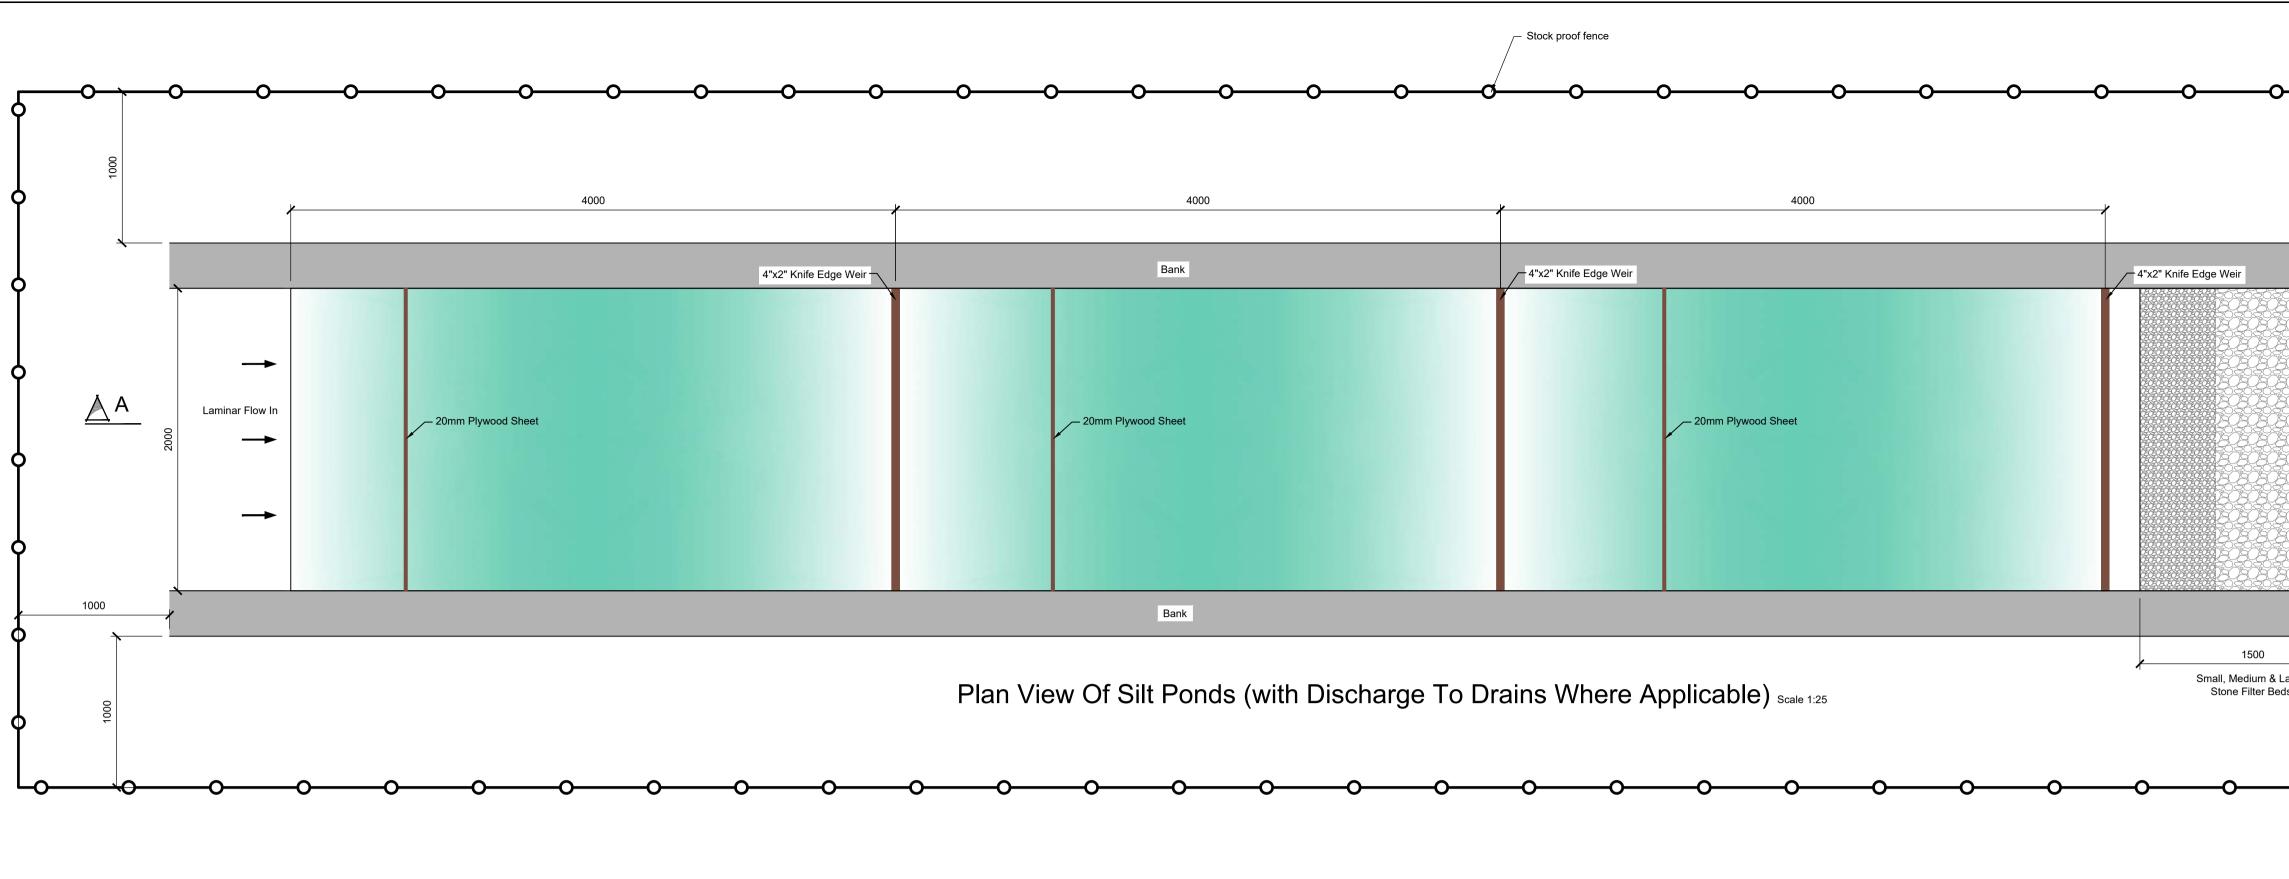

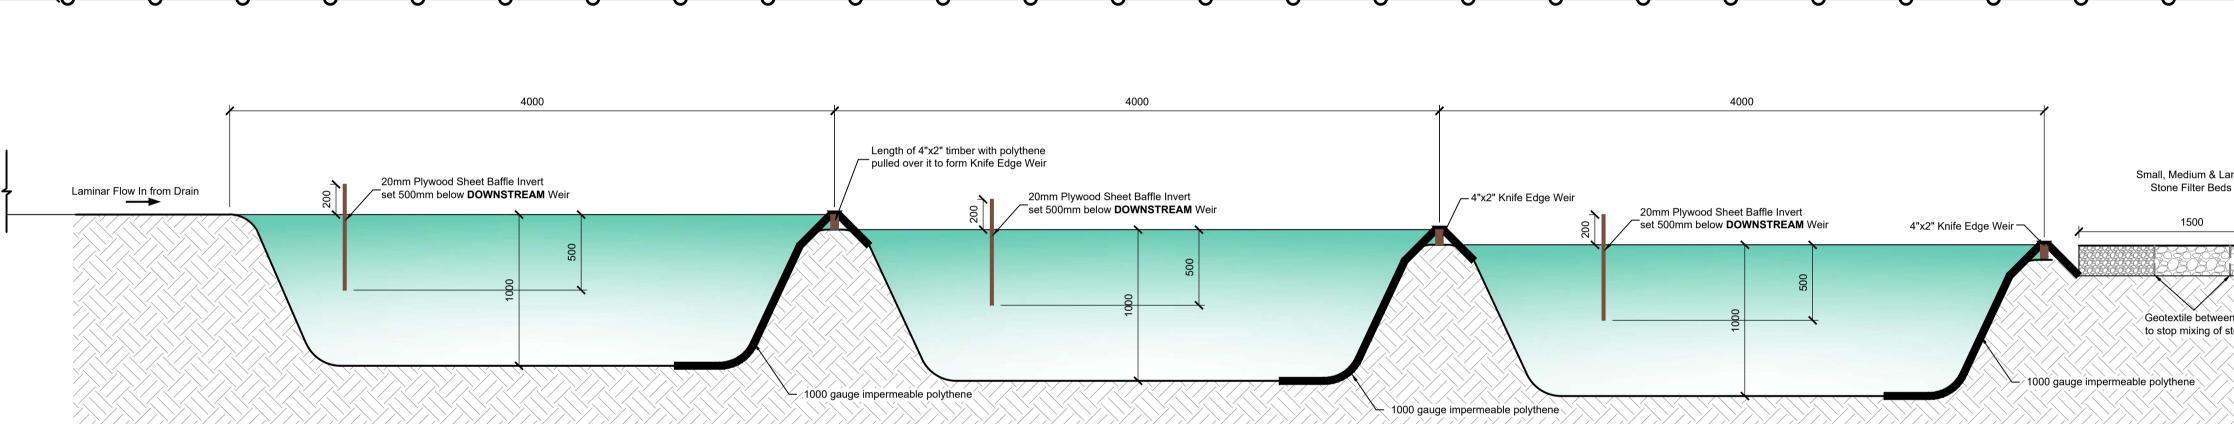




Baffle/Weir Detail


Sediment Fence Detail Scale 1:20


Section A-A Scale 1:25

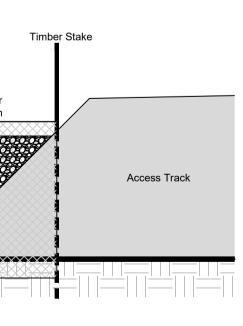






Completed Settling Pond System

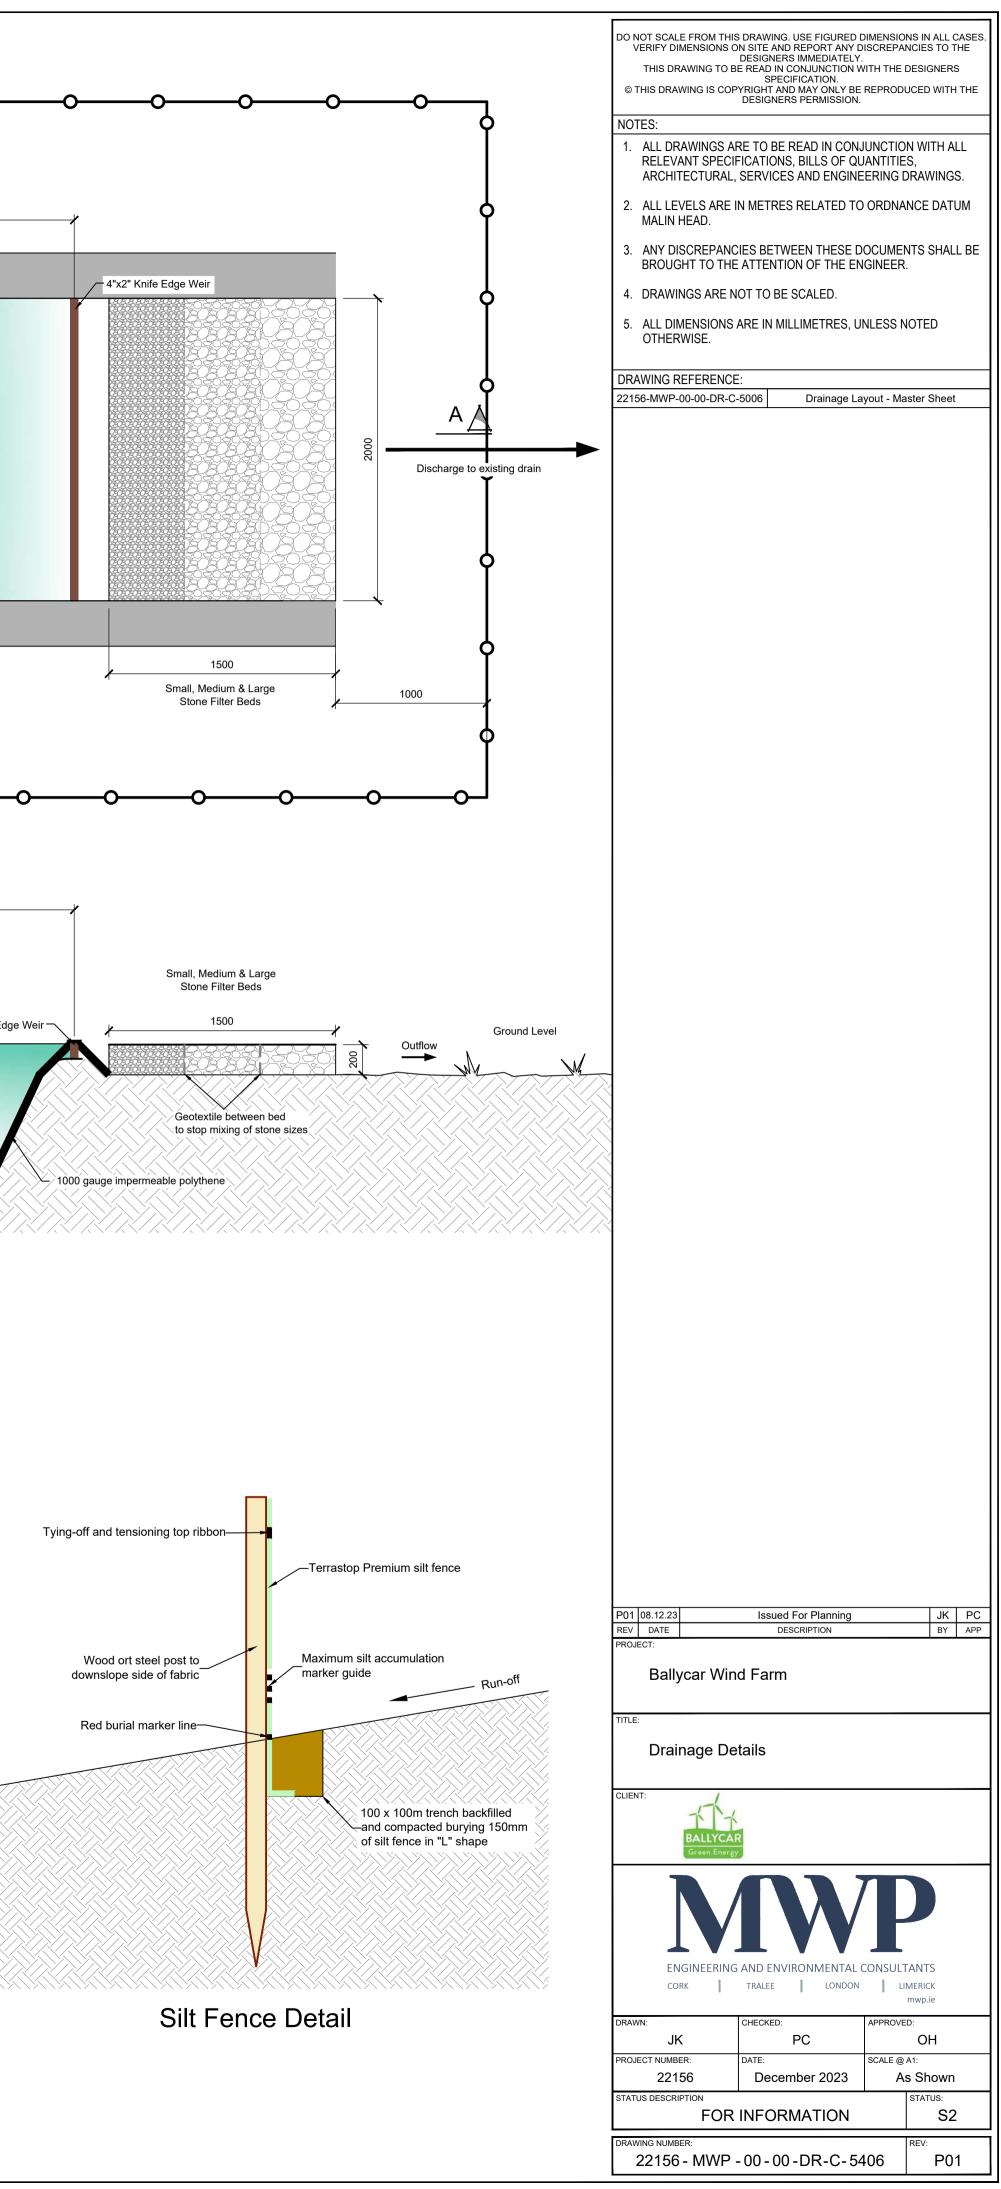


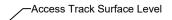

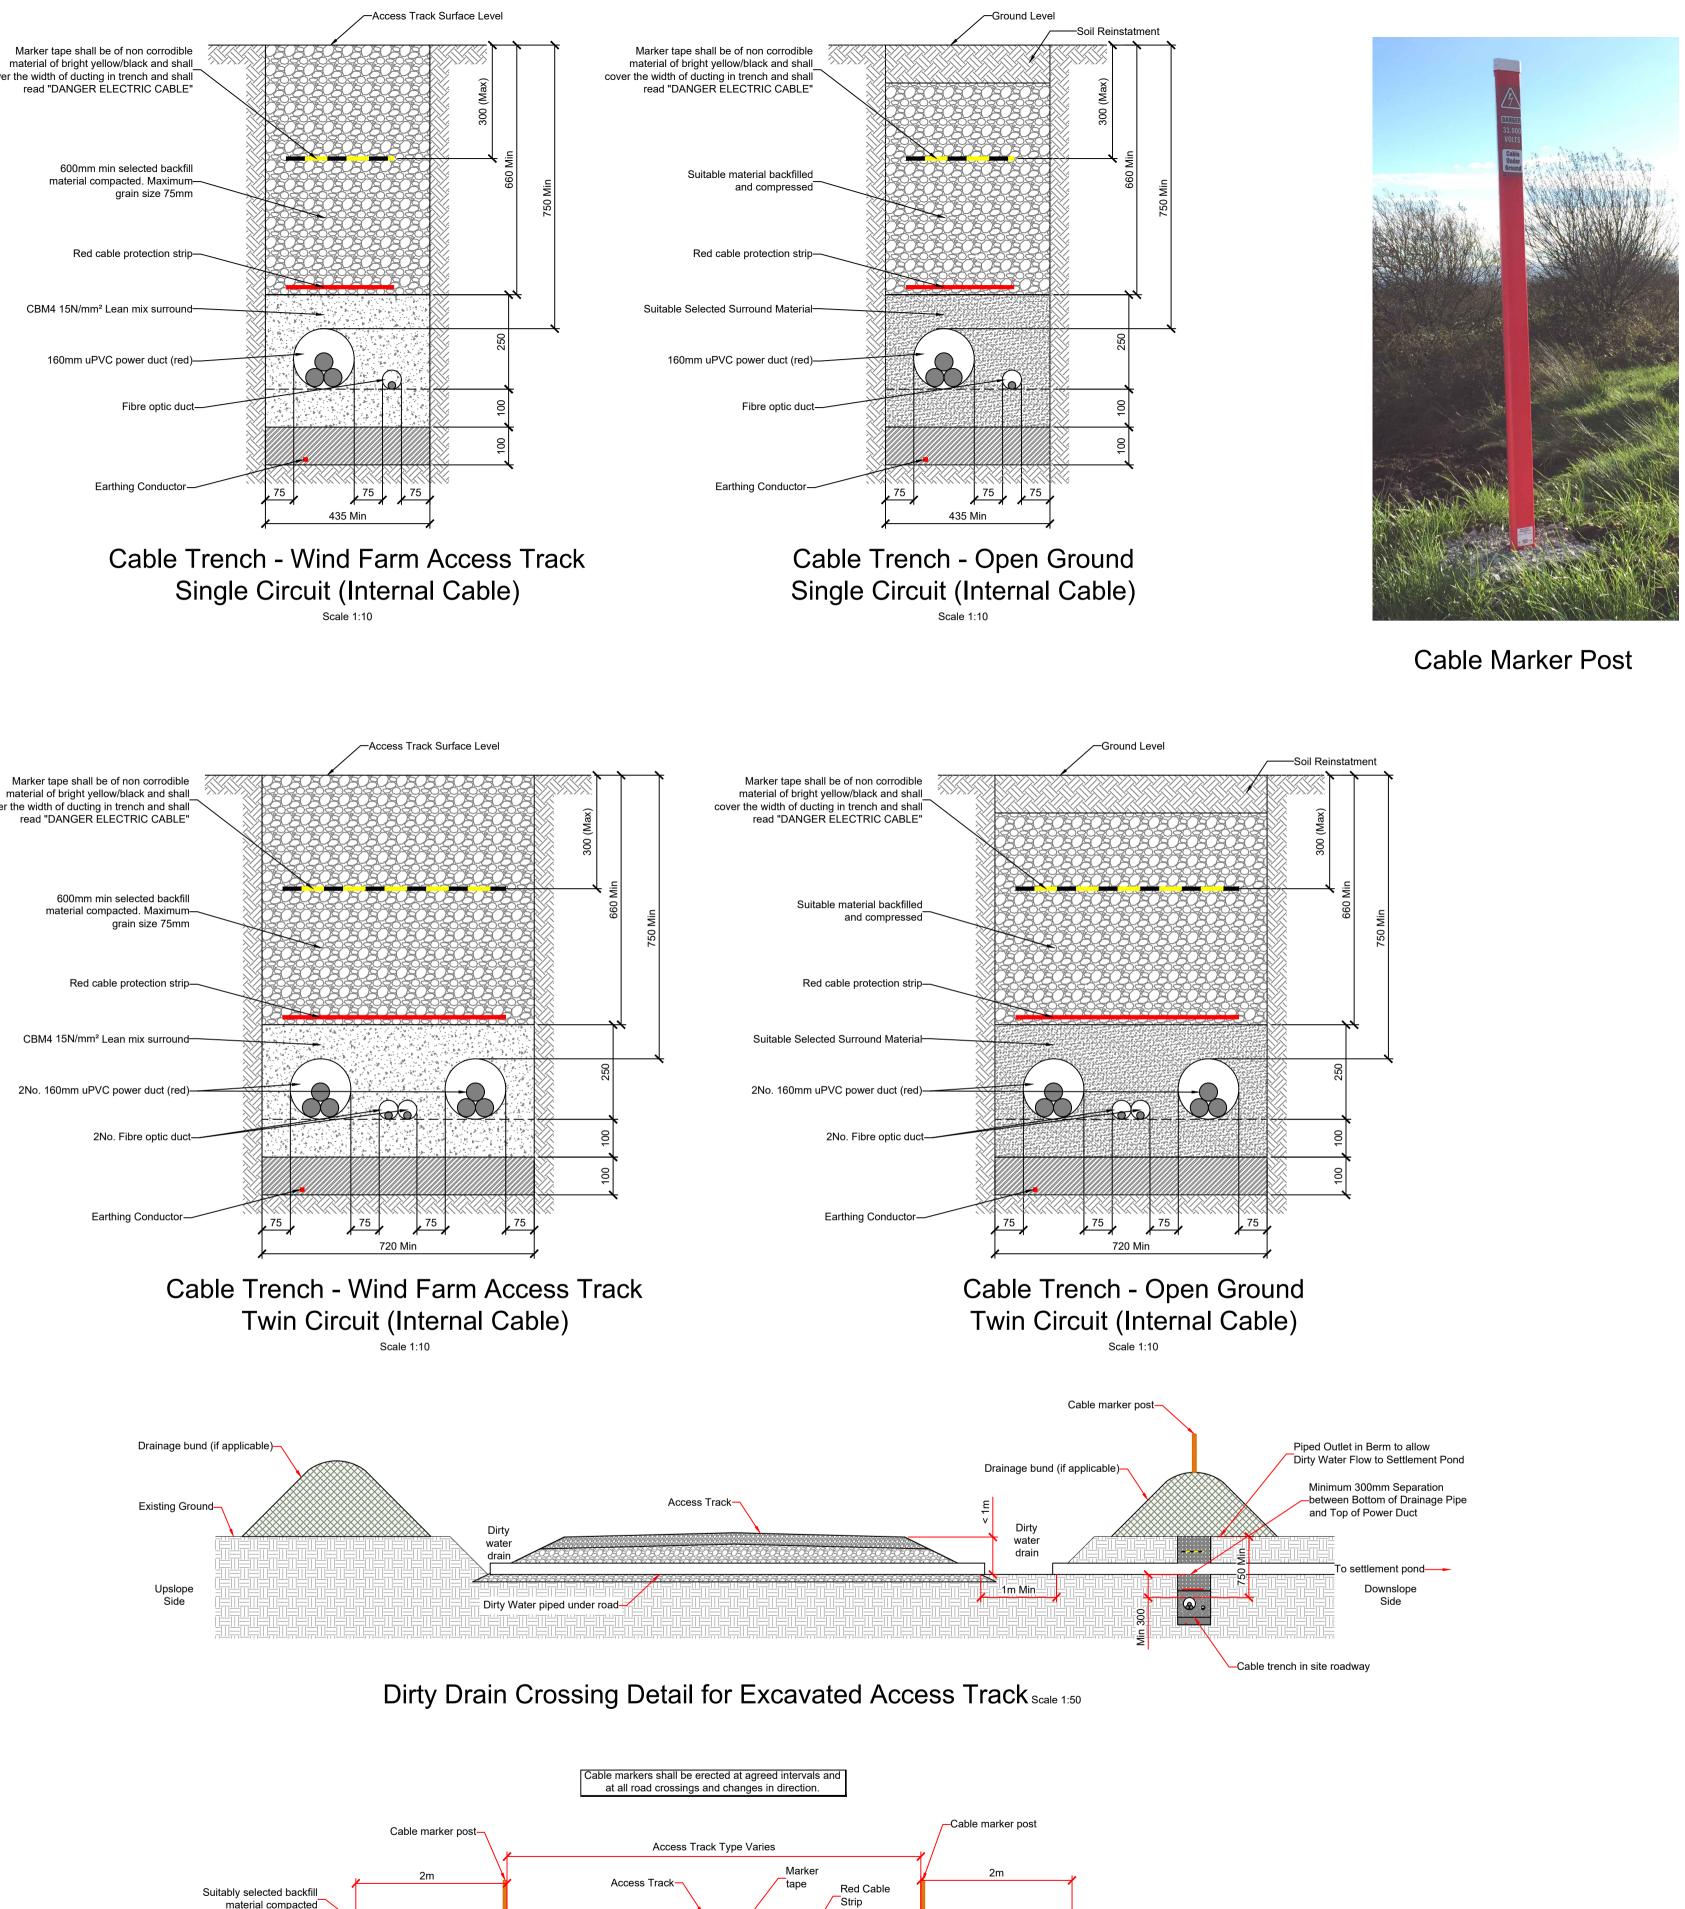

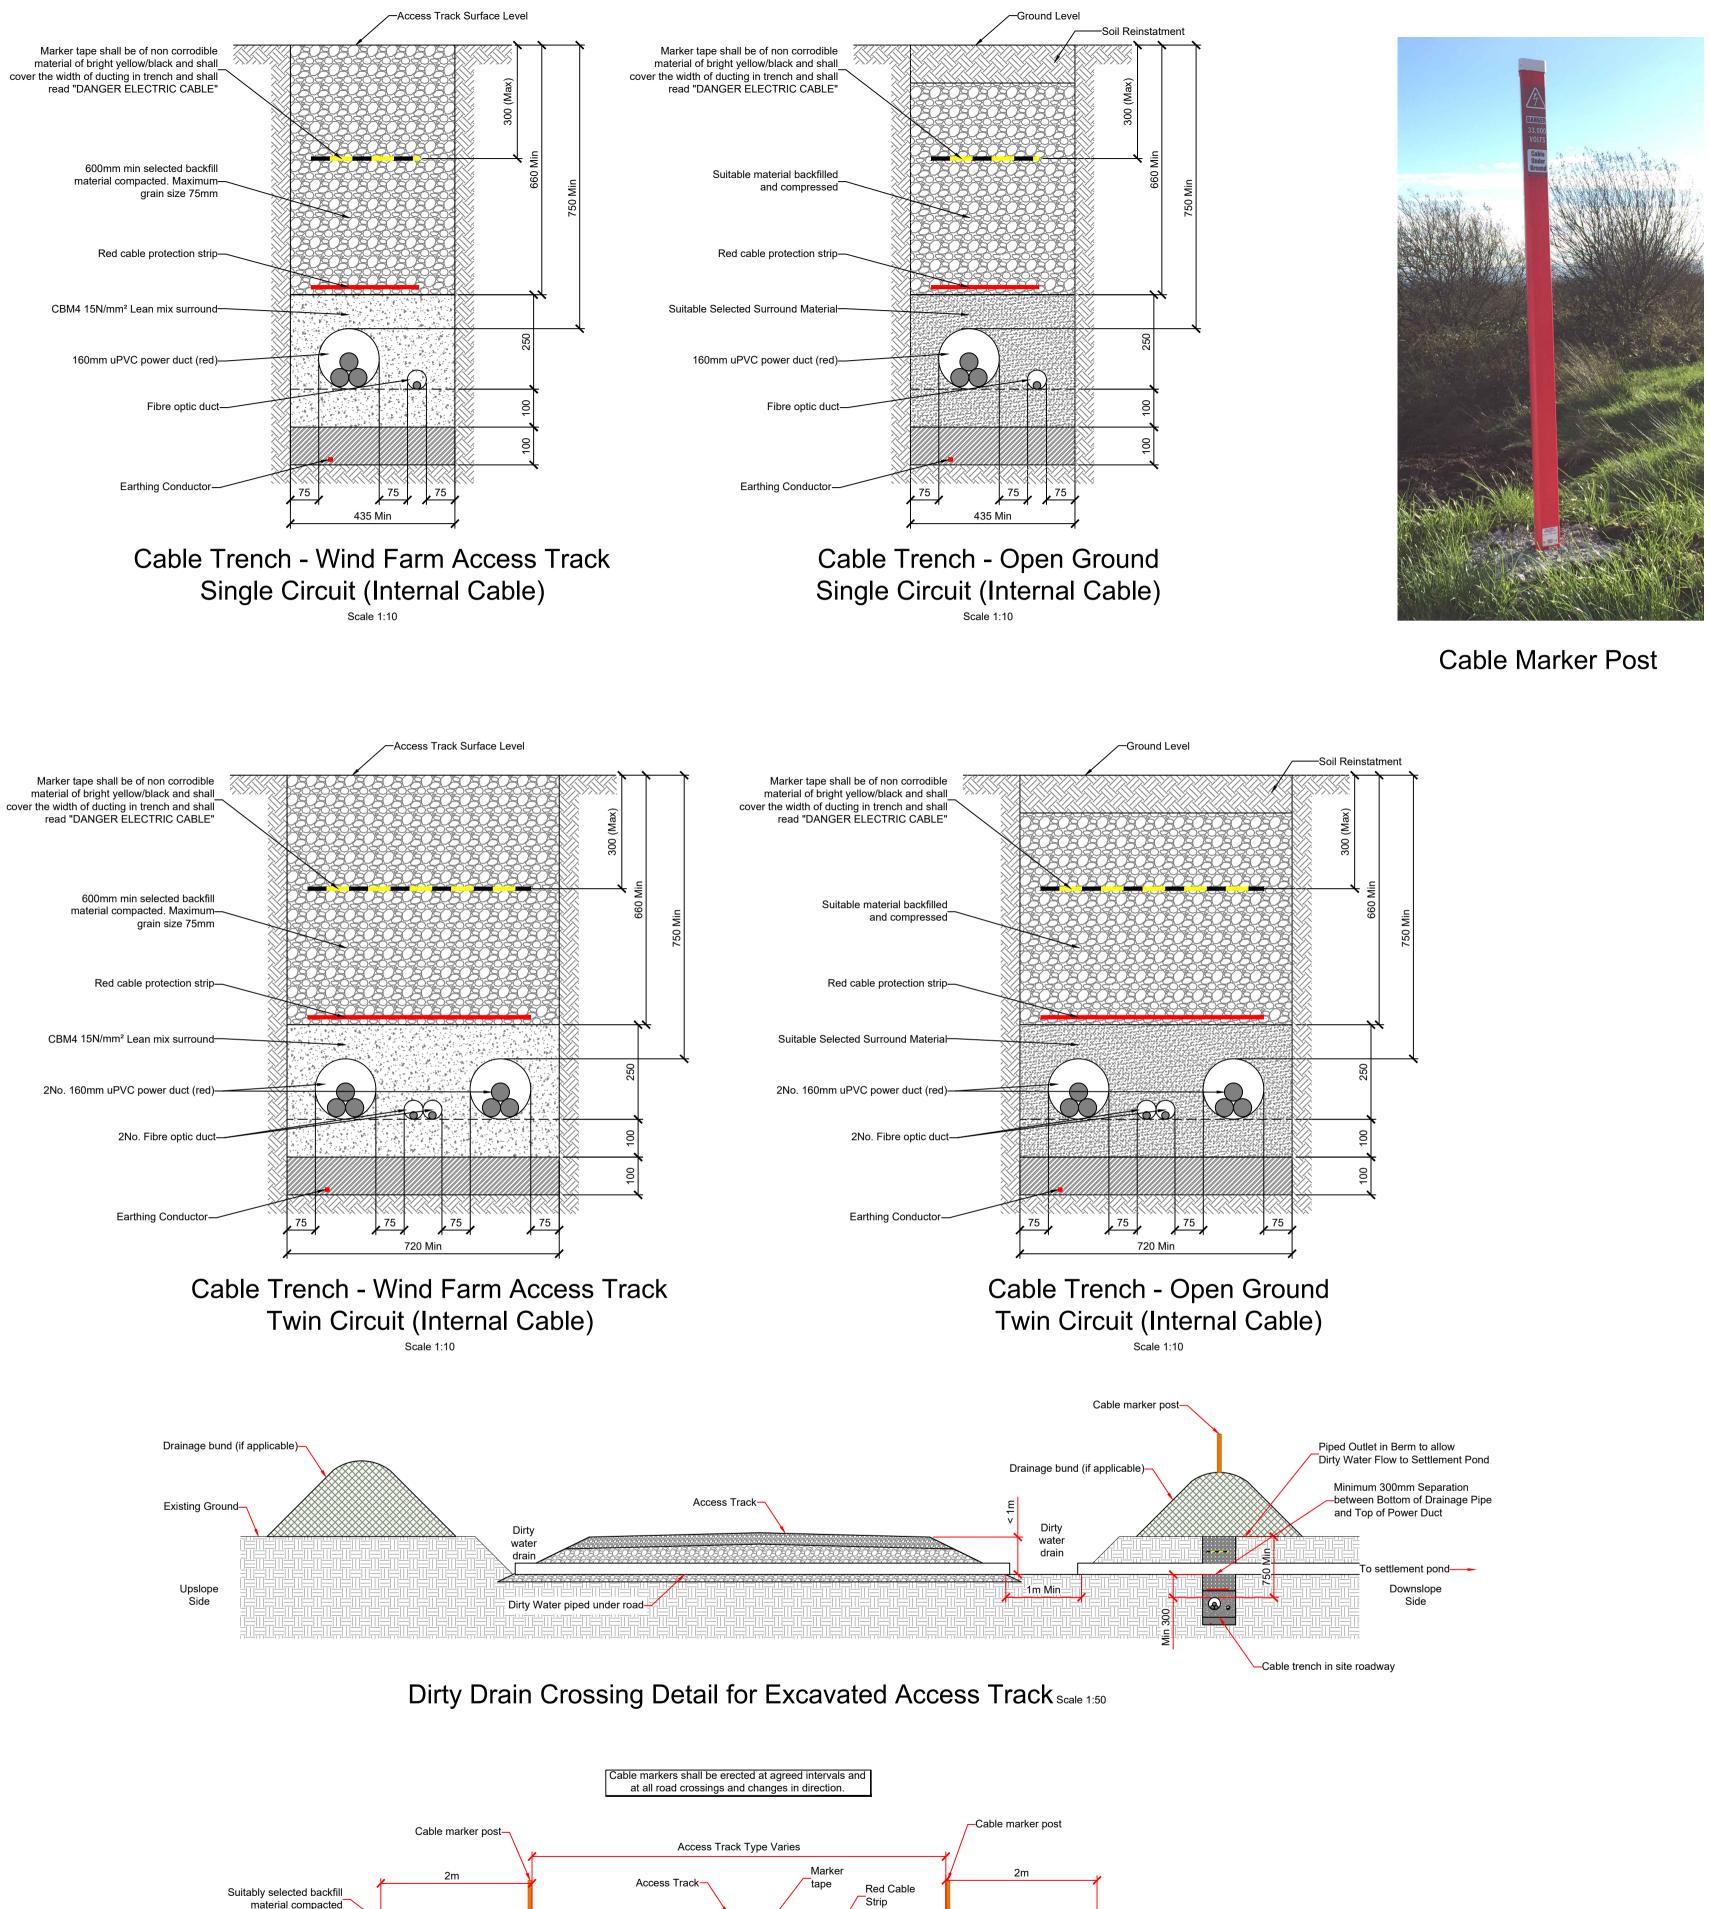

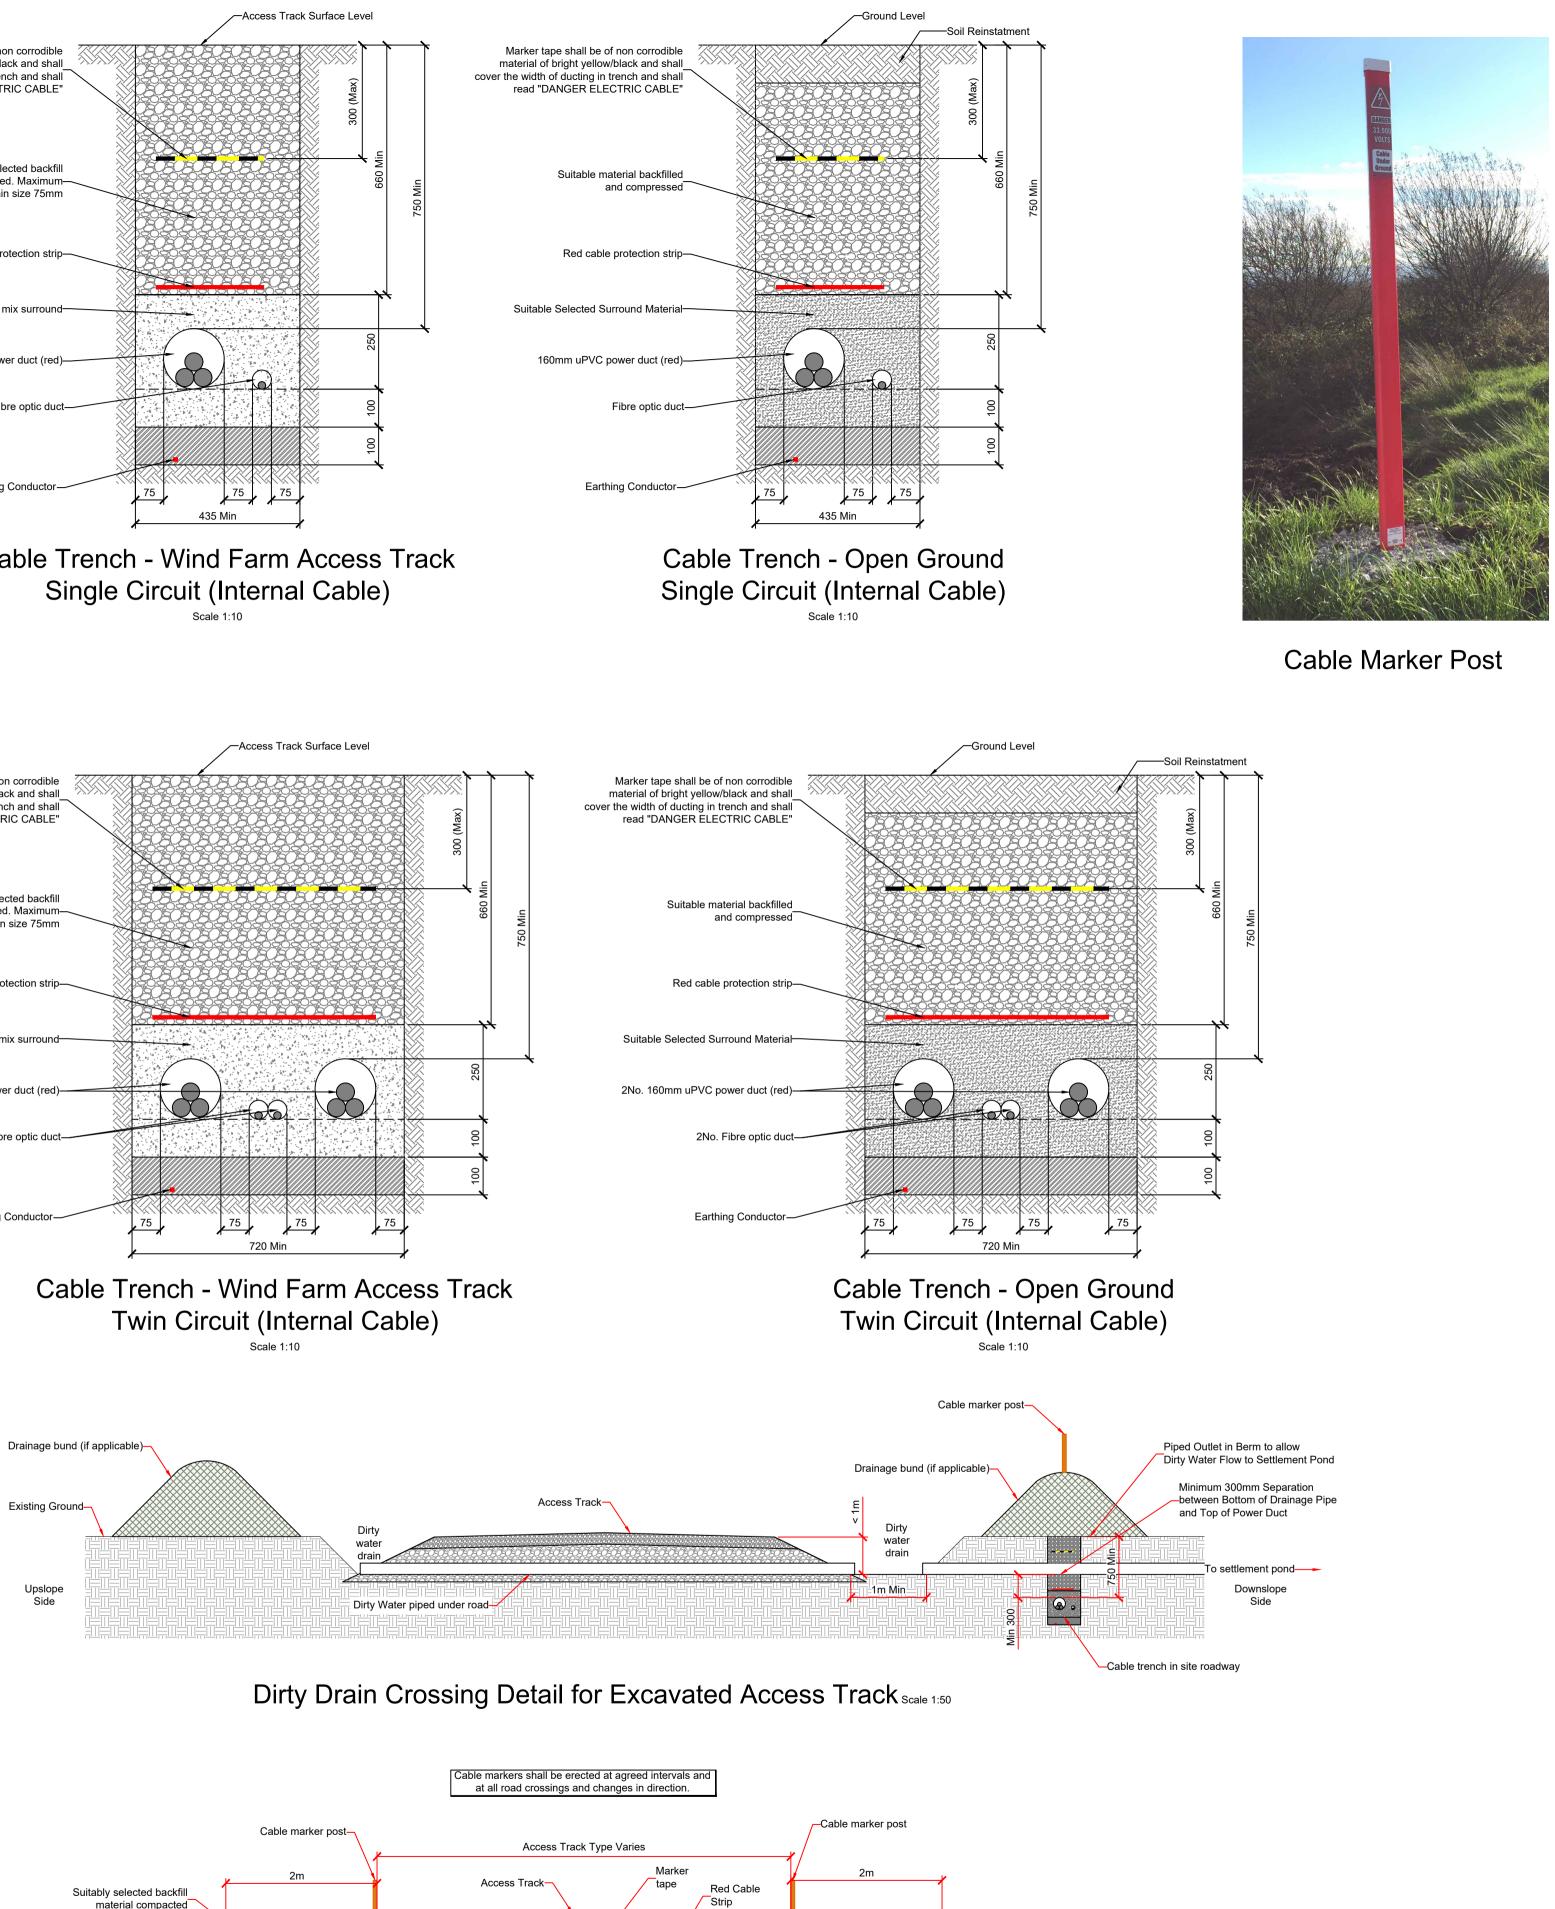


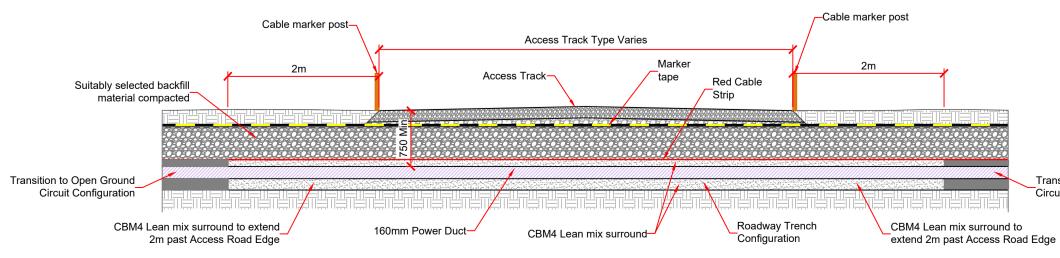



Cable Trench Crossing Detail under Access Track Scale 1:50

Transition to Open Ground Circuit Configuration


DO NOT SCALE FROM THIS DRAWING. USE FIGURED DIMENSIO VERIFY DIMENSIONS ON SITE AND REPORT ANY DISCREPA DESIGNERS IMMEDIATELY. THIS DRAWING TO BE READ IN CONJUNCTION WITH THE SPECIFICATION. © THIS DRAWING IS COPYRIGHT AND MAY ONLY BE REPROD DESIGNERS PERMISSION.	NCIES TO THE DESIGNERS
NOTES: 1. ALL DRAWINGS ARE TO BE READ IN CONJUNCTIO RELEVANT SPECIFICATIONS, BILLS OF QUANTITIE ARCHITECTURAL, SERVICES AND ENGINEERING I 2. ALL LEVELS ARE IN METRES RELATED TO ORDNA	is, Drawings.
 ALL LEVELS ARE IN METRES RELATED TO ORDINA MALIN HEAD. ANY DISCREPANCIES BETWEEN THESE DOCUME BROUGHT TO THE ATTENTION OF THE ENGINEER 	NTS SHALL BE
 DRAWINGS ARE NOT TO BE SCALED. ALL DIMENSIONS ARE IN MILLIMETRES, UNLESS NOT TO BE SCALED. 	IOTED
OTHERWISE. DRAWING REFERENCE: 22156-MWP-00-00-DR-C-5005 Site Layout - Maste	or Shoet
22156-MWP-00-00-DR-C-5005 Site Layout - Maste	er Sheet
P01 08.12.23 Issued For Planning	JK PC
REV DATE DESCRIPTION PROJECT: Ballycar Wind Farm	BY APP
TITLE: Cable Trench Details	
BALLYCAR Green Energy	
ENGINEERING AND ENVIRONMENTAL CONSUL	TANTS
DRAWN: CHECKED: APPROVE	
JK PC PROJECT NUMBER: DATE: SCALE @ 22156 December 2023 A	OH A1: s Shown ISTATUS:
FOR INFORMATION	S2
22156 - MWP - 00 - 00 - DR-C- 5407	P01

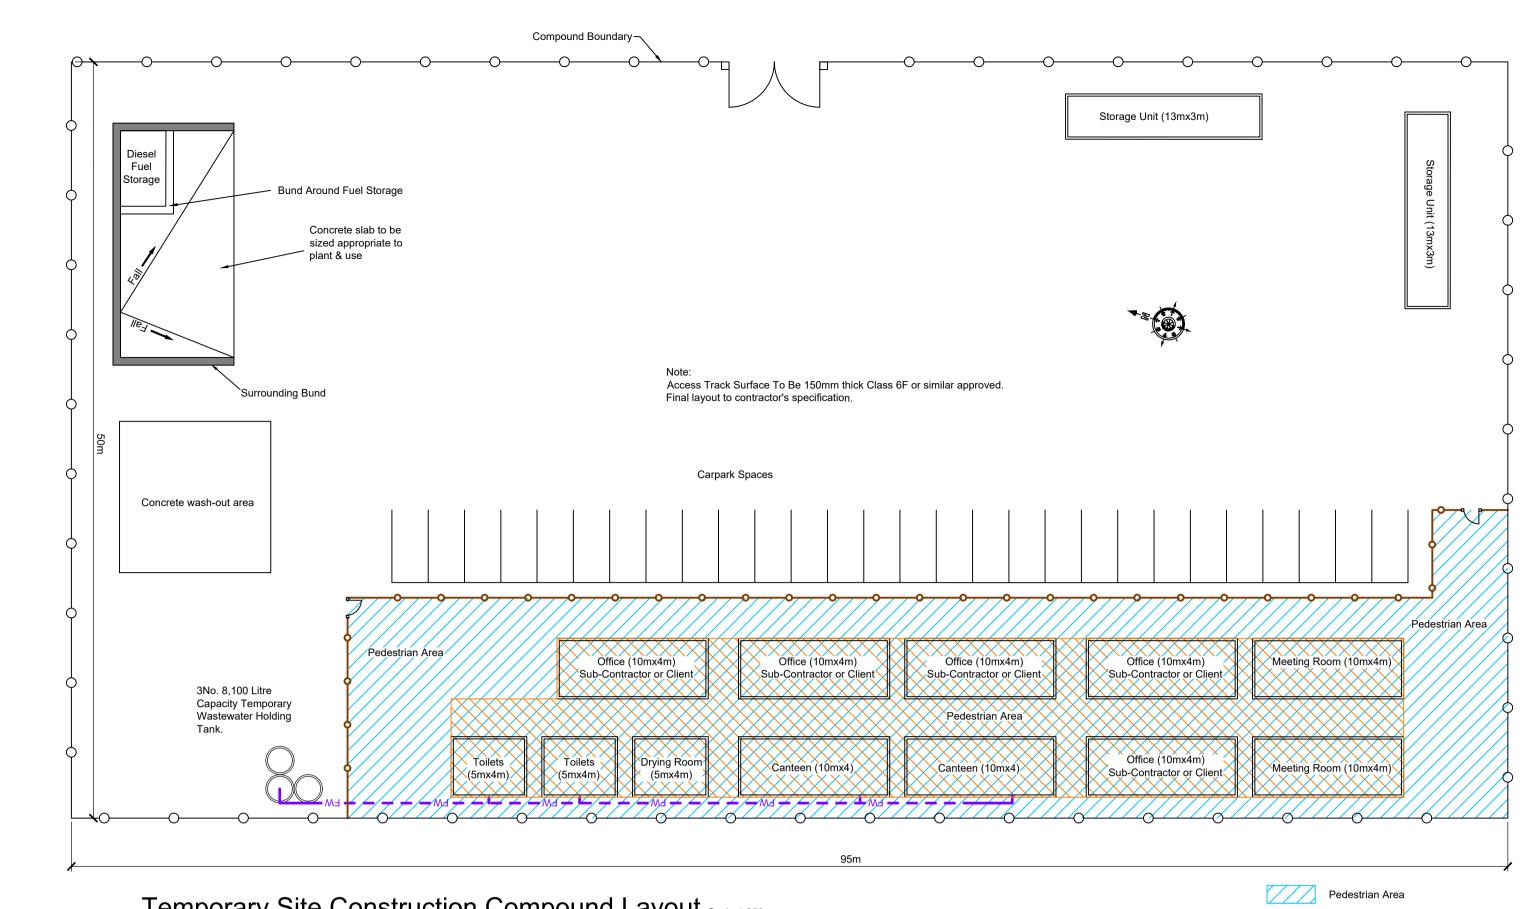

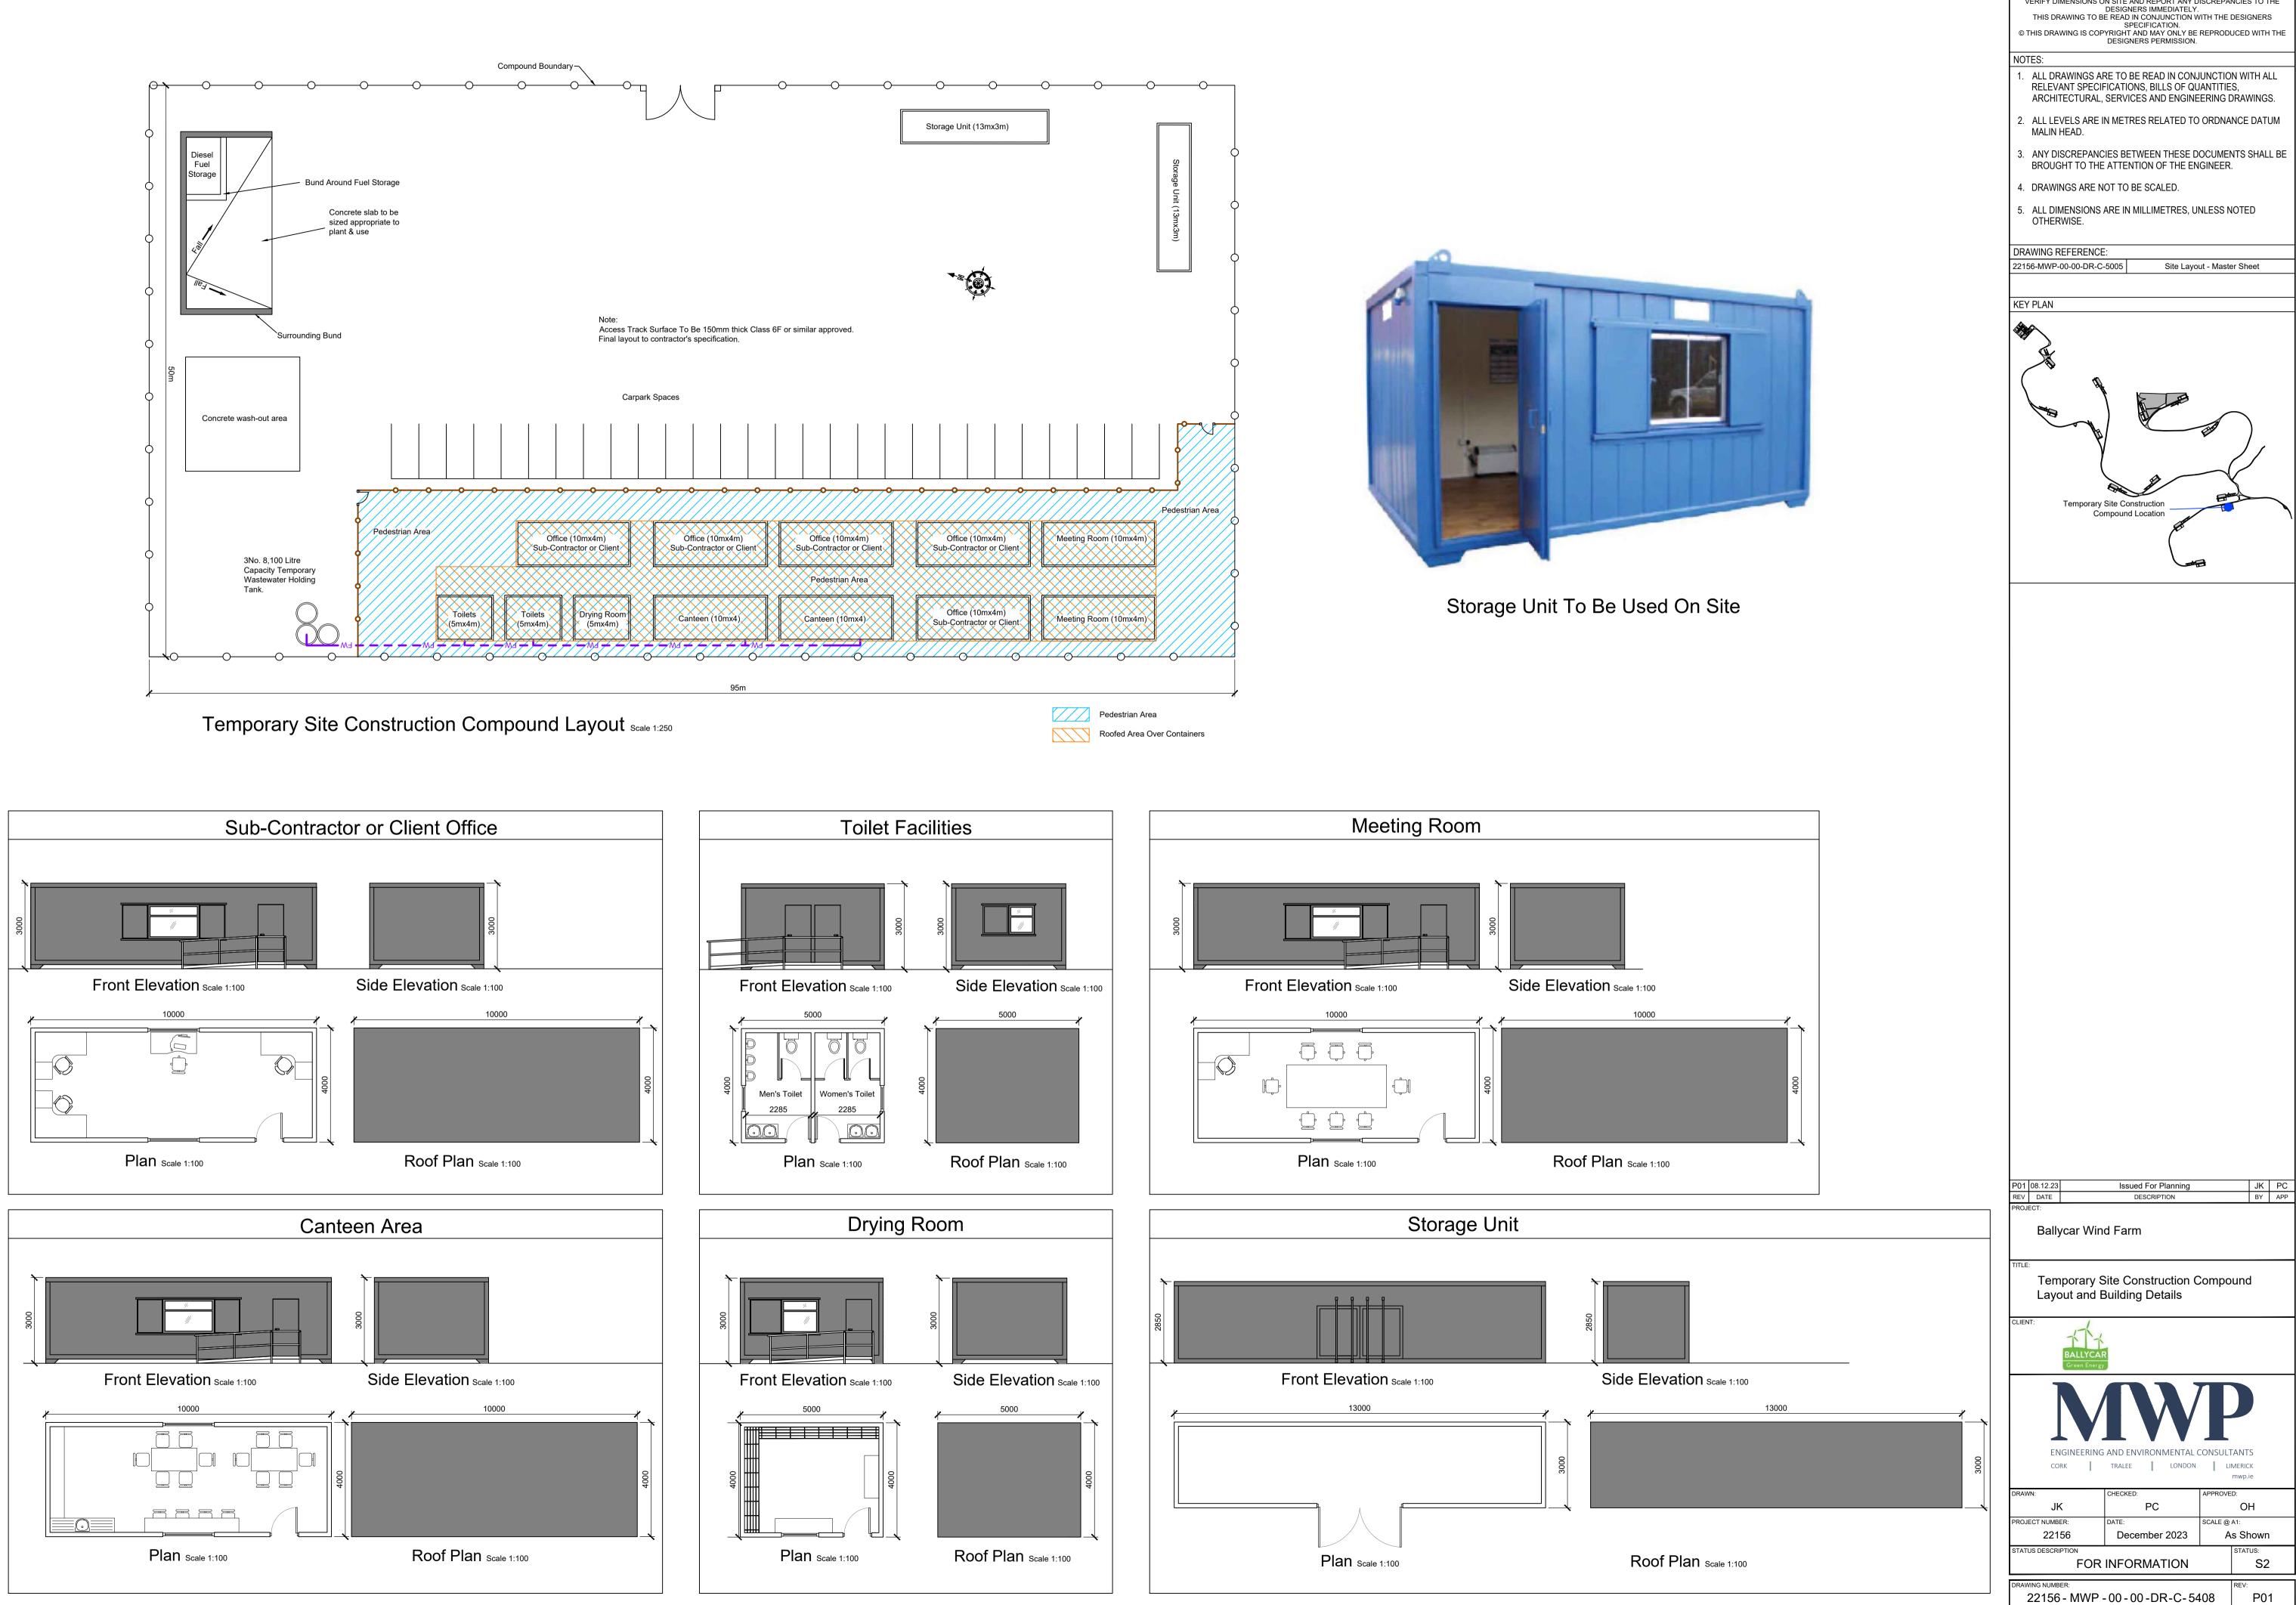


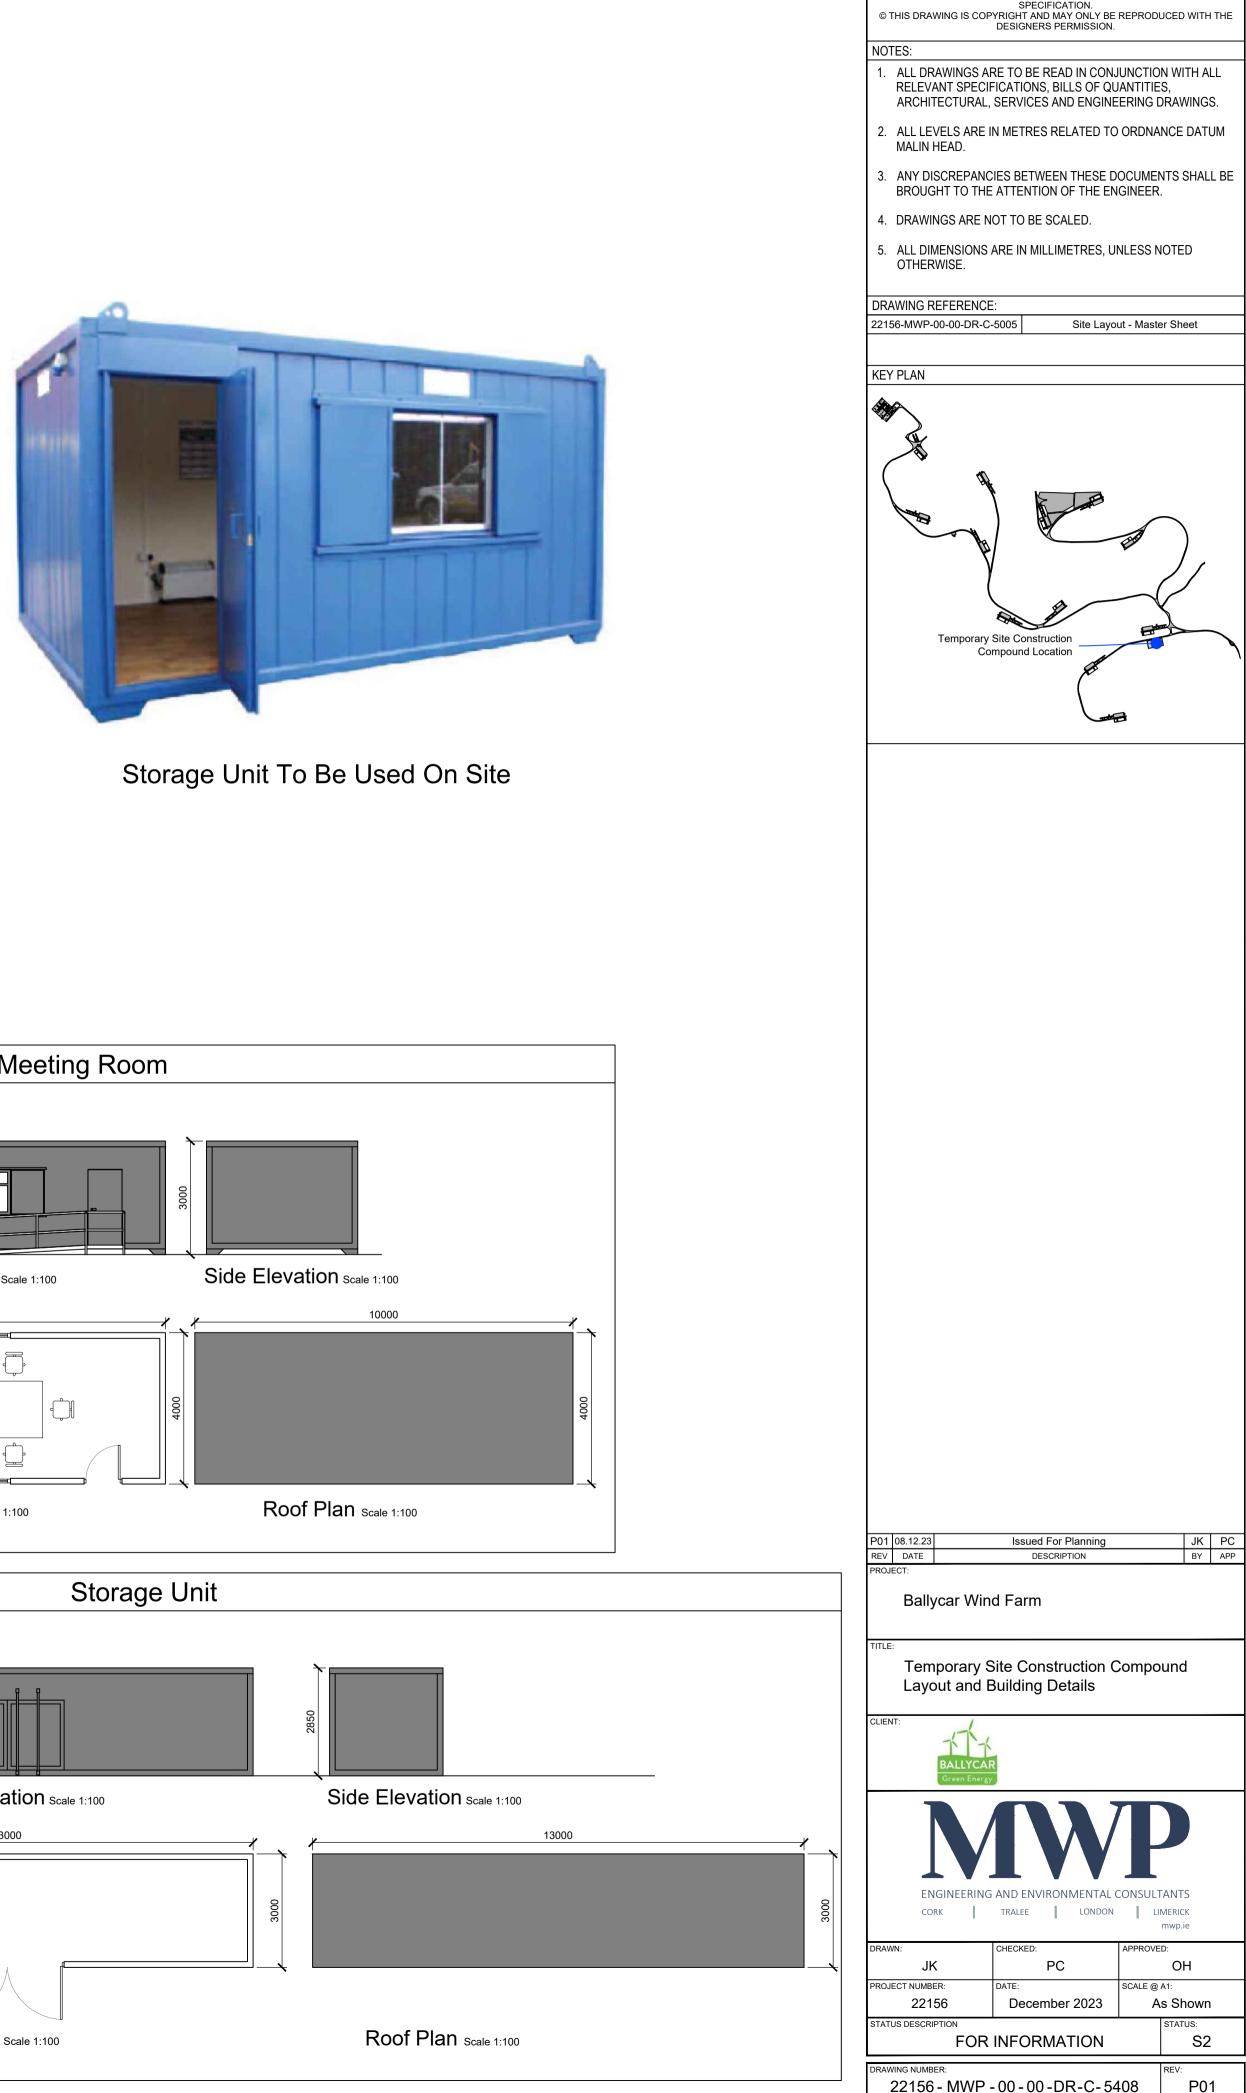

DO NOT SCALE FROM THIS DRAWING. USE FIGURED DIMENSIONS IN ALL CASES. VERIFY DIMENSIONS ON SITE AND REPORT ANY DISCREPANCIES TO THE

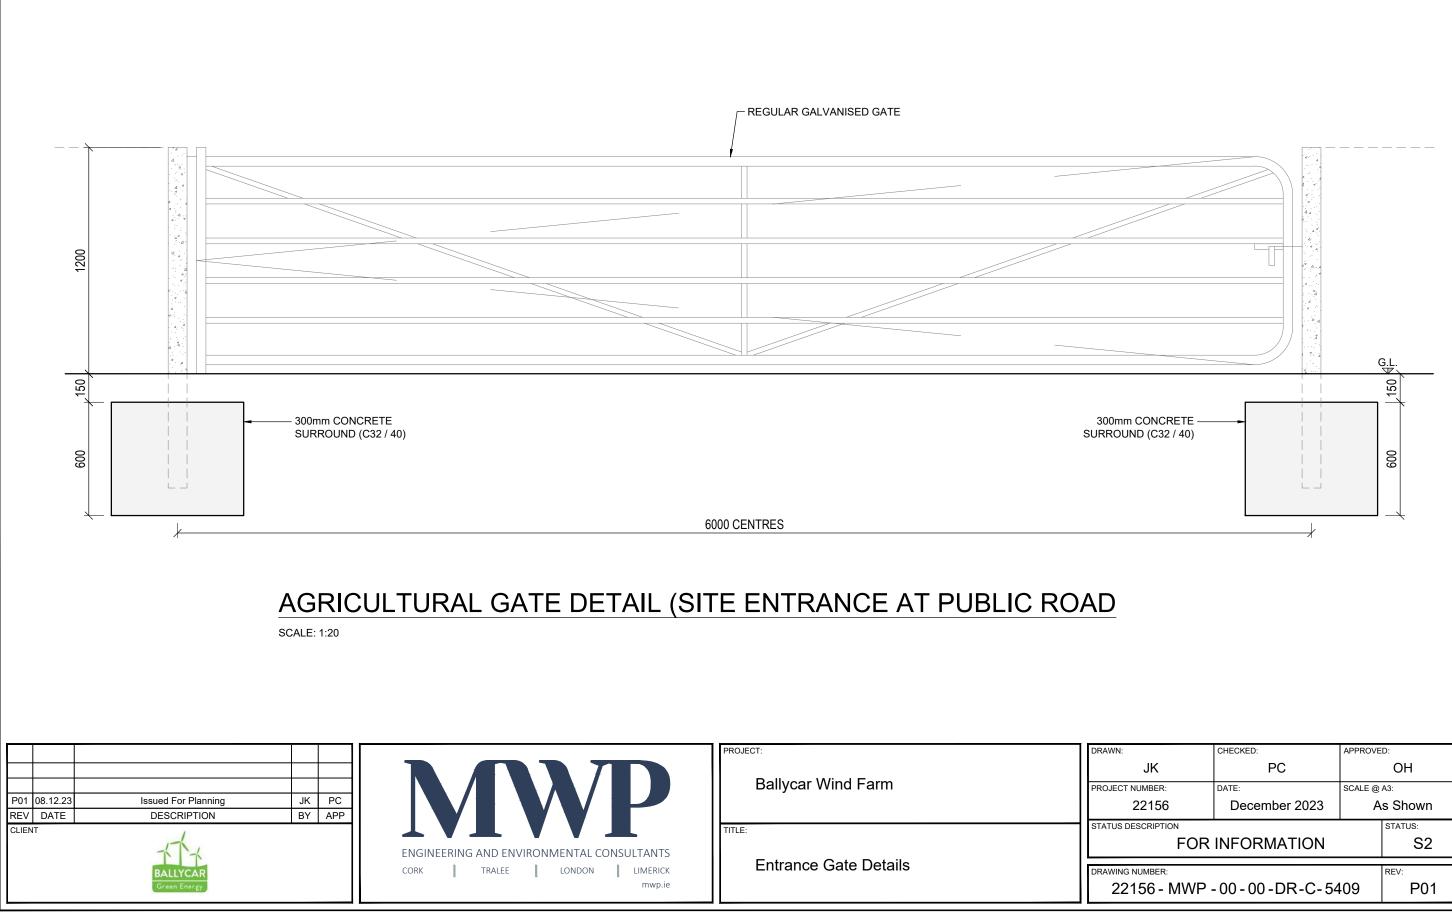

:	D:				
JK	ОН				
CT NUMBER: DATE: SCALE @ A3:					
22156	s Shown				
S DESCRIPTION			STATUS:		
FOR INFORMATION S2					
IG NUMBER: REV:					
2156 - MWP - 00 - 00 - DR - C - 5409 P01					

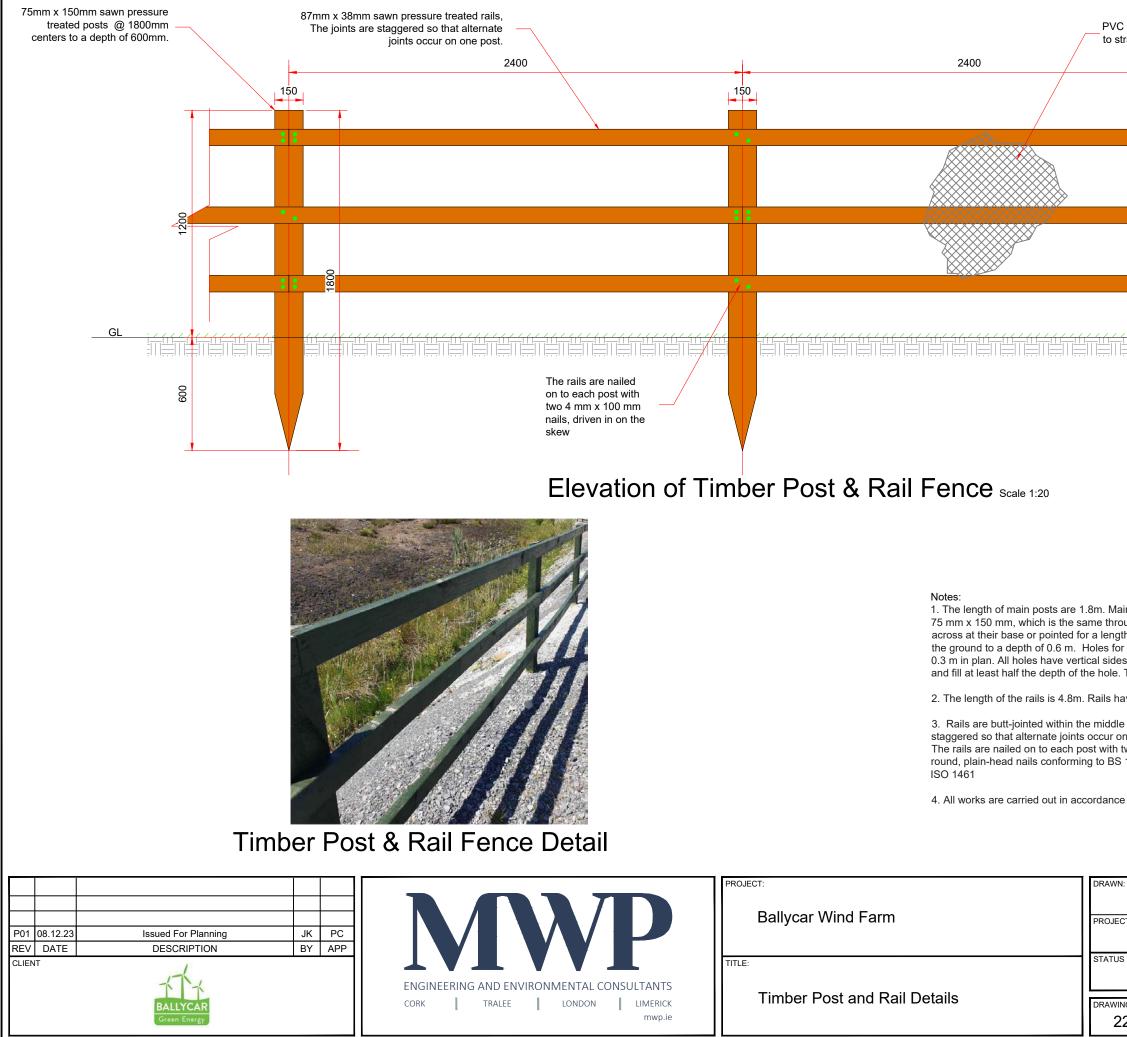


	n livestock areas) fixed galvanised steel wire	
150		
	100	
::	81	
	a	
	325	
•.	81	
	275	
::	81	
	<u></u>	<pre>fi</pre>
, , , , , , , , ,	Ⅰ,-,-, ,-,-, ,-,-, ,-,-, ,-,-, ,-	
, in the second s		
th not exceeding 225 r main posts set in co s. Posts are surroun	ss-section of They are either cut square 5 mm. Main posts are set v oncrete shall be not less th ded in leanmix concrete at e hole is filled with backfill.	rertically in an 0.3 m x
ave a cross-section o	of 87 mm x 38 mm.	
	n face of a main post. The jo	pints are
	nails, driven in on the skev galvanized in accordance v	
e with IS EN 1722-7:	2006.	
:	CHECKED:	APPROVED:
JK	PC	OH
CT NUMBER:	DATE:	SCALE @ A3:
22156 DESCRIPTION	December 2023	1 : 20
	INFORMATION	STATUS. S2
NG NUMBER: 2156 - MWP -	-00-00-DR-C-54	10 P01

Ŀ			lean Water terceptor Drain		Existing Groun	d Profile	1 				_	Borrow Pit S Filled With S	Stone Extraction And Surplus Spoil Material					<i>∠</i> − Berm		
Level	204447-6 24447-6 24447-6 24447-6 24444-7 2444444 2444444 244444 244444 244444 244444 2444444	ž	<u> </u>		minimini		mmmmm								Bottom Of Extrac				- Existing Grou	und Profile
Chainage	00.00	10.000	20.000	30.000	40.000	50.000		60.000	- 0000	80.000	- 000.06	100.000	110.000	- 120.000	130.000	140.000	150.000	160.000 -	170.000	
Existing Levels	253.458	254.318	255.107 —	254.646 —	253.652	251.618	1	250./54	248.199 —	246.699 —	245.471 —	244.319	243.762	243.143 —	242.836	242.670 —	242.535	242.668	242.387	
Proposed Levels		254.019	244.024 —	240.705 —	240.705 —	240.705		240.705	240.705 —	240.705 —	240.705 —	240.705	240.705 —	240.705 —	240.705 —	240.705 —	240.705			
Level Difference		0.299	11.083	13.941	12.947	10.913		10.049	7.494	5.994	4.766	3.614	3.057	2.438	2.131	1.965	1.830			


LONGSECTION A-A

SCALE: H 1:500,V 1:500. DATUM: 240.000

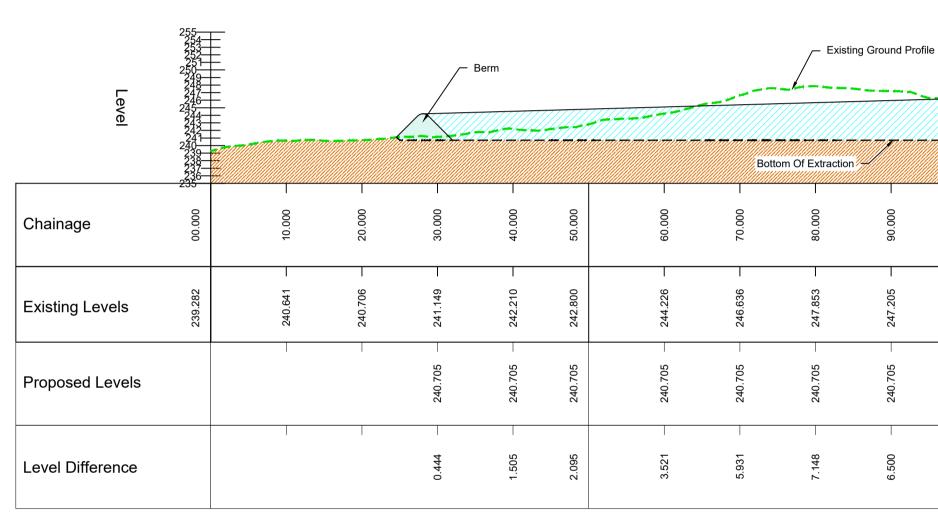



LONGSECTION B-B


SCALE: H 1:500,V 1:500. DATUM: 235.000

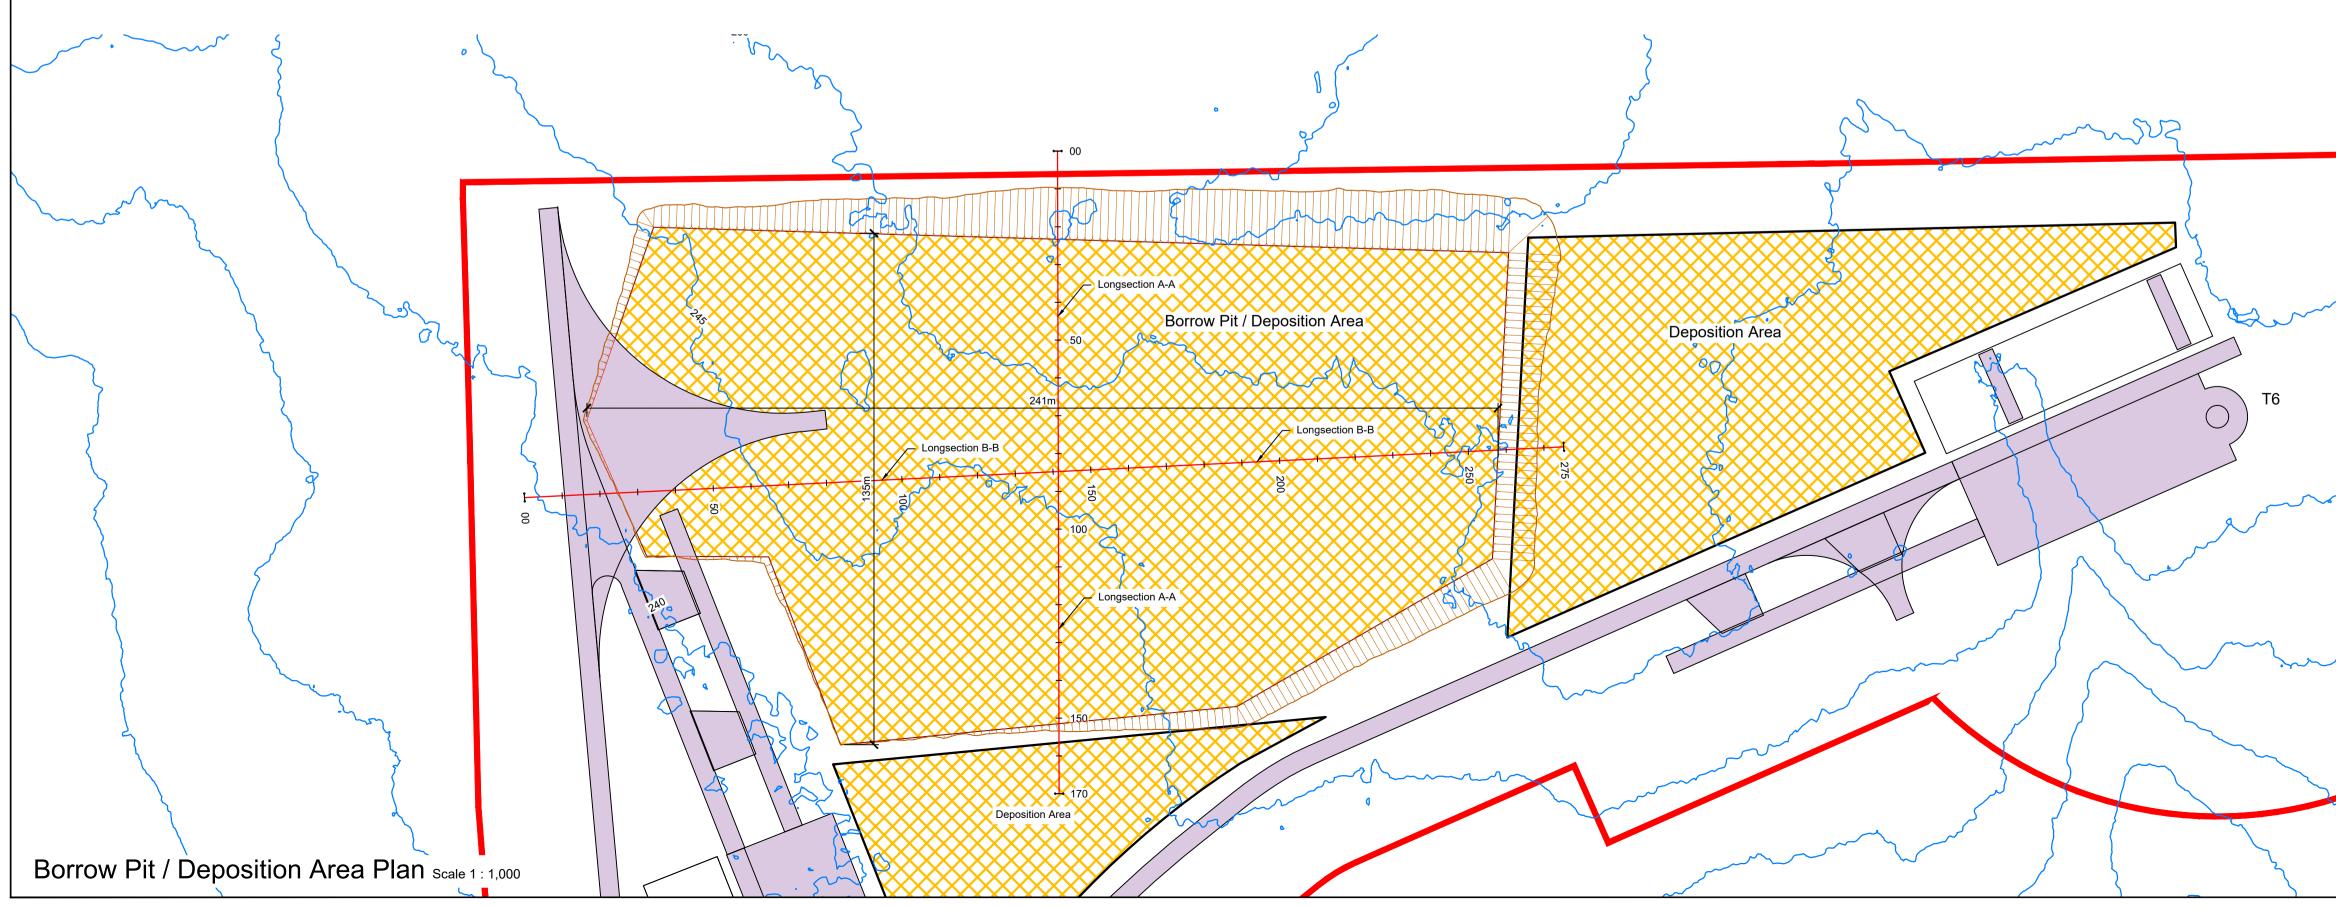


 Barner Viewer Bildwinder
 Statution Amerikanisk
 Statution Amerikanisk

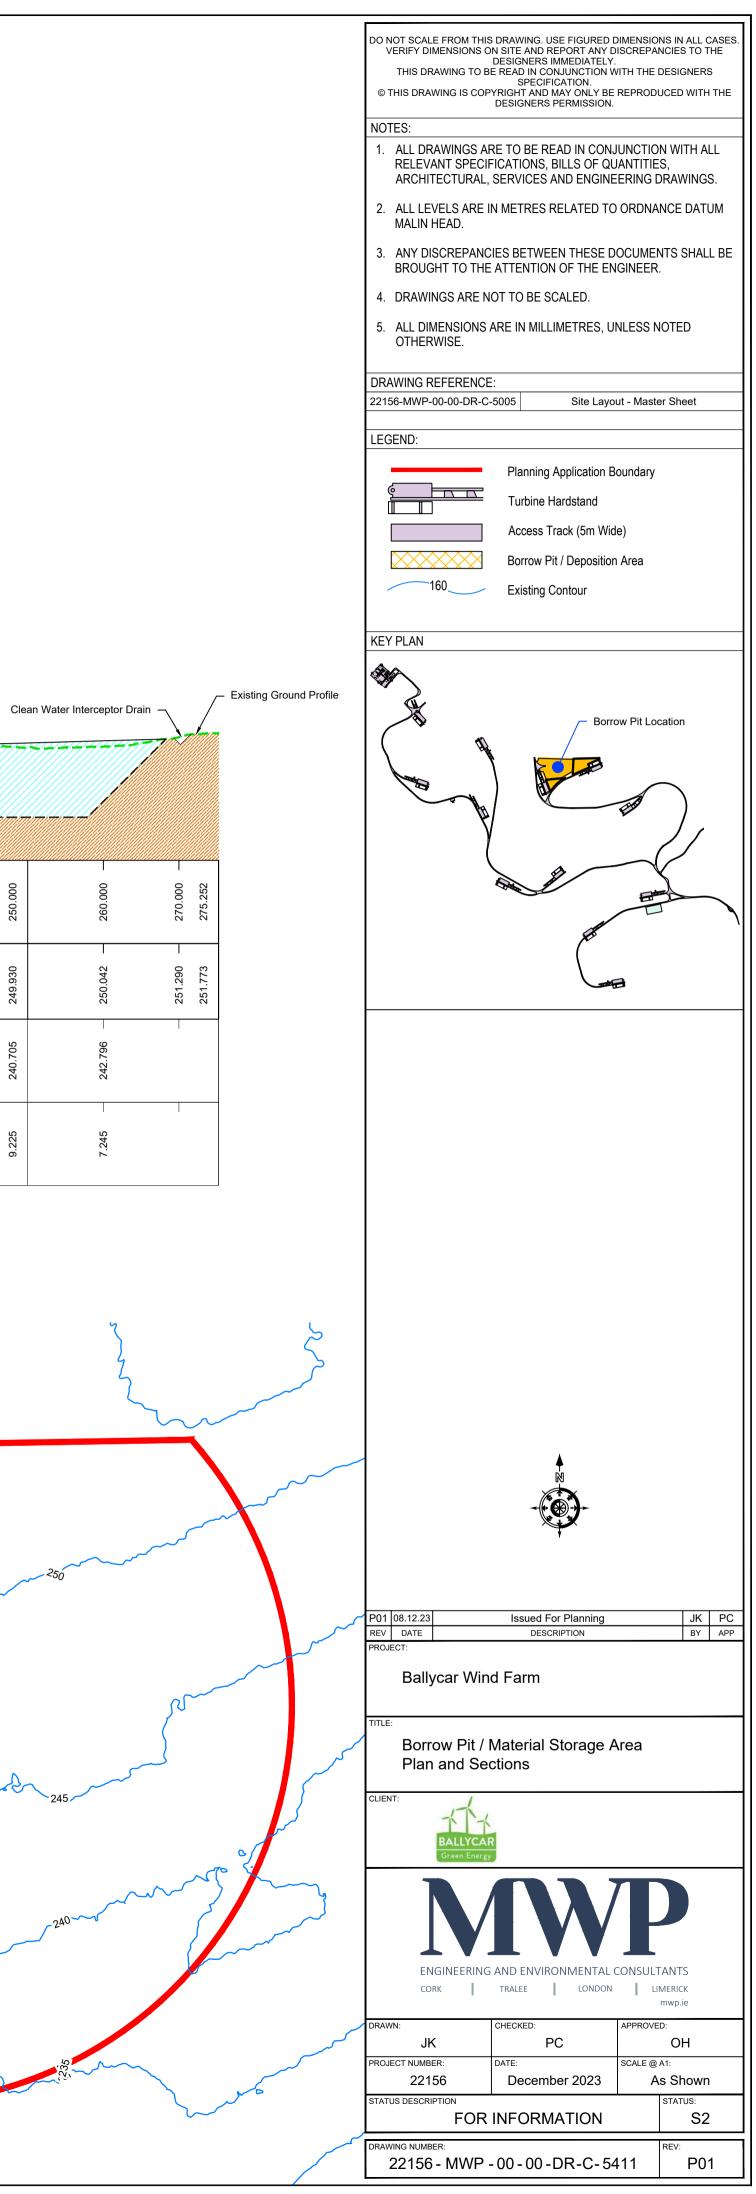

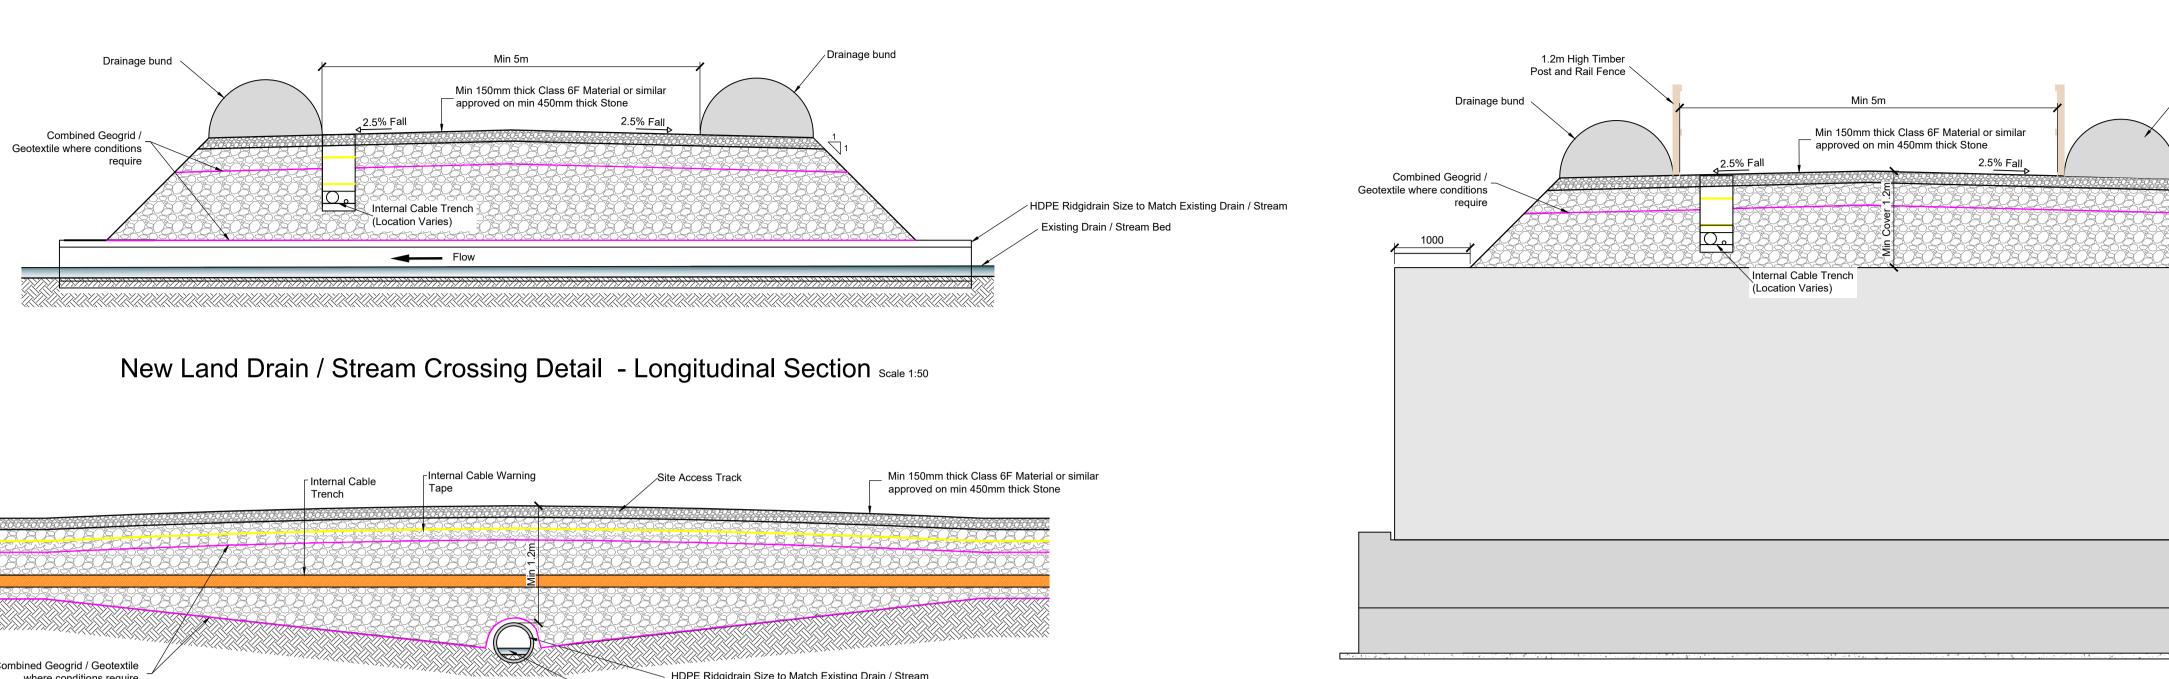


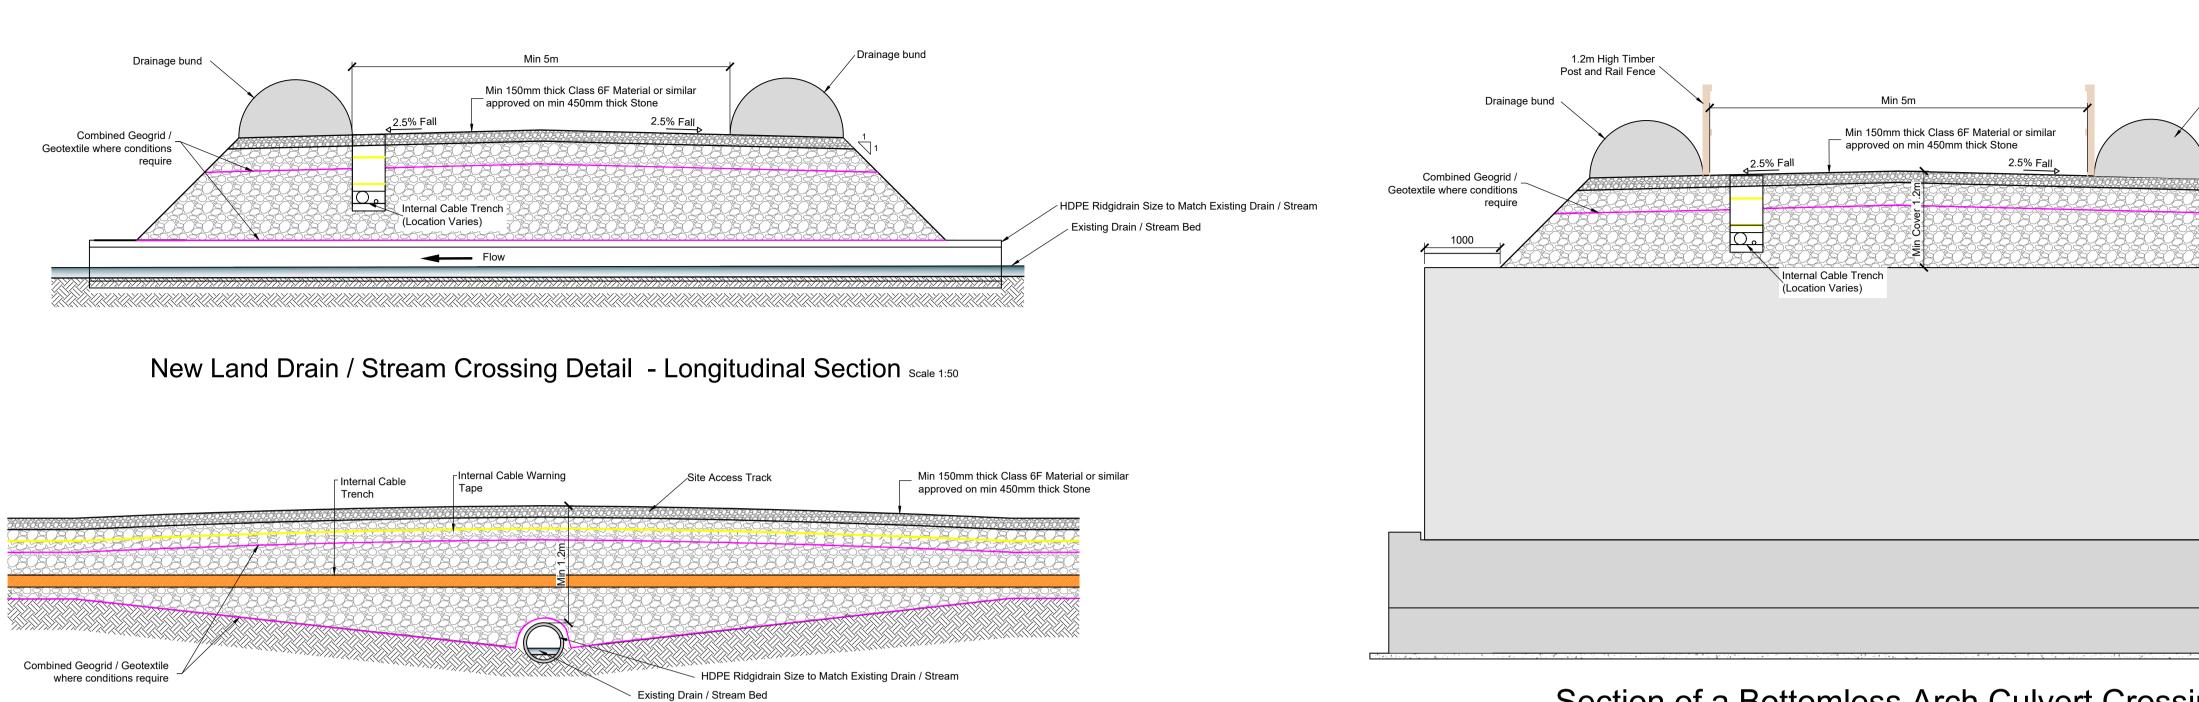

New Land Drain / Stream Crossing Detail - Cross Section Scale 1:50

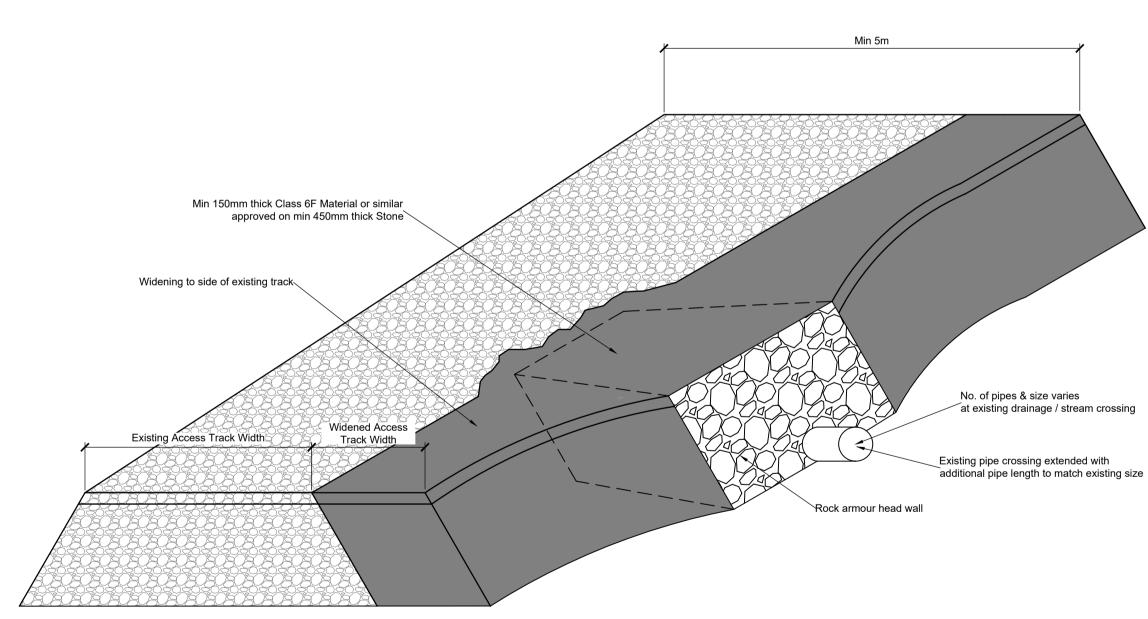

Widening Detail of Existing Land Drain / Stream Crossing Detail Scale 1:50

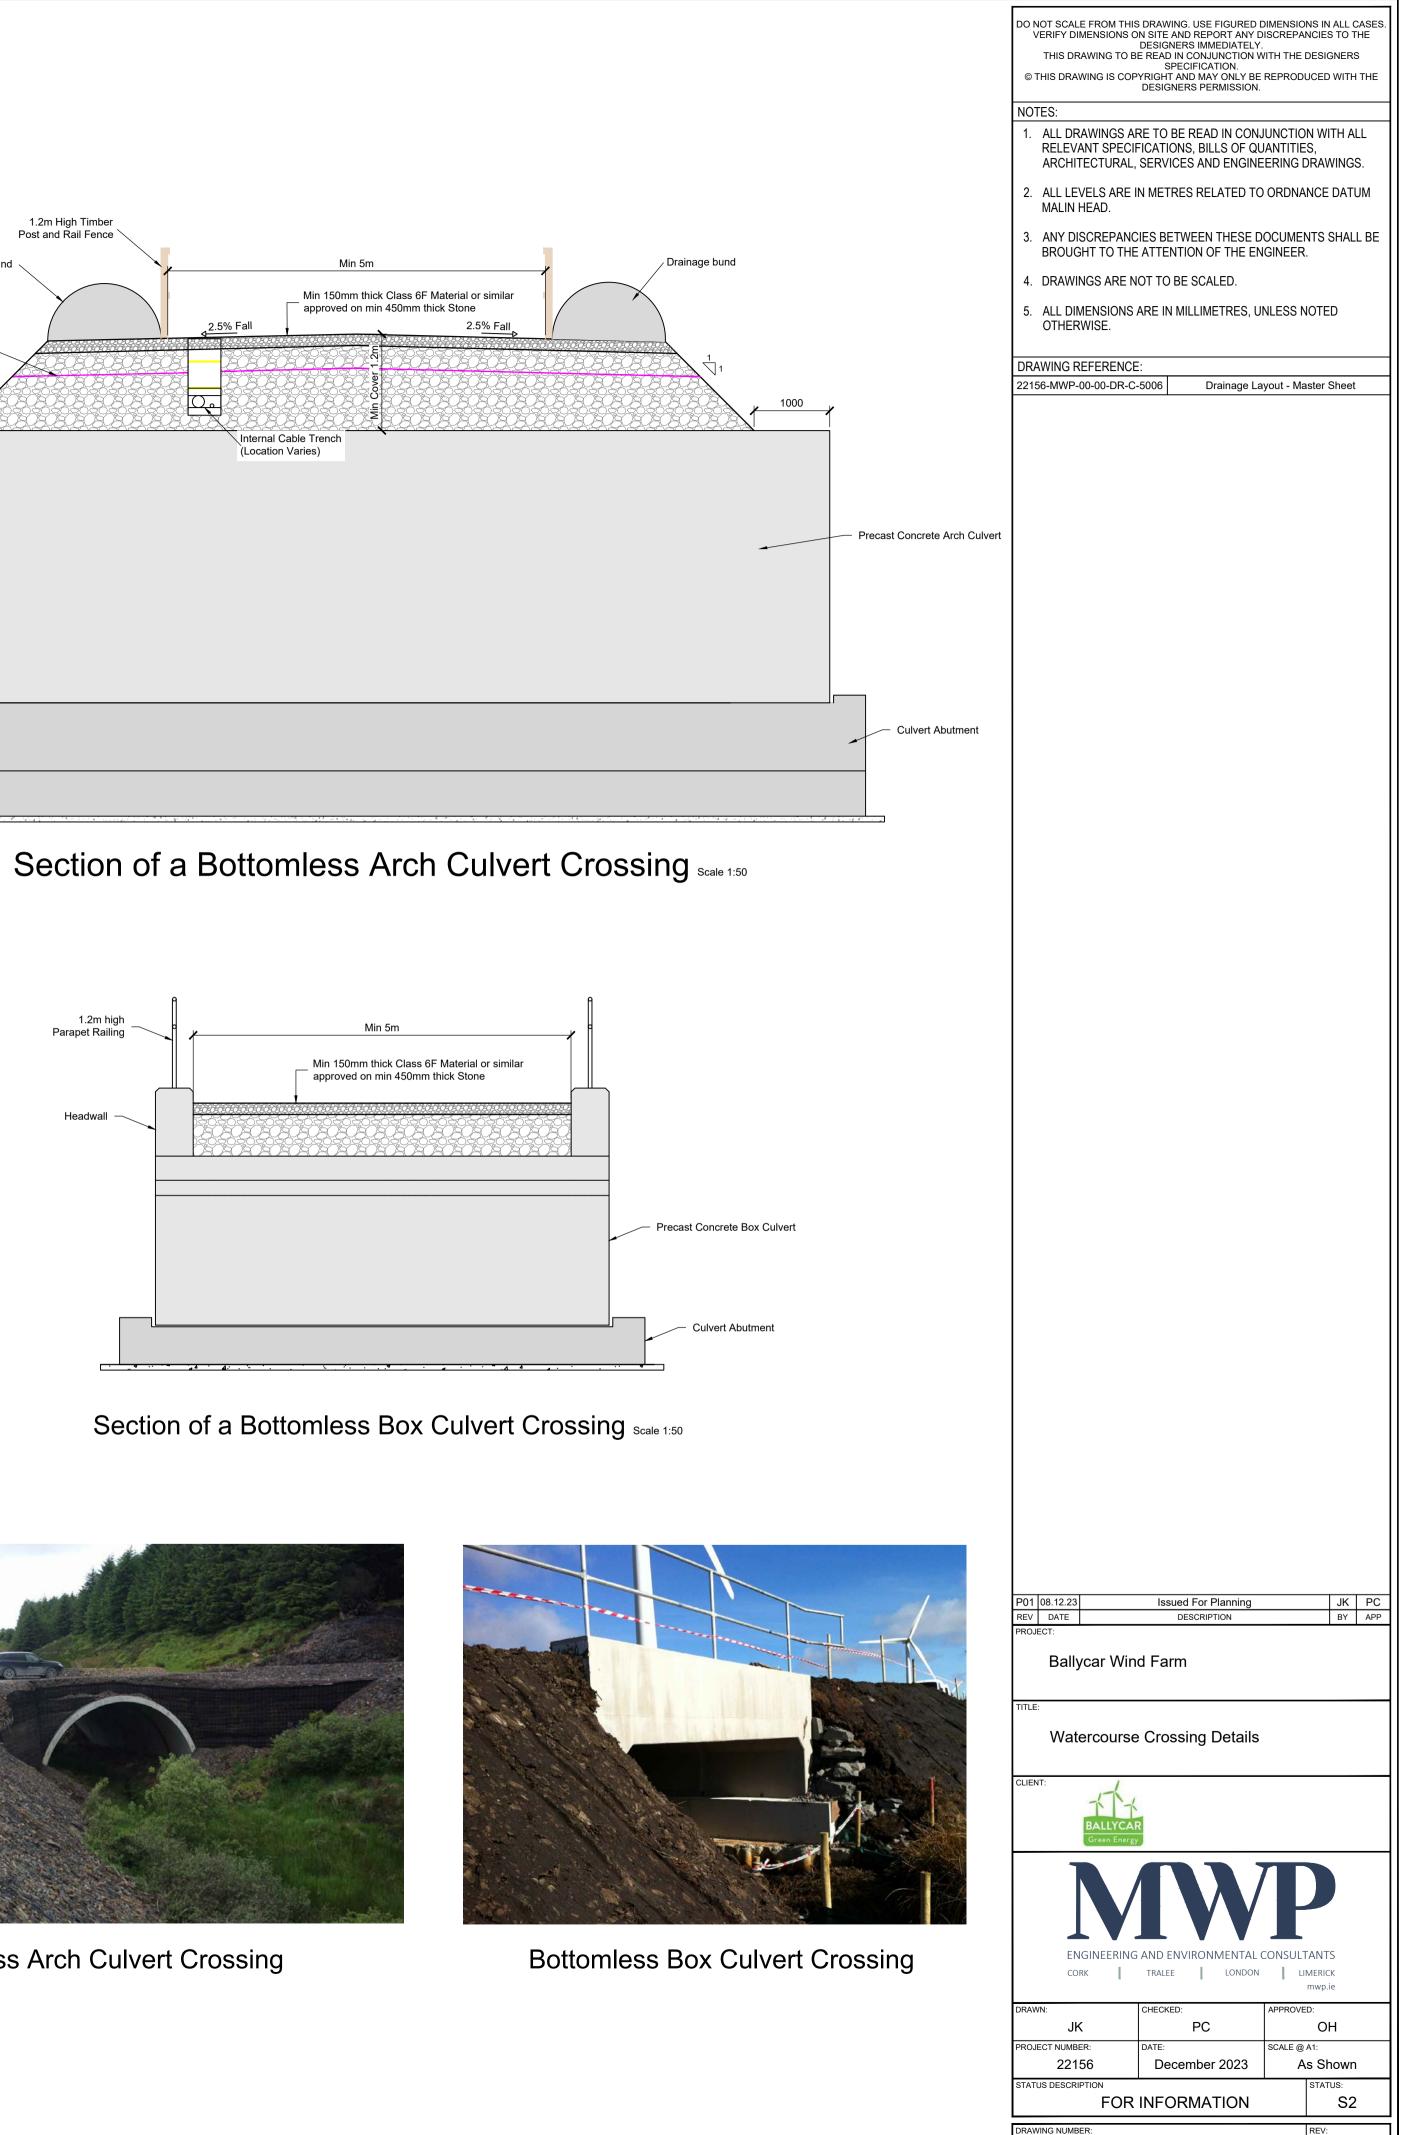












22156 - MWP - 00 - 00 - DR - C - 5412

P01



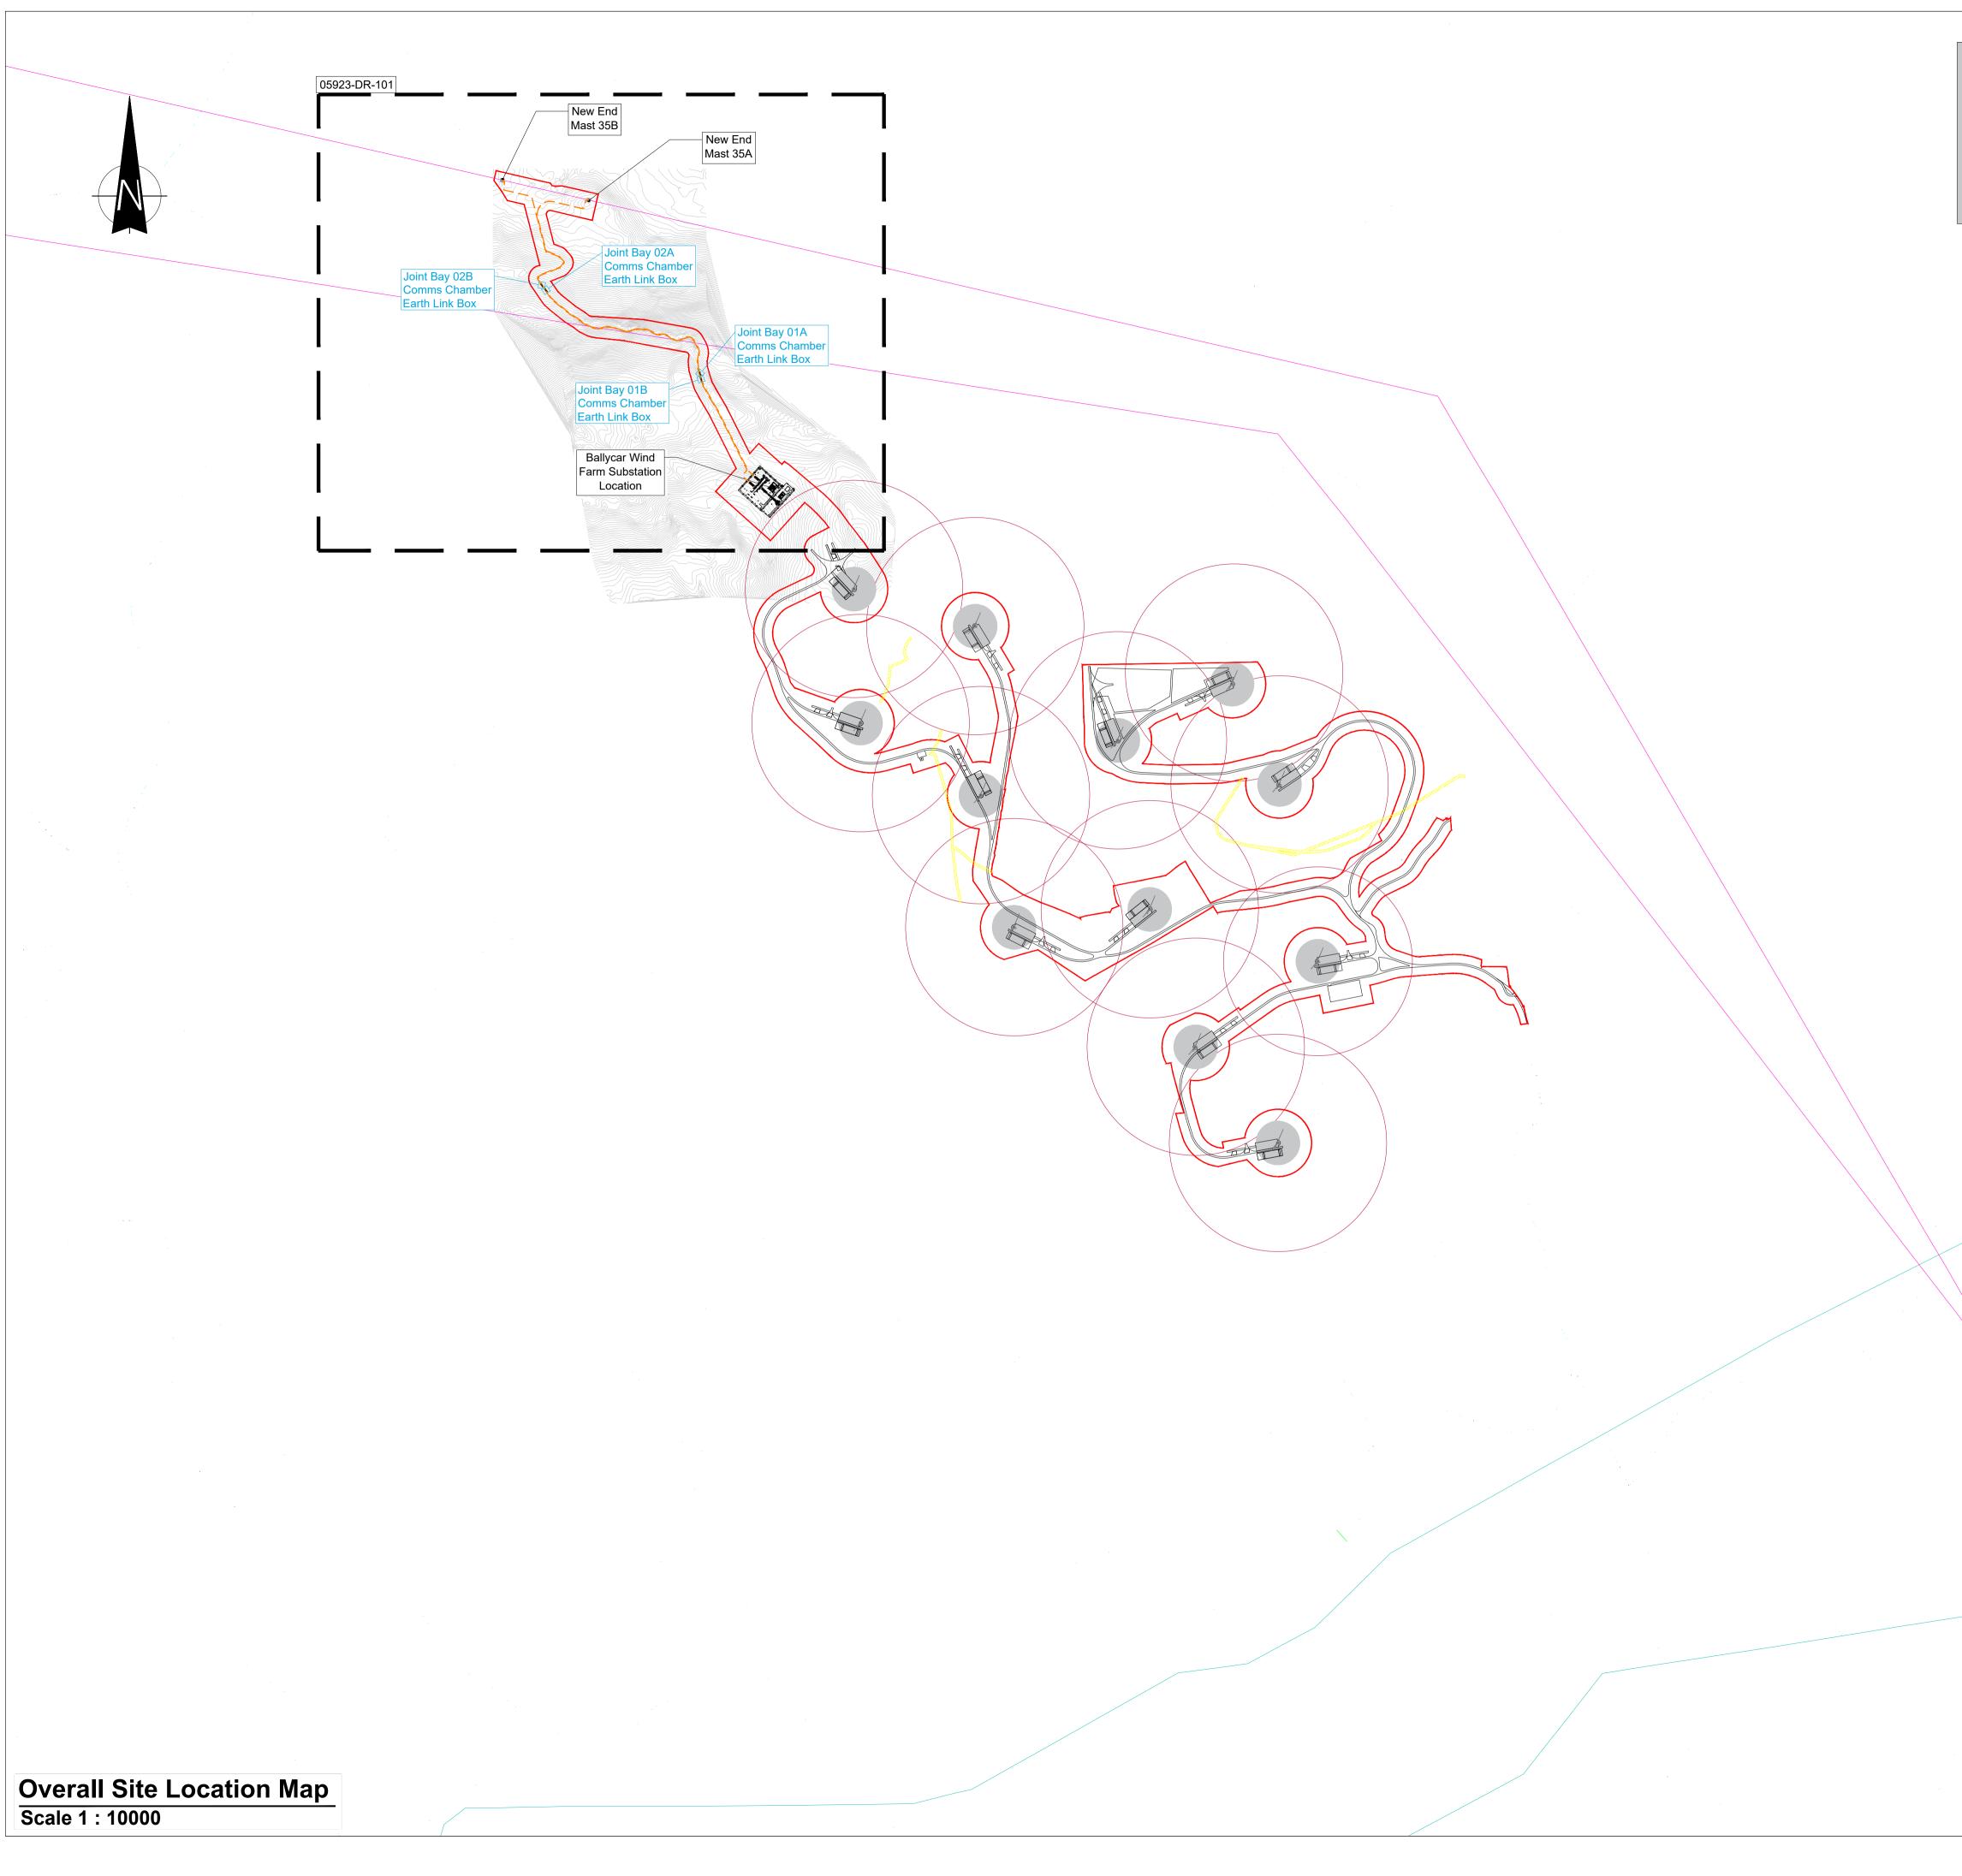

Map Series: 1:2500 Prime Data Raster

Reference No.'s 4622,4563,4562,4621

Ordnance Survey Ireland Licence No. CYAL50261649

Copyright:

© Tailte Éireann, 2023



Head Office Beenreigh, Abbeydorney, Tralee, Co. Kerry Ireland Tel: 00353 66 7135710

Regional Office Basepoint Business Centre Stroudley Road, Basingstoke, Hampshire, RG24 8UP, UK Tel: 00 44 1256406664

PROJECT

Ballycar Wind Farm 110kV UGC Grid Connection

CLIENT



CONSULTANTS

NOTES: -

- This drawing is to be read in conjunction with relevant drawings, specifications and reports.
 Drawings are not to be scaled use figured dimensions only.

LEGEND: -

Planning Application Boundary shown thus UG Cable Route shown thus (1.5 km) Overhead Line & End Mast

Ballycar WF Turbine Location

Turbine Falling Distance shown thus (2 x Rotor Diameter)

Joint Bay Locations shown thus Existing ESB OHL & UGC HV Network

Contours Wayleave

=====

Т

 \bigcirc

ISSUE/REVISION

P8	19.01.24	Issued for Planning
P7	12.01.24	Issued for Planning
P6	12.12.23	Issued for Planning
P5	05.12.23	Issued for Planning
P4	06.11.23	Issued for Planning
P3	24.05.23	Issued for Planning
P2	12.01.23	Issued for Planning
P1	27.10.23	Issued for Information
I/R	DATE	DESCRIPTION

PROJECT NUMBER


05-923

SHEET TITLE

Overall Site Location Map

SHEET NUMBER

A1 SO

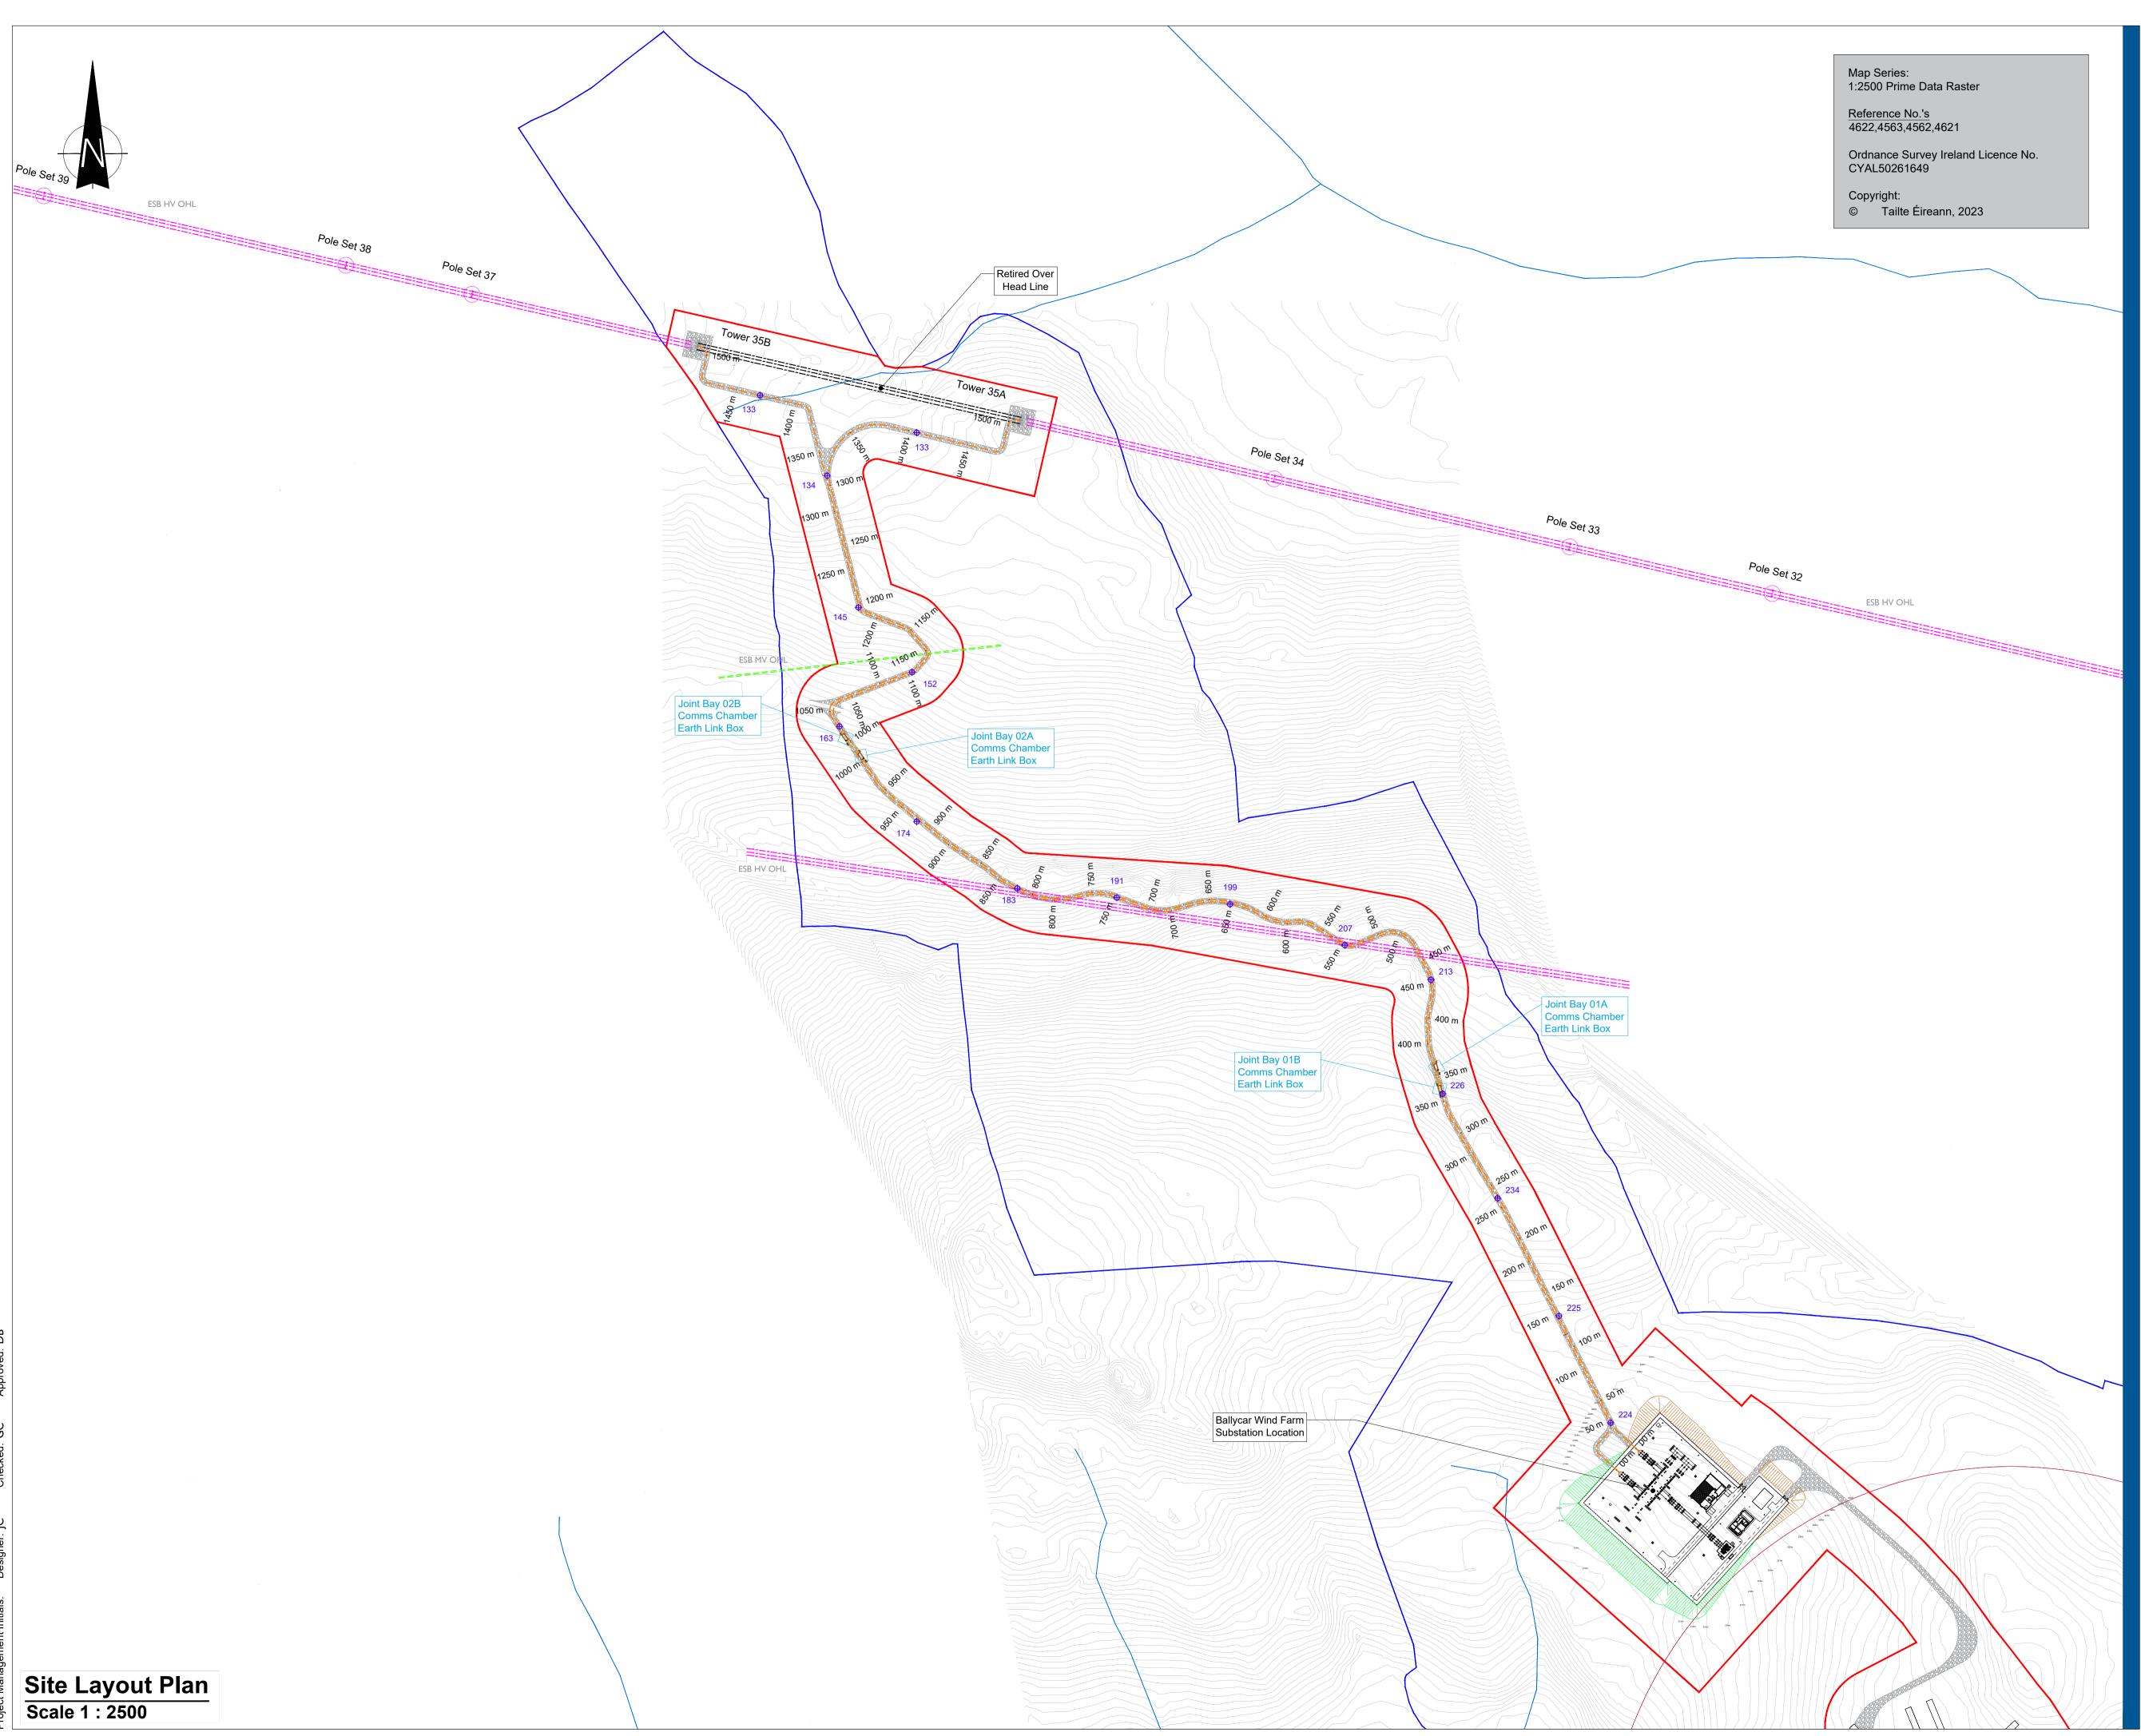

Map Series: 1:2500 Prime Data Raster

Reference No.'s 4622,4563,4562,4621

Ordnance Survey Ireland Licence No. CYAL50261649

Copyright: © Tailte Éireann, 2023



Head Office Beenreigh, Abbeydorney, Tralee, Co. Kerry Ireland Tel: 00353 66 7135710

Regional Office Basepoint Business Centre Stroudley Road, Basingstoke, Hampshire, RG24 8UP, UK Tel: 00 44 1256406664

PROJECT

Ballycar Wind Farm 110kV UGC Grid Connection

CLIENT



CONSULTANTS

NOTES: -

- This drawing is to be read in conjunction with
- relevant drawings, specifications and reports. • Drawings are not to be scaled use figured dimensions only. • Path of cable route and location of associated Joint Bays, Link Boxes and Comms Chambers may vary depending on site
- conditions.
- Other services may be encountered along the route.
 This drawing is to be used only for the purpose of the planning application and is subject to detailed design.
 All levels are in m O.D unless noted otherwise

LEGEND:

Planning Application Boundary shown thus Land Holding Boundary shown thus UG Cable Route shown thus (1.5 km) ==== Overhead Line & End Mast Т Ballycar WF Turbine Location Turbine Falling Distance shown thus (2 x Rotor Diameter) \bigcirc Joint Bay Locations shown thus Culvert Crossing shown thus Existing ESB OHL & UGC HV Network Existing ESB MV Networks shown thus ====== Existing levels shown thus **⊕** 79.617 Existing Rivers & Streams Cut Volume Fill Volume Access track Contours

ISSUE/REVISION

P5	19.01.24	Issued for Planning
P4	12.01.24	Issued for Planning
P3	12.12.23	Issued for Planning
P2	05.12.23	Issued for Planning
P1	06.11.23	Issued for Planning
I/R	DATE	DESCRIPTION


PROJECT NUMBER

05-923

SHEET TITLE

Site Layout Plan


SHEET NUMBER

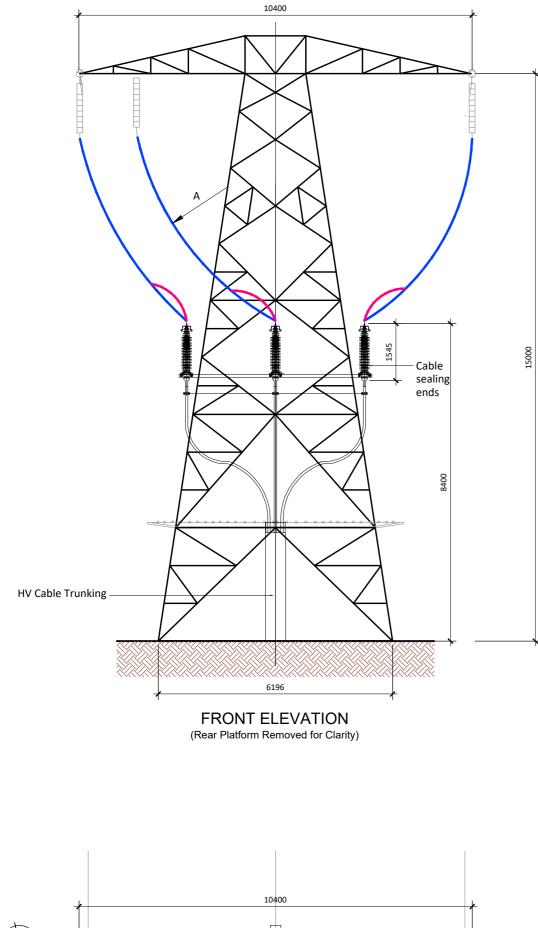


 \rightarrow 2 Ϋ́́ VIEW B ----2 \rightarrow <u>↑</u> 1 1 PLAN VIEW


SECTION 1-1

DB

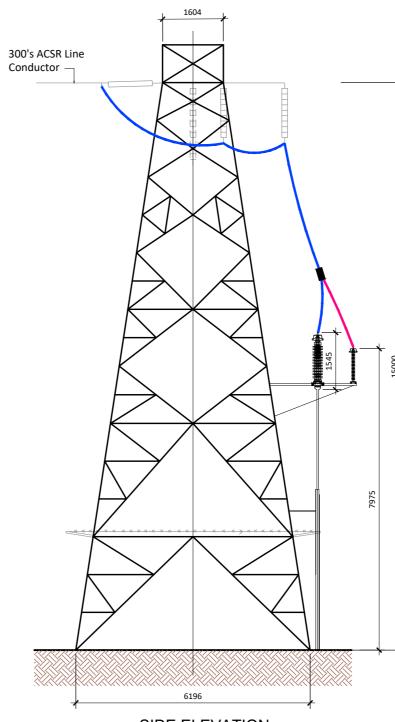

SIDE ELEVATION

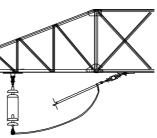

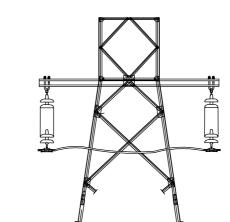

SECTION 2-2



PROJECT

Ballycar Wind Farm 110kV UGC Grid Connection

CLIENT



CONSULTANTS

NOTES: -

LEGEND: -

ISSUE/REVISION

_		
P3	12.01.24	Issued for Planning
P2	12.12.23	Issued for Planning
P1	06.11.23	Issued for Planning
I/R	DATE	DESCRIPTION
PR	OJECT NUI	MBER


PROJECT NUMBER

05-923

SHEET TITLE

End Mast Details

SHEET NUMBER

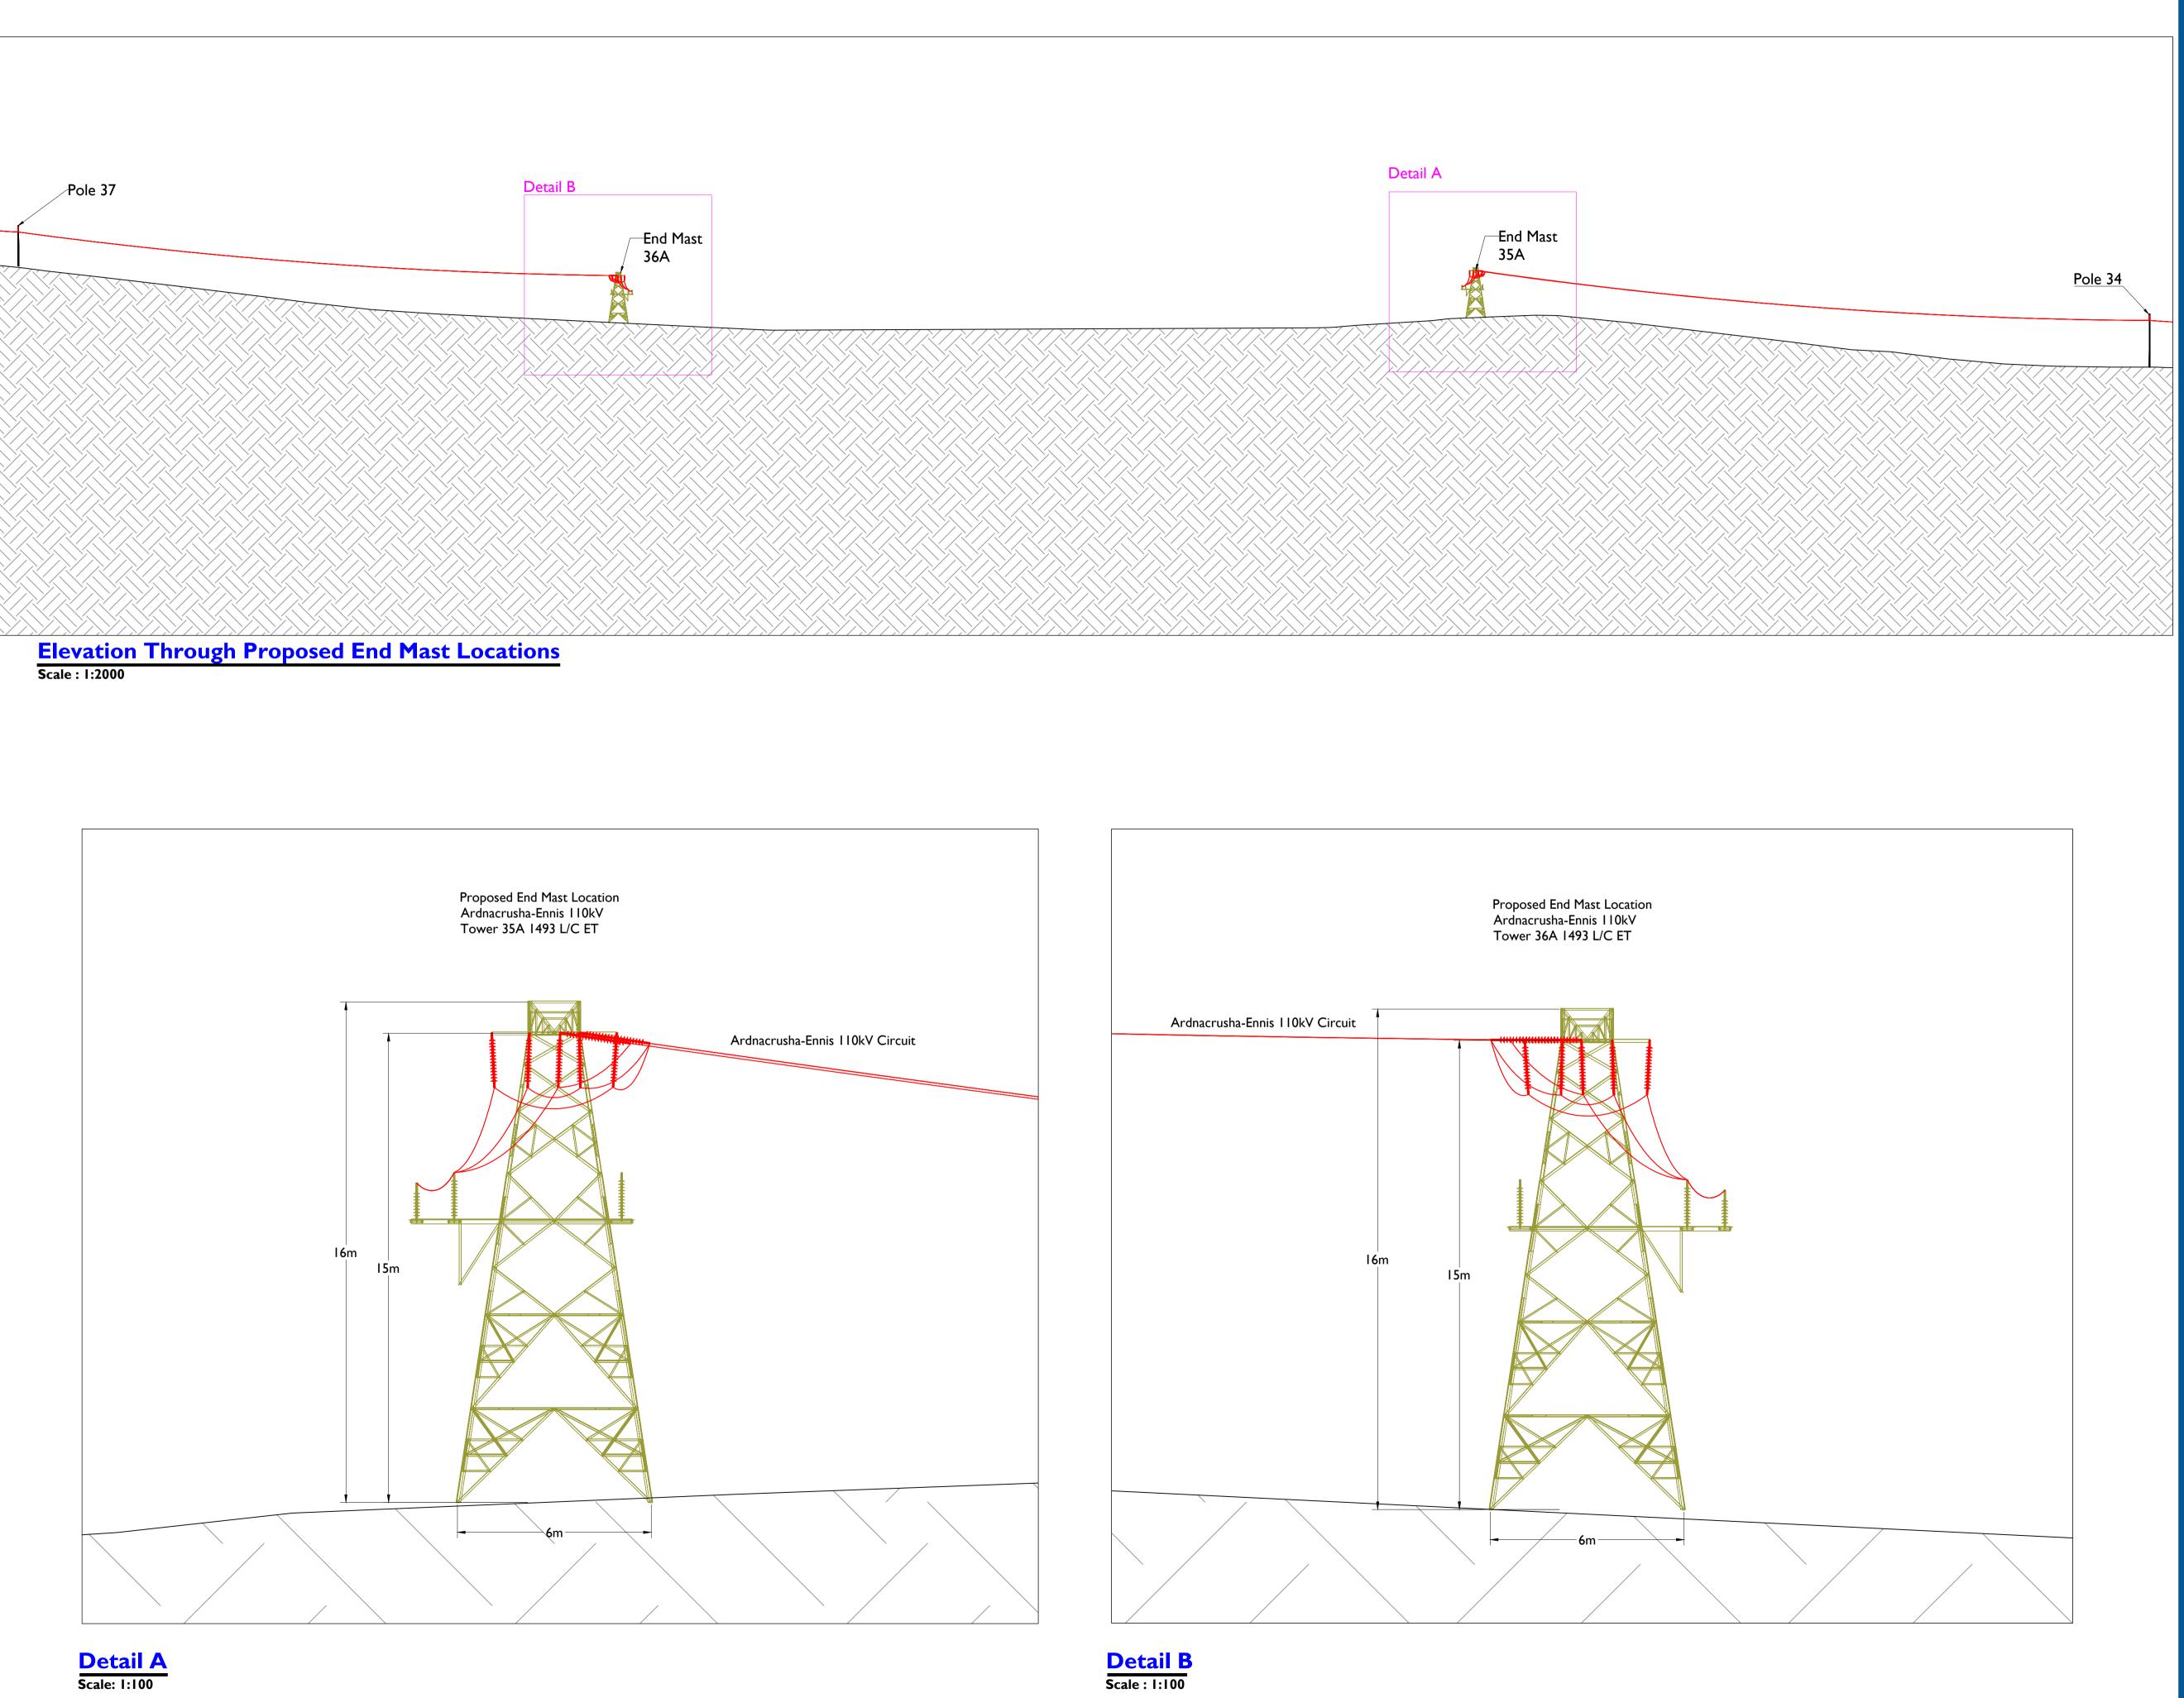



Head Office Beenreigh, Abbeydorney, Tralee, Co. Kerry

Regional Office Basepoint Business Centre Stroudley Road, Basingstoke,
 Tralee, Co. Kerry
 Hampshire,

 Ireland
 RG24 8UP, UK

 Tel: 00353 66 7135710
 Tel: 00 44 1256406664

PROJECT

Ballycar Wind Farm 110kV UGC Grid Connection

CLIENT



CONSULTANTS

NOTES: -

- This drawing is to be read in conjuction with relevant drawings, specifications and reports.
- Dimensions are in metres, unless noted otherwise.
- Drawings are not to scale, use figured dimensions only.
 Drawing to be read in conjunction with Construction Methodology.

LEGEND: -

Proposed Towers

ISSUE/REVISION

D 0	40.04.04	
P3	12.01.24	Issued for Planning
P2	12.12.23	Issued for Planning
P1	06.11.23	Issued for Planning
I/R	DATE	DESCRIPTION

PROJECT NUMBER

05-923


SHEET TITLE

Elevation View of Proposed **Tower Locations**

SHEET NUMBER


Permanent Reinstatement

Reinstatement details based on Guidelines for Managing Openings in Public Roads - SD4

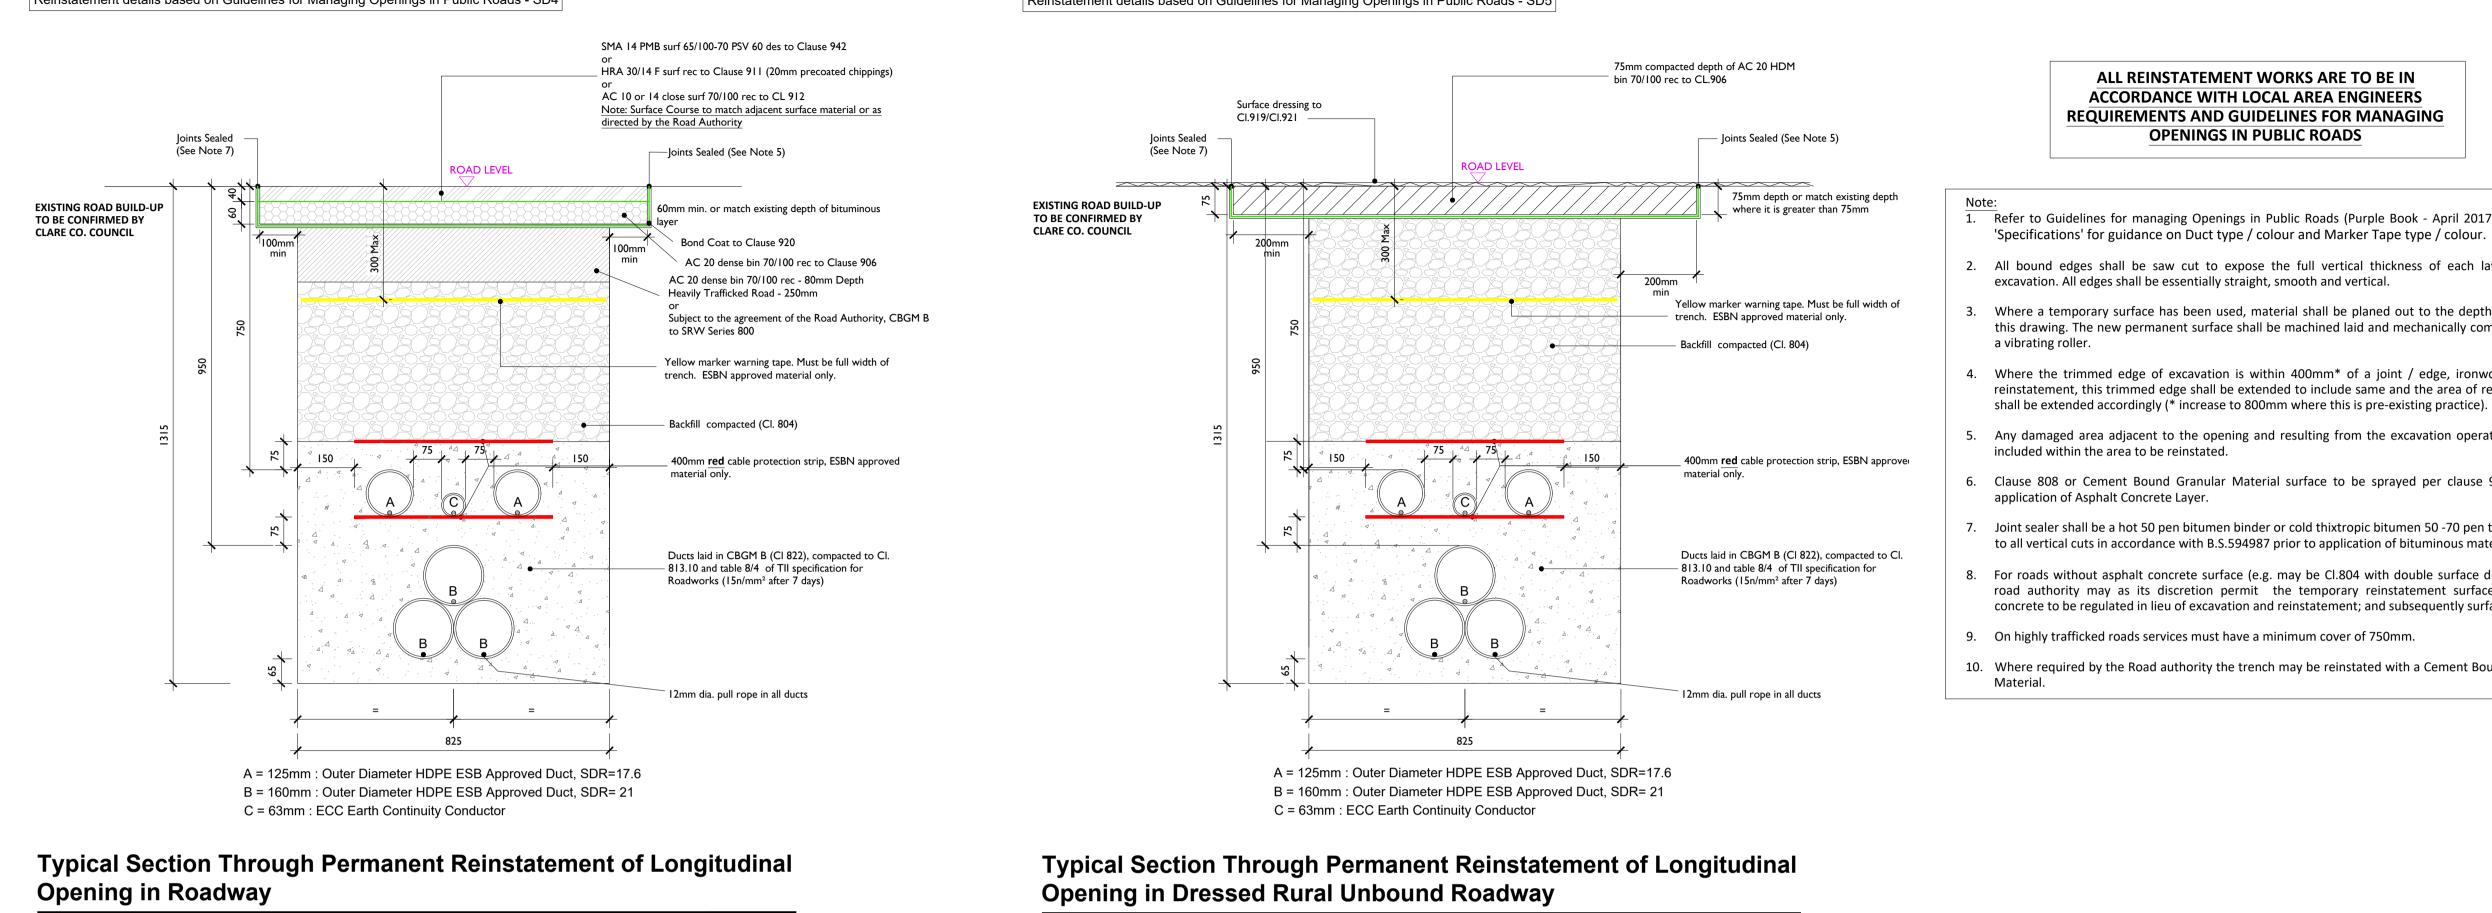

SCALE 1:10

Temporary Reinstatement

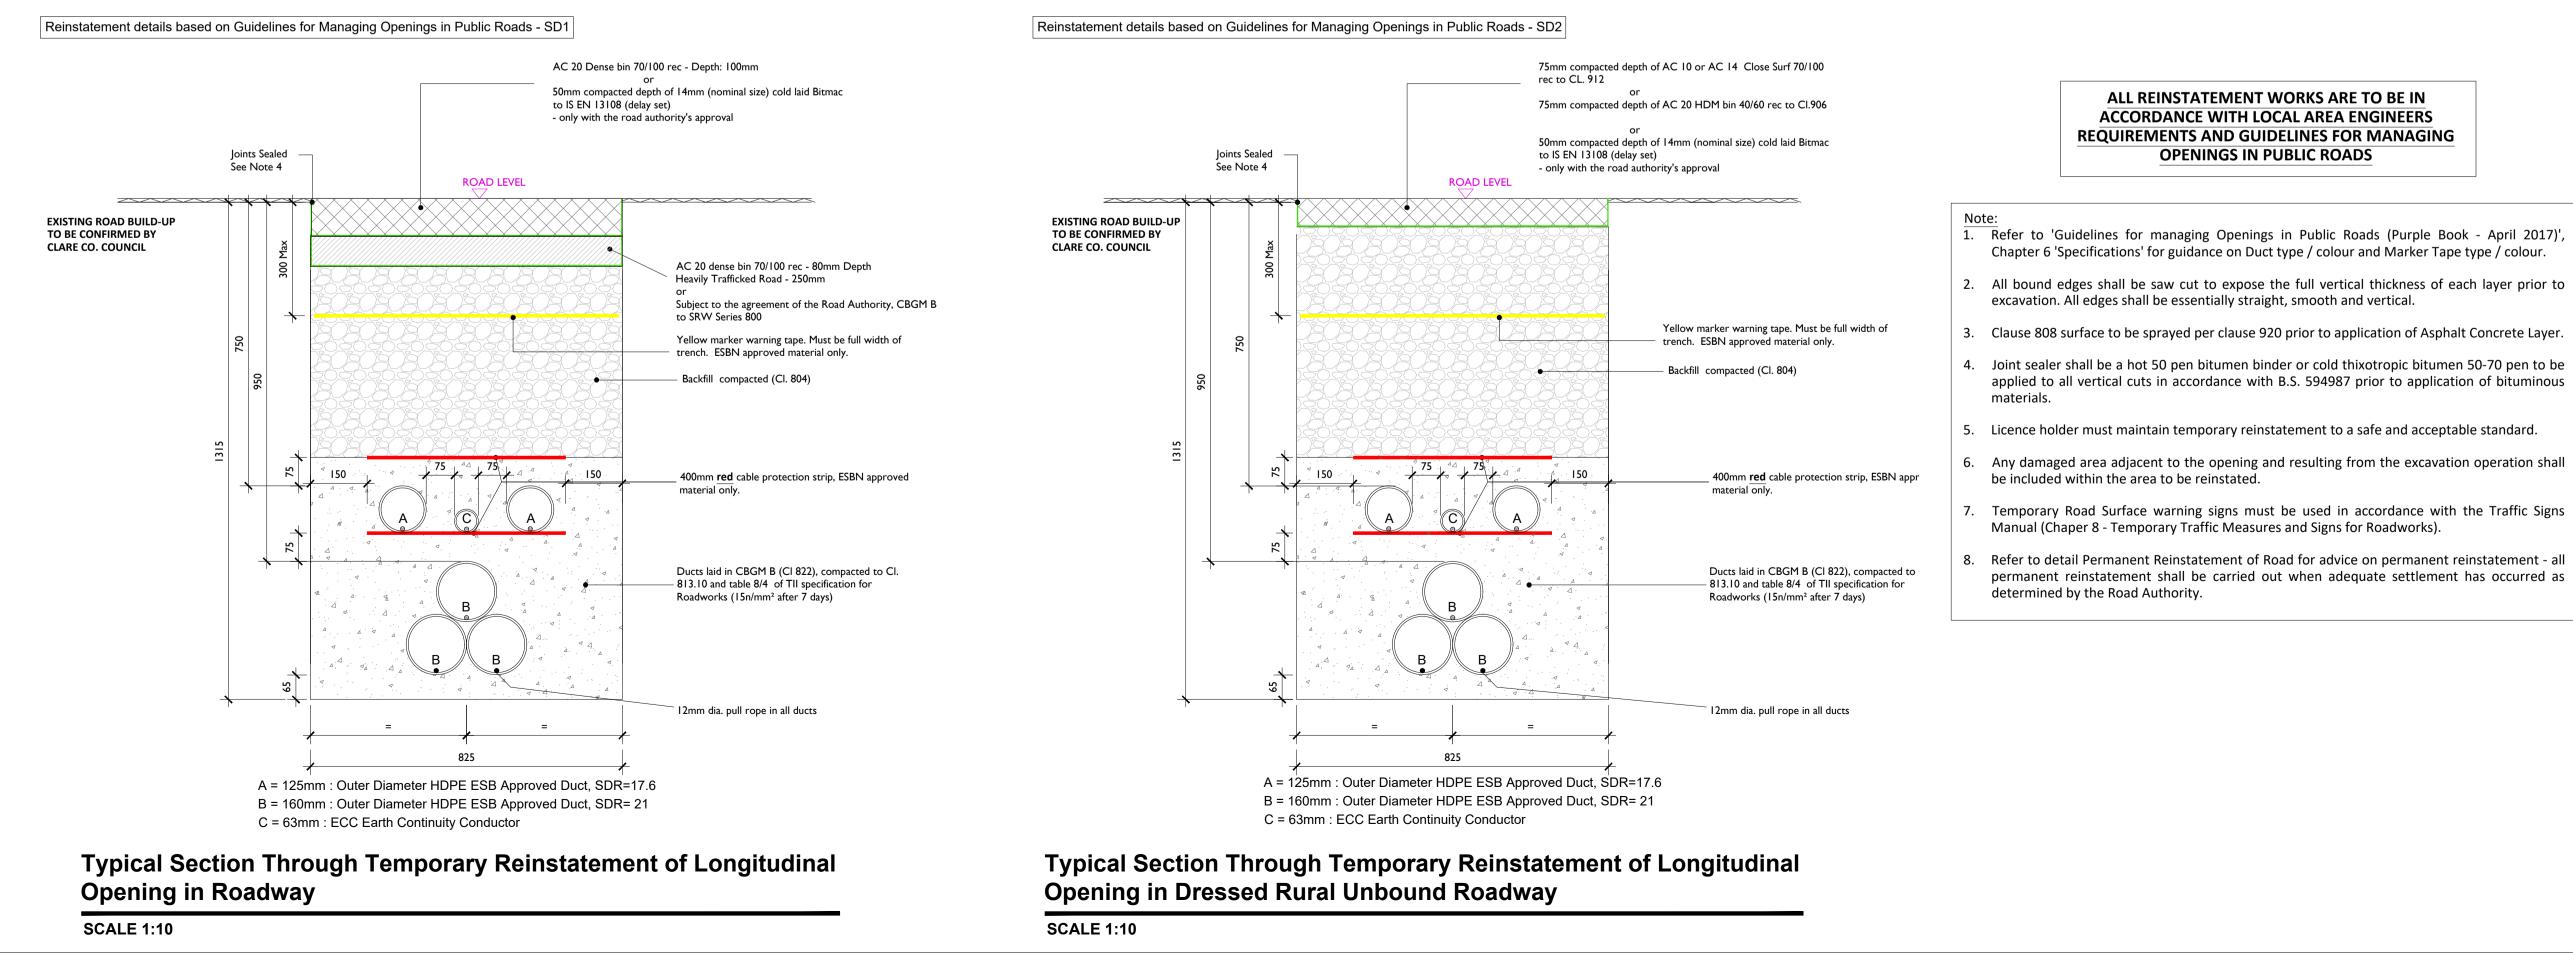

Reinstatement details based on Guidelines for Managing Openings in Public Roads - SD5

SCALE 1:10

ACCORDANCE WITH LOCAL AREA ENGINEERS **REQUIREMENTS AND GUIDELINES FOR MANAGING OPENINGS IN PUBLIC ROADS**

1. Refer to Guidelines for managing Openings in Public Roads (Purple Book - April 2017), Chapter 6

2. All bound edges shall be saw cut to expose the full vertical thickness of each layer prior to

3. Where a temporary surface has been used, material shall be planed out to the depth specified in this drawing. The new permanent surface shall be machined laid and mechanically compacted with

4. Where the trimmed edge of excavation is within 400mm* of a joint / edge, ironwork or other reinstatement, this trimmed edge shall be extended to include same and the area of reinstatement

5. Any damaged area adjacent to the opening and resulting from the excavation operation shall be

6. Clause 808 or Cement Bound Granular Material surface to be sprayed per clause 920 prior to

Joint sealer shall be a hot 50 pen bitumen binder or cold thixtropic bitumen 50 -70 pen to be applied to all vertical cuts in accordance with B.S.594987 prior to application of bituminous materials.

8. For roads without asphalt concrete surface (e.g. may be Cl.804 with double surface dressing), the road authority may as its discretion permit the temporary reinstatement surface of asphalt concrete to be regulated in lieu of excavation and reinstatement; and subsequently surface dressed.

10. Where required by the Road authority the trench may be reinstated with a Cement Bound Granular

ALL REINSTATEMENT WORKS ARE TO BE IN ACCORDANCE WITH LOCAL AREA ENGINEERS **REQUIREMENTS AND GUIDELINES FOR MANAGING OPENINGS IN PUBLIC ROADS**

1. Refer to 'Guidelines for managing Openings in Public Roads (Purple Book - April 2017)', Chapter 6 'Specifications' for guidance on Duct type / colour and Marker Tape type / colour.

3. Clause 808 surface to be sprayed per clause 920 prior to application of Asphalt Concrete Layer.

applied to all vertical cuts in accordance with B.S. 594987 prior to application of bituminous

5. Licence holder must maintain temporary reinstatement to a safe and acceptable standard.

6. Any damaged area adjacent to the opening and resulting from the excavation operation shall

7. Temporary Road Surface warning signs must be used in accordance with the Traffic Signs

8. Refer to detail Permanent Reinstatement of Road for advice on permanent reinstatement - all permanent reinstatement shall be carried out when adequate settlement has occurred as



Head Office Beenreigh, Abbeydorney Tralee, Co. Kerry reland Tel: 00353 66 7135710

Regional Office Basepoint Business Centre Stroudley Road, Basingstoke, Hampshire, RG24 8UP, UK Tel: 00 44 1256406664

PROJECT

Ballycar Wind Farm 110kV UGC Grid Connection

CLIENT



CONSULTANTS

NOTES: -

,	This drawing is to be read in conjunction with relevant
	drawings, specifications and reports
,	Dimensions are in millimeters, unless noted otherwise
	Drawings are not to be scaled use figured dimensions only

Drawings are not to be scaled use figured dimensions only Geogrid may be implemented along the cable trench route where deemed necessary by the contractor or as required by Clare County Council

LEGEND: -

ISSUE/REVISION

P2	12.12.23	Issued for Planning
P1	06.11.23	Issued for Planning
I/R	DATE	DESCRIPTION
	1	I


PROJECT NUMBER

05-923

SHEET TITLE

Typical Ducting Through Regional / Local Roadways

SHEET NUMBER

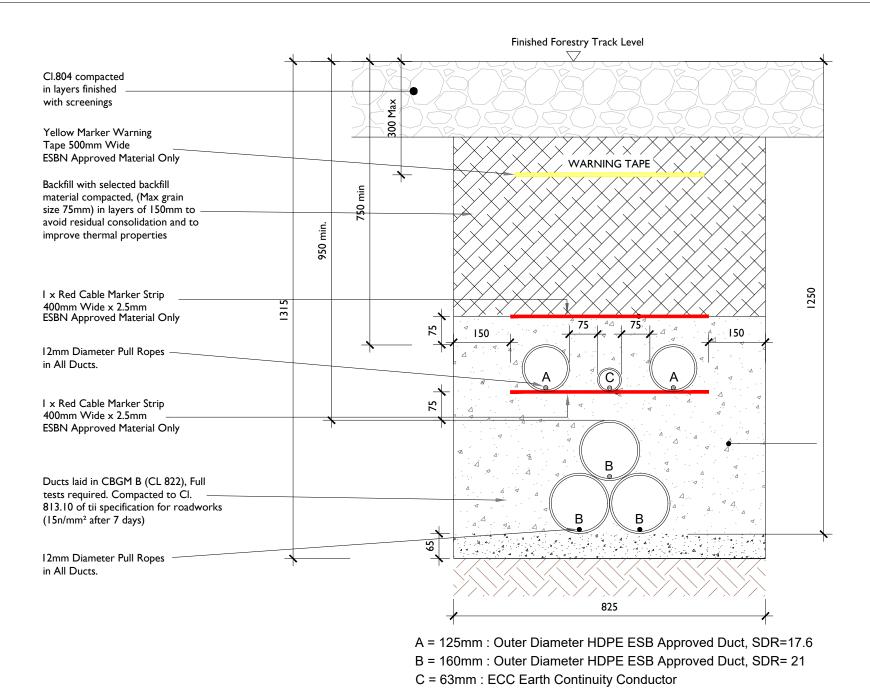

ALL REINSTATEMENT WORKS ARE TO BE IN

ACCORDANCE WITH LANDOWNERS REQUIREMENTS

Ducting Through Forestry Track

SCALE 1:10

Note:

- This drawing is to be read in conjunction with • relevant drawings, specifications and reports
- Dimensions are in millimeters, unless noted otherwise
- Drawings are not to be scaled use figured ٠ dimensions only



Head Office Beenreigh, Abbeydorney, Tralee, Co. Kerry Ireland Tel: 00353 66 7135710



CLIENT

PRC)	ECT
-		

Ballycar Wind Farm 110 kV UGC Grid Connection

PROJECT NUMBER SHEET NUMBER 05923-DR-111 05-923


SHEET TITLE

Ducting through Forestry Track

DRAWING STATUS For Planning

P3	12.01.24	Issued for Planning		
P2	12.12.23	Issued for Planning		
P1	06.11.23	Issued for Planning		
I/R	DATE	DESCRIPTION		


ISSUE/REVISION

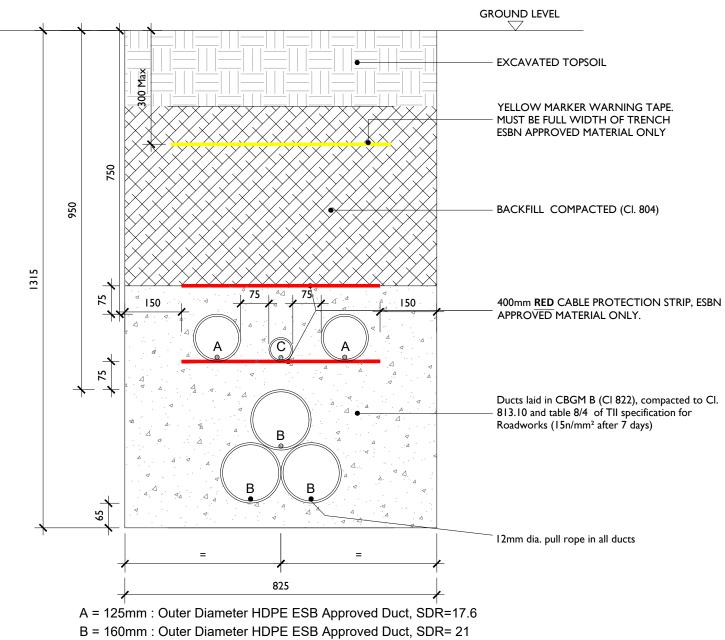

C = 63mm : ECC Earth Continuity Conductor


Typical Section Through Private Lands

SCALE 1:10

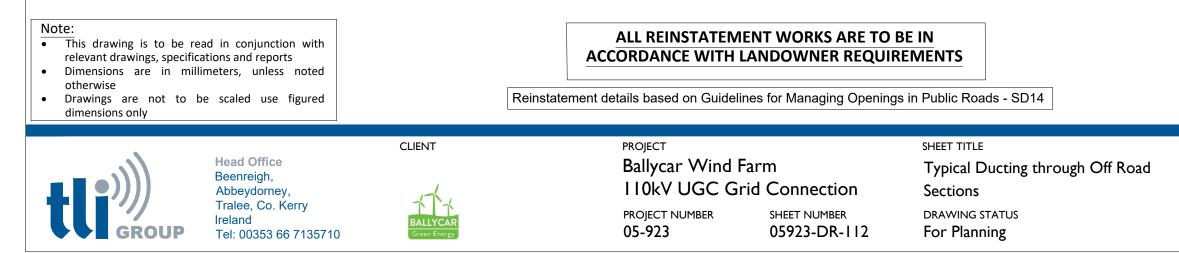

ent	Initials:	Designe
CIII	minuais.	Designe

ISSU	ISSUE/REVISION			
P2	12.12.23	Issued for Planning		
P1	06.11.23	Issued for Planning		
I/R	DATE	DESCRIPTION		

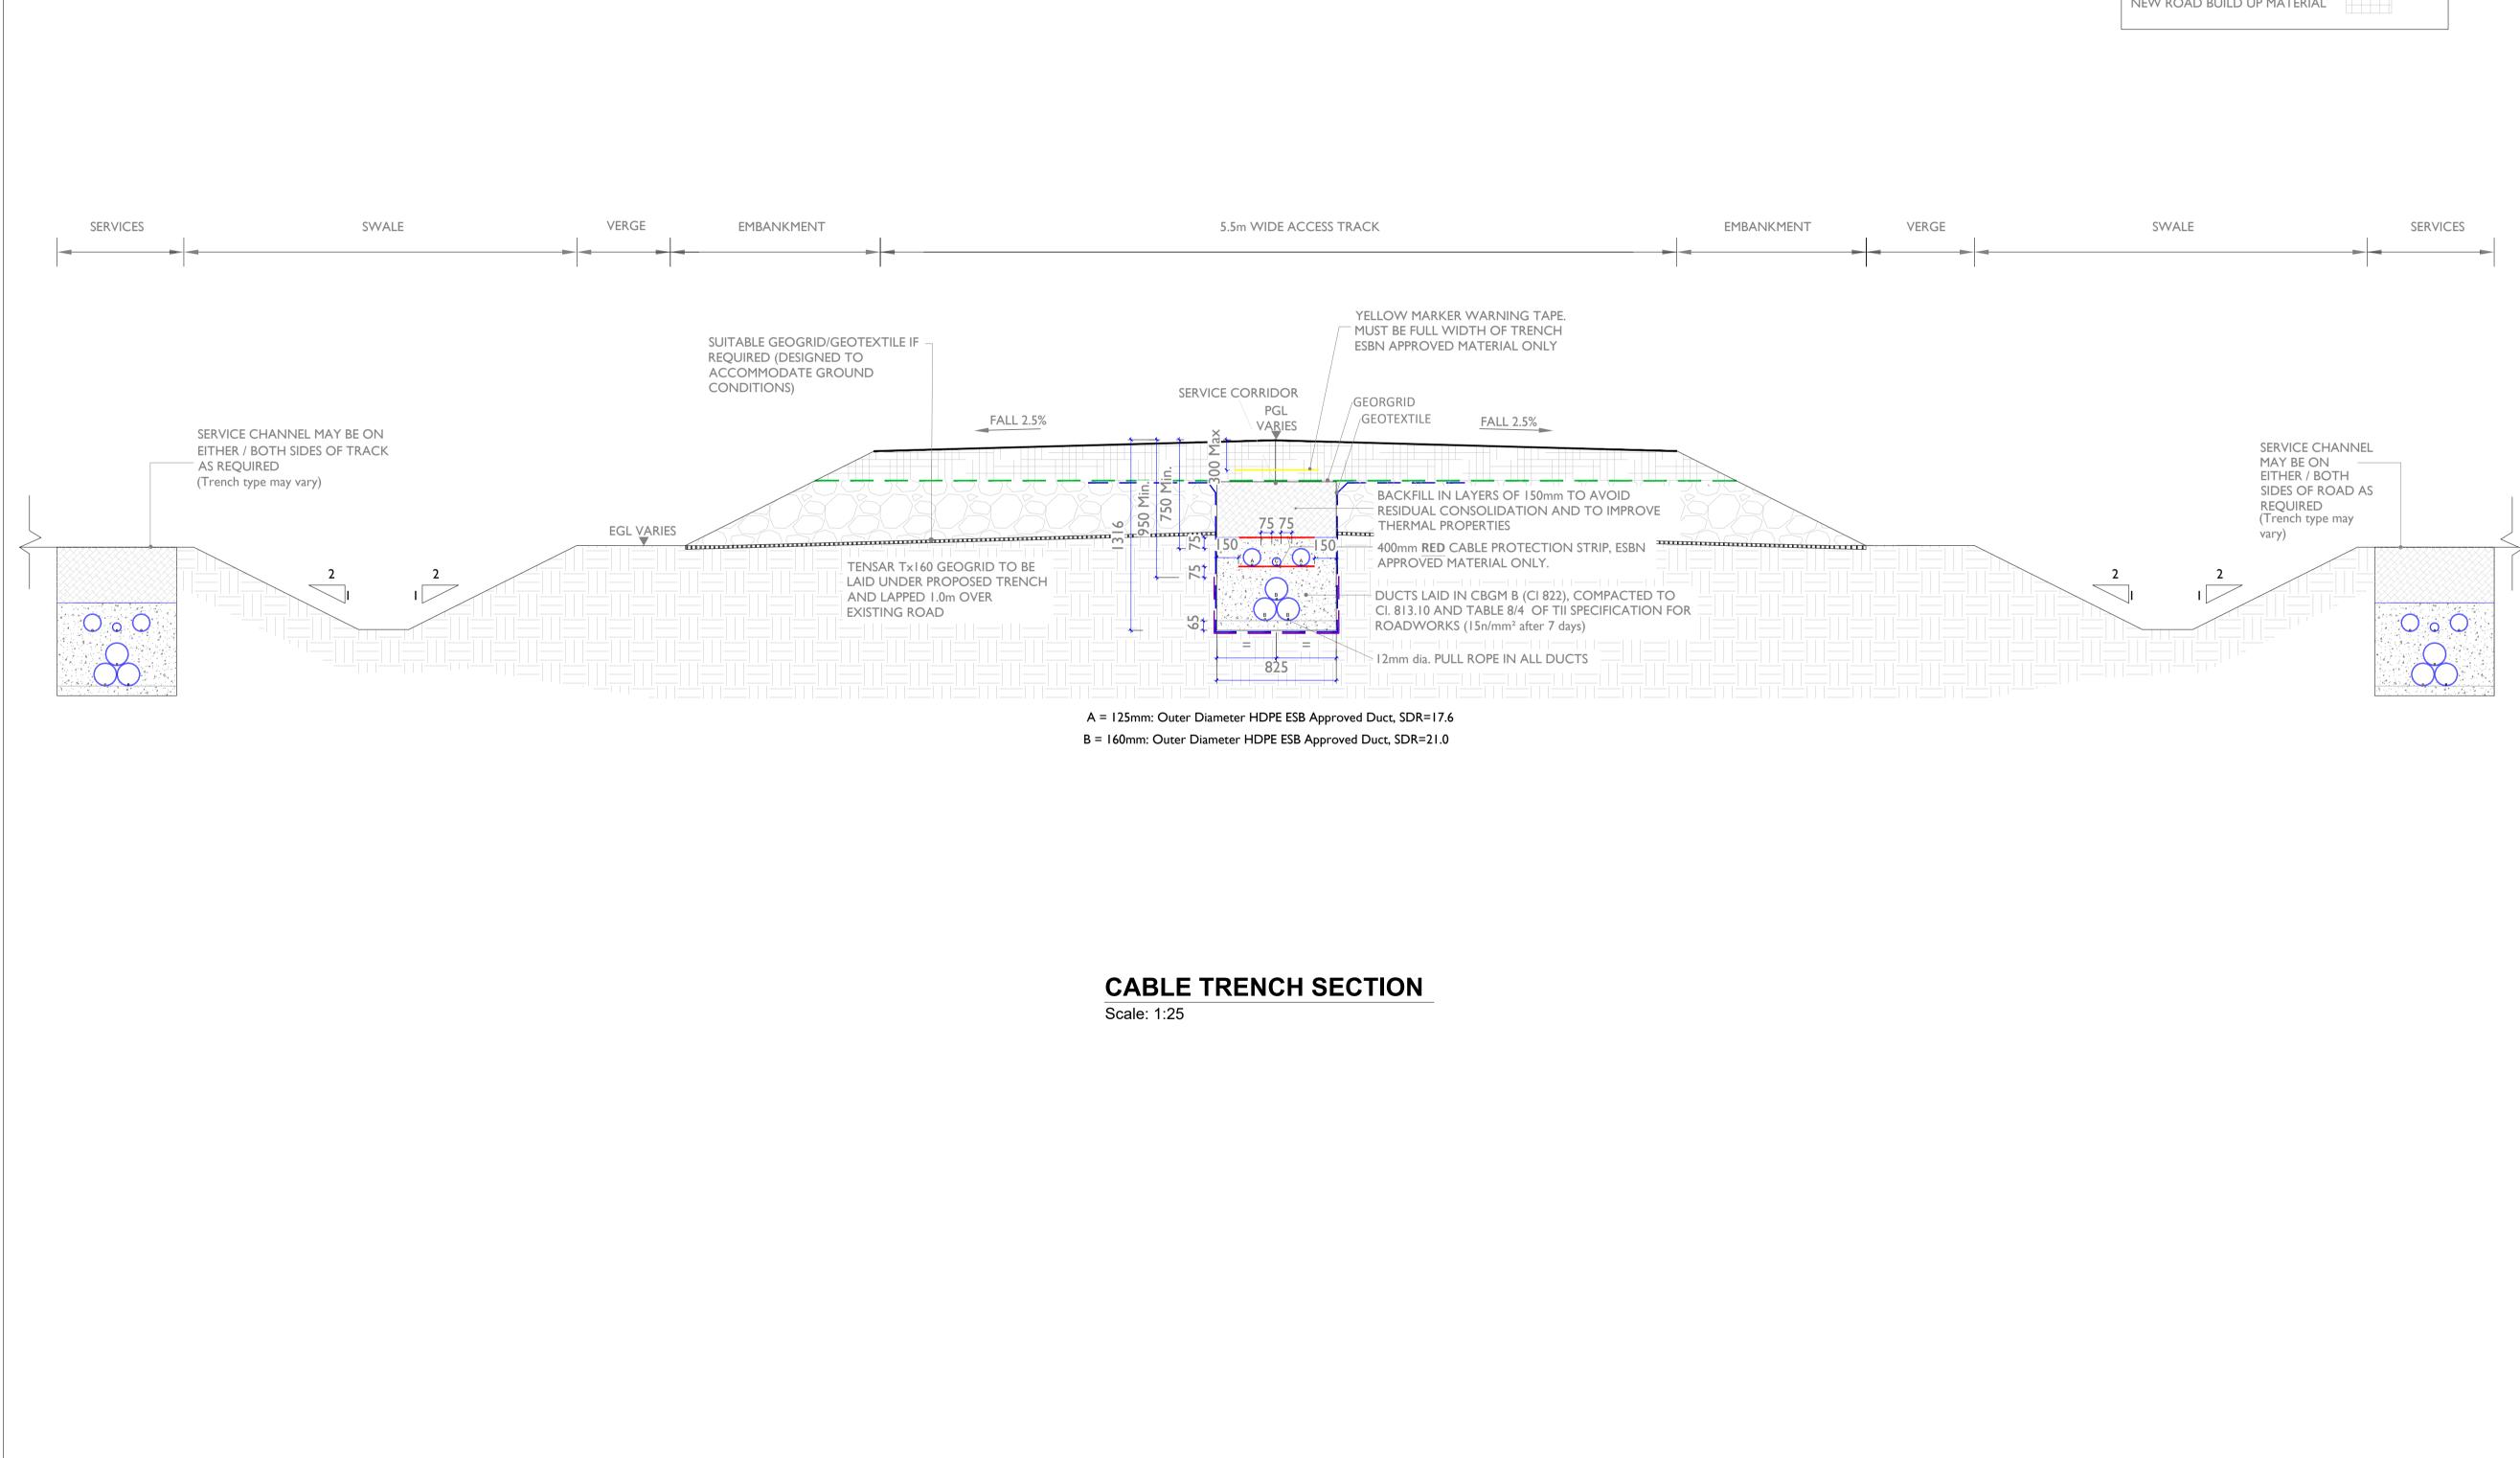

- NOTES: I. This drawing is to be used for EirGrid design approval only and is not to be used for construction.
- 2. For further information reference the latest versions of EirGrid Dr. No. XDC-CBL-STND-H-007 & Functional Specifications in addition to all other relevant
- documentation. 3. Dimensions are in millimeters, unless noted otherwise.
- 4. Drawings are not to be scaled, use figured dimensions only.
- 5. Track-markings to be agreed with the county council and reinstated. 6. Track surfacing build-up and tie in with non floating track sections to be agreed with
- the county council.
 - LEGEND:
 - SECUGRID TENSAR T
 - GEOTEXTI
 - BASE WEAR

 - PEAT COM
 - **EXISTING I**
 - NEW ROAD

0 40/40 GEOGRID	_	 		
×160 GEOGRID	—	 	—	
ILE		 		
RING COURSE				
1POSITION				
MATERIAL		500 2001		
D BUILD UP MATE	ERIAL			

GROUP

Head Office Beenreigh, Abbeydorney, Tralee, Co. Kerry Ireland Tel: 00353 66 7135710

Regional Office Basepoint Business Centre Stroudley Road, Basingstoke, Hampshire, RG24 8UP, UK Tel: 00 44 1256406664

PROJECT

Ballycar Wind Farm 110kV UGC Grid Connection

CLIENT



CONSULTANTS

NOTES: -

Path of cable route and location of associated Joint Bays, Link Boxes and Comms Chambers may vary depending on site conditions.

Other services may be encountered along the route. This drawing is to be used only for the purpose of the planning application and is subject to detailed design.

LEGEND: -

ISSUE/REVISION

P3	12.01.24	Issued for Planning
P2	12.12.23	Issued for Planning
P1	06.11.23	Issued for Planning
I/R	DATE	DESCRIPTION

PROJECT NUMBER

05-923

SHEET TITLE

Typical 110kV Ducting through Existing Floating Track

SHEET NUMBER

NEW TRACK BUILD UP MATERIAL Tree Clearance 20.0m Min -DRAINAGE DITCH SERVICE CORRIDOR **EXISTING GROUND** DRAINAGE DITCH EXISTING GROUND 5500 3250 1000 2000 1000 1000 2000

FINISHED TRACK LEVEL 385 0.0 0.0 8 $\hat{\otimes}$ 2000 t:Ι 1:1 1000 825 825 1000 ALL TRACK BUILDUP MATERIALS TO BE USED TO COMPLY WITH TII (NRA) **SPECIFICATIONS** FOR TRACK WORKS SERIES 900 AND COFORD FOREST TRACK MANUAL

Forestry Fire-Break Track Section

NOTE: CABLE LOCATION SHOWN ARE INDICATIVE AND SUBJECT TO CHANGE DURING DETAIL DESIGN

Scale : 1:30

LEGEND:

GEOTEXTILE

SECUGRID 40/40 GEOGRID TENSAR Tx160 GEOGRID

BASE WEARING COURSE

EXISTING MATERIAL

Note:

- 1. This drawing is subject to planning approval and should not be used for construction.
- This drawing is to be read in conjunction with relevant drawings, specifications and reports. 2.
- 3. Dimensions are in millimeters, unless noted otherwise.
- Drawings are not to be scaled use figured dimensions only. 4.
- 5. Underground cable circuit spacing to be determined during detailed design, road layout may change during detailed design with site investigation results.



Head Office Beenreigh, Abbeydorney, Tralee, Co. Kerry Ireland Tel: 00353 66 7135710



CLIENT

PROJECT

Ballycar Wind Farm 110kV UGC Grid Connection


SHEET NUMBER

05923-DR-115

PROJECT NUMBER 05-923


SHEET TITLE


Forestry Access Track with Service Corridor through existing Fire Break DRAWING STATUS For Planning

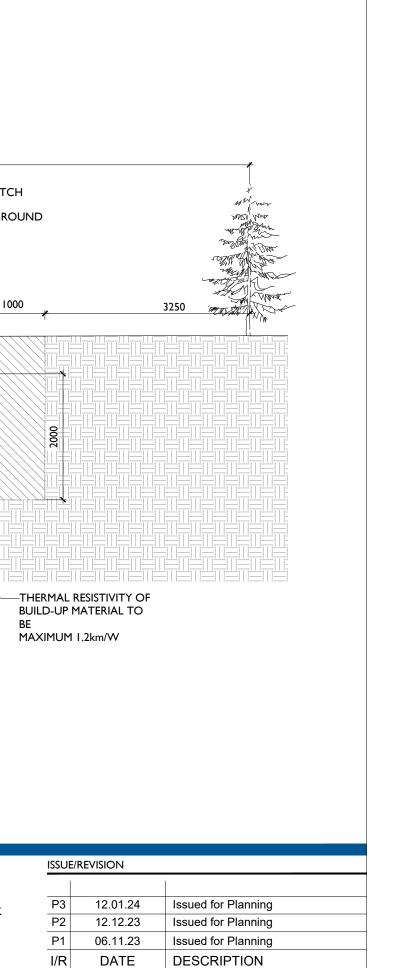

NOTES;


- ALL DIMENSION IN MILLISMETERS UNLESS OTHERWISE STATED Ι.
- REINSTATEMENTS TO COMPLY WITH REQUIREMENTS OF THE 2. RELEVANT LOCAL AUTHORITY/ASSET OWNER
- ENTRANCE AND EXIT DUCTS TO BE IN LINE 3
- ALL MATERIALS AND WORKMANSHIP TO BE IN ACCORDANCE 4 WITH NRA/T.I.I. SPECIFICATION FOR ROADWORKS, MAY 2005 & SUBSEQUENT REVISIONS
- REINFORCED CONCRETE TO BE MINIMUM GRADE C32 / 40, 5. SULPHATE RESISTING CEMENT TO BE USED WHERE AGGRESSIVE SOIL CONDITIONS APPLY, REFER TO TABLE 6.1 OF THE BRITISH STANDARD 8110.
- CARRAIGEWAY COVERS AND FRAMES TO BE TO B.S EN 124. 6.
- ALL COVERS SHALL HAVE "ESB" LOGO INCORPORATED IN THEM 7. TO THE APPROVAL OF EIRGRID
- 8. STEP IRONS TO BE GOT DIPPED GALVANISED TO B.S 729 AND POSITIONED AS SHOWN ON ANY CHAMBER DEEPER THAN 700mm ON THE END REMOTE FROM ANY SIDE ENTRY DUCT.
- CONCRETE PRECAST CHAMBER AND COVER TO BE TESTED 9. THROUGH 5 POINTS, 40 TONNES VERTICAL STATIC LOADING TEST BY AN INDEPENDENT TEST COMPANY. IF REQUIRED, FURTHER DETAILS WILL BE PROVIDED BY EIRGRID.
- 10. FINAL POSITION OF C2 CHAMBERS SHALL BE AGREED WITH EIRGRID
- 11. IN A FOREST ENVIROMENT, BACKFILL WITH LEAN MIX OUTSIDE THE COVER FRAME WHERE THE ASPHALT IS SHOWN

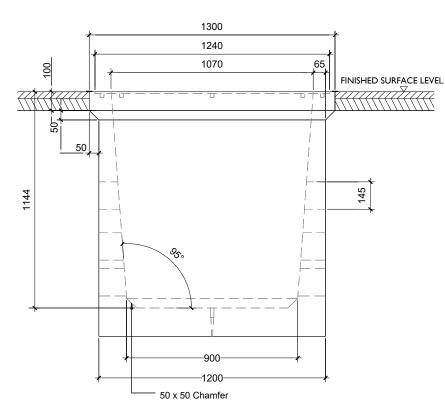


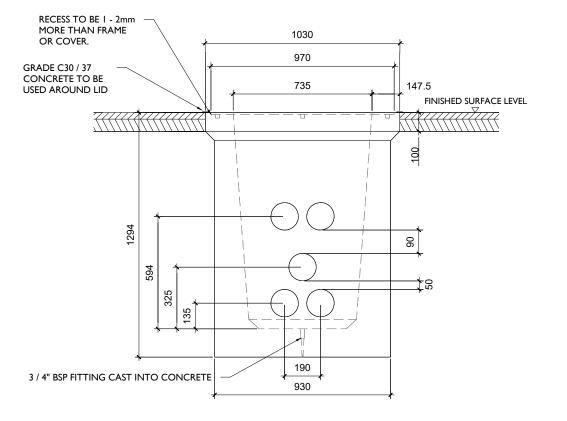

C2 Chamber Detail - Section A

SCALE 1:20

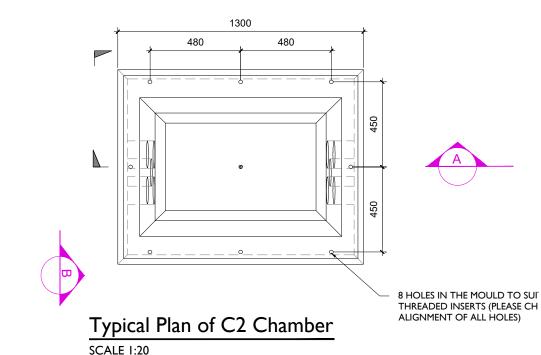

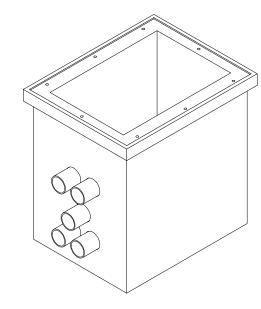

Isometric : C2 Chamber Arrangement

SCALE I:20



Head Office Beenreigh, Abbeydorney, Tralee, Co. Kerry Ireland Tel: 00353 66 7135710

CLIENT


PROJECT		
Ballycar Wind Farm	ı	
110kV UGC Grid Connection		
PROJECT NUMBER	SHEET NUMBER	
05-923	05923-DR-116	

SHEET TITLE **Typical Communications Chamber Details** DRAWING STATUS For Planning


SCALE I:20

C2 Chamber Detail - Section B


ISSUI	ISSUE/REVISION				
P2	12.12.23	Issued for Planning			
P1	06.11.23	Issued for Planning			
I/R	DATE	DESCRIPTION			

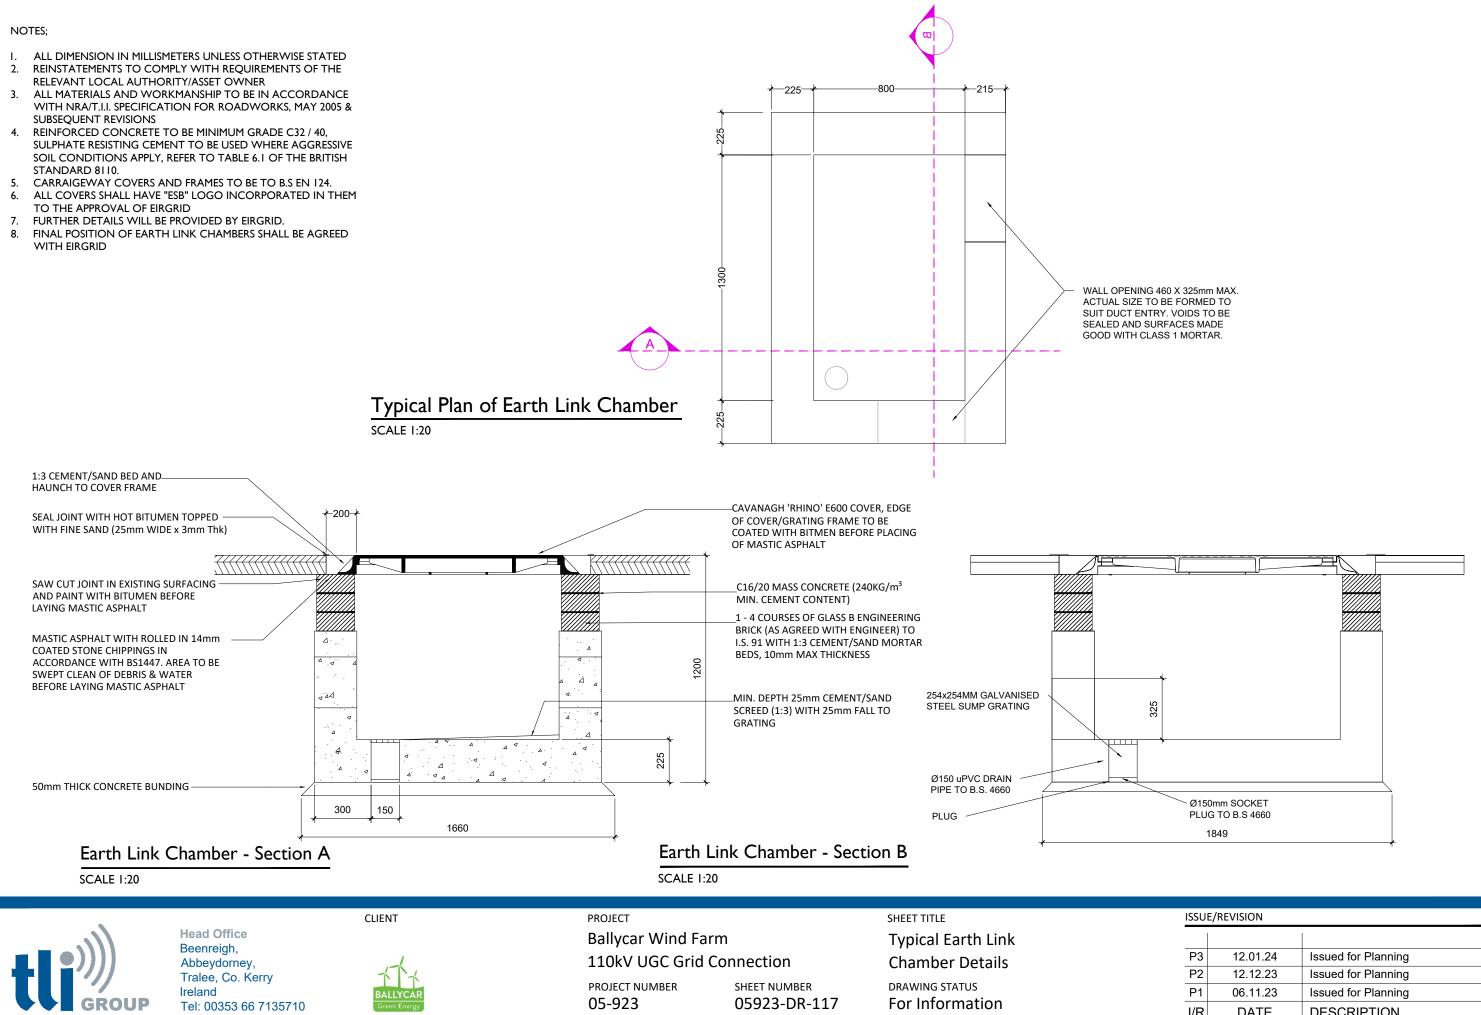

ISSUI	e/revision	
P3	12.01.24	Issued for Planning
P2	12.12.23	Issued for Planning
P1	06.11.23	Issued for Planning
I/R	DATE	DESCRIPTION

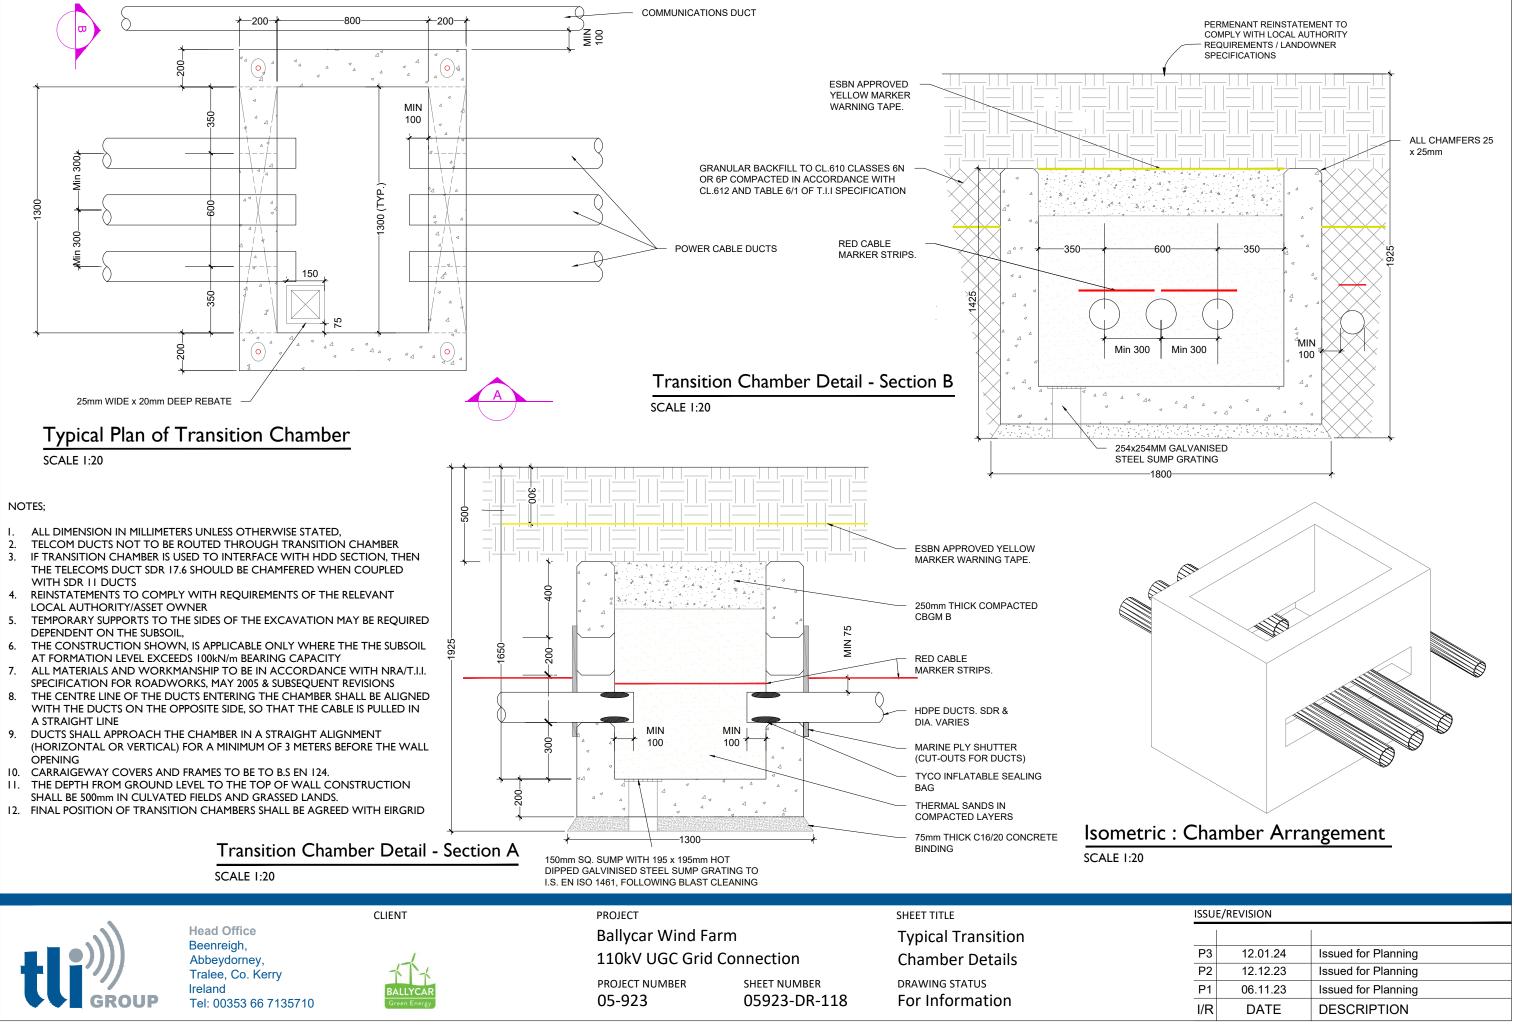

P3	12.01.24	Issued for Planning
P2	12.12.23	Issued for Planning
P1	06.11.23	Issued for Planning
I/R	DATE	DESCRIPTION

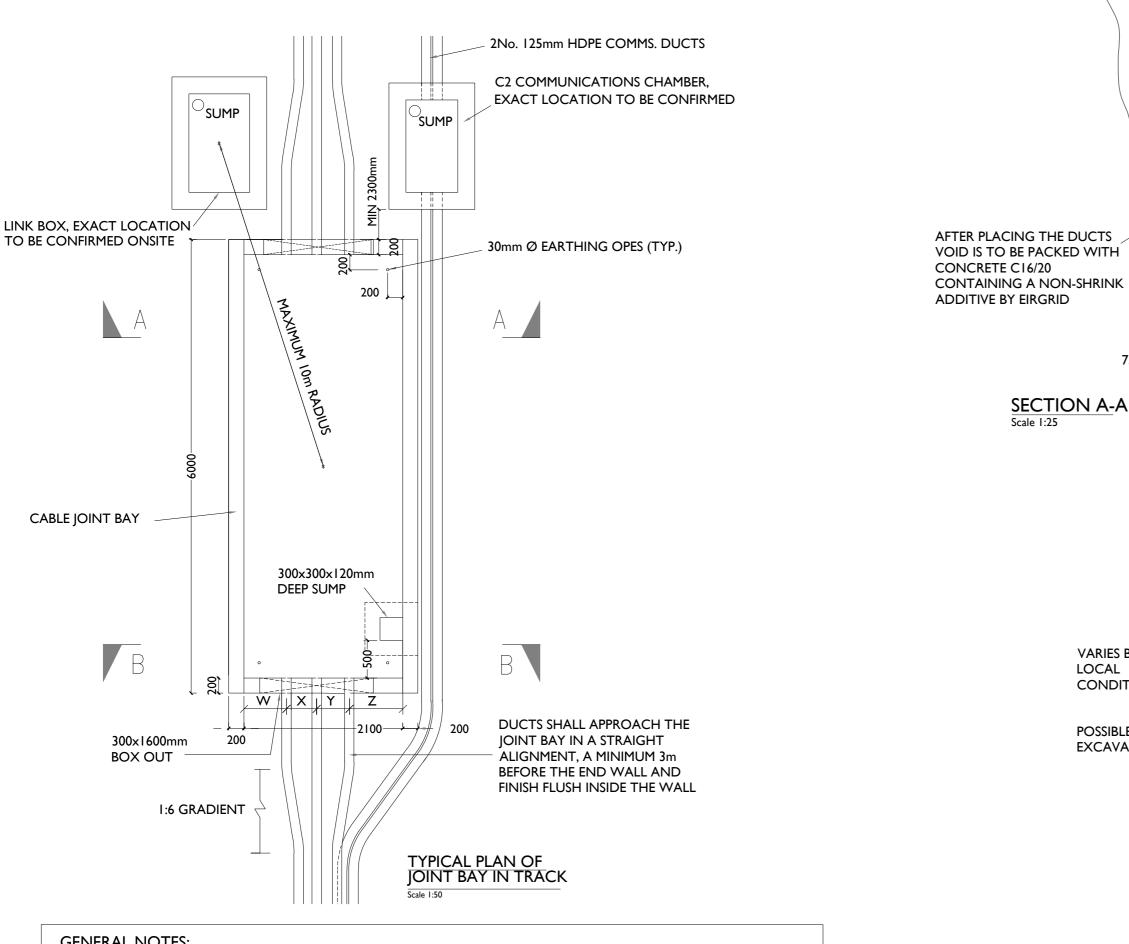

GENERAL NOTES:

- THIS DRAWING IS TO BE USED ONLY FOR THE PURPOSE OF ISSUE AND IS SUBJECT TO AMENDMENT.
- THIS DRAWING IS TO BE READ IN CONJUNCTION WITH ALL OTHER RELEVANT INFORMATION 2.
- DO NOT SCALE FROM THIS DRAWING, USE ONLY PRINTED DIMENSIONS. 3.
- 4. ALL DIMENSIONS ARE IN MILLIMETRES UNLESS DEFINED OTHERWISE.
- STANDARD FOUNDATIONS ARE BASED ON THE FORMATION AT THE BASE OF THE EXCAVATION SHOWN BEING SUITABLE FOR A MINIMUM BEARING PRESSURE OF 100kN/m2. SUITABILITY OF STANDARD JOINT BAY 5. FOUNDATIONS CAN ONLY BE CONFIRMED FOLLOWING GROUND INVESTIGATION. HAND VANE TESTS SHALL BE REQUIRED AS PER GI SPECIFICATION. WHERE SPECIFIED MINIMUM BEARING PRESSURE IS NOT ACHIEVABLE,
- AND WHERE PEAT IS ENCOUNTERED, THE CONTRACTOR SHALL REFER TO THE ENGINEER FOR GUIDANCE. THE LENGTH OF BONDING LEAD LENGTH SHALL IN NO CASE EXCEED 10M. NO JOINTS IN BONDING CABLE ARE 6. PERMITTED.
- ALL EARTHING SHALL BE IN ACCORDANCE WITH ENA ER C55 AND EIRGRID/ESBN FUNCTIONAL SPECIFICATION 7.
- 8. THE DEPTH FROM GROUND/TRACK LEVELTO THE TOP OF THE CONCRETE WALL SHALL BE
- A. 500MM IN CULTIVATED FIELDS & GRASS LAND
- LINK BOX CHAMBERS TO BE POSITIONED AT THE EDGE OR OFF TRACK 9.
- 10. LINK BOX CHAMBERS AND C2 COMM CHAMBERS FINAL POSITIONING TO BE AGREED WITH EIRGRID PRIOR TO INSTALLATION

DB


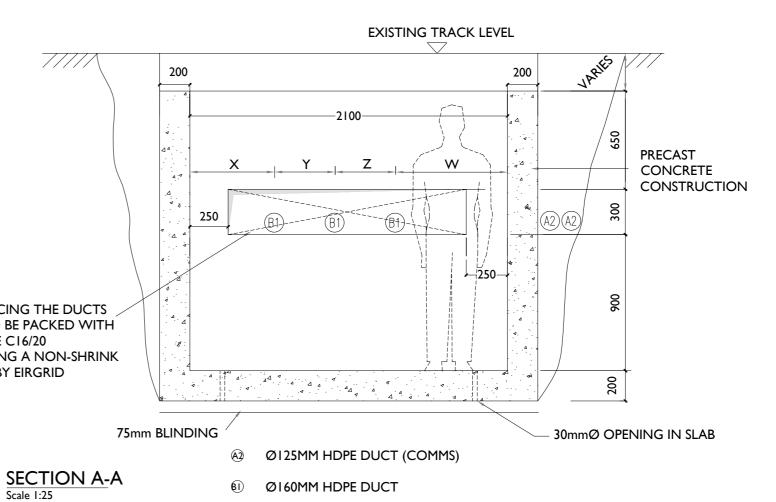


TABLE 1 - DUCT SEPERATION

	х	Y	Z	W
110kV	560	400	400	760
220kV	375	675	675	375



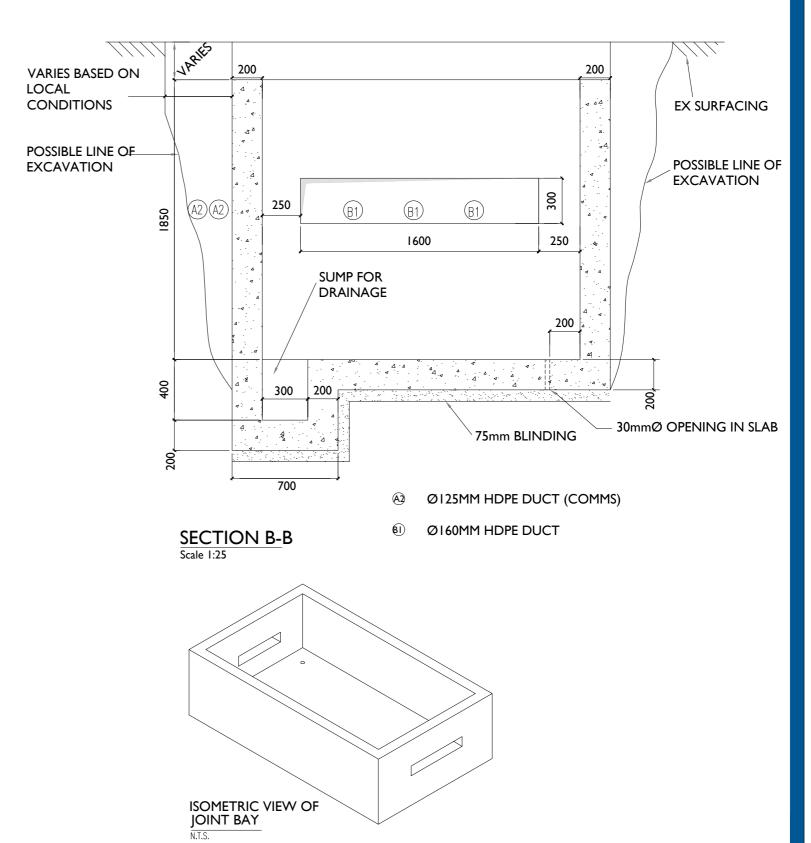

Ballycar Wind Farm 110kV UGC Grid Connection

CLIENT

CONSULTANTS

NOTES: -

LEGEND: -


ISS	ISSUE/REVISION		
_			
_			
P3	12.01.24	Issued for Planning	
P2	12.12.23	Issued for Planning	
P1	06.11.23	Issued for Planning	
I/R	DATE	DESCRIPTION	
PR	PROJECT NUMBER		


05-923 SHEET TITLE

Joint Bay Section Detail

SHEET NUMBER




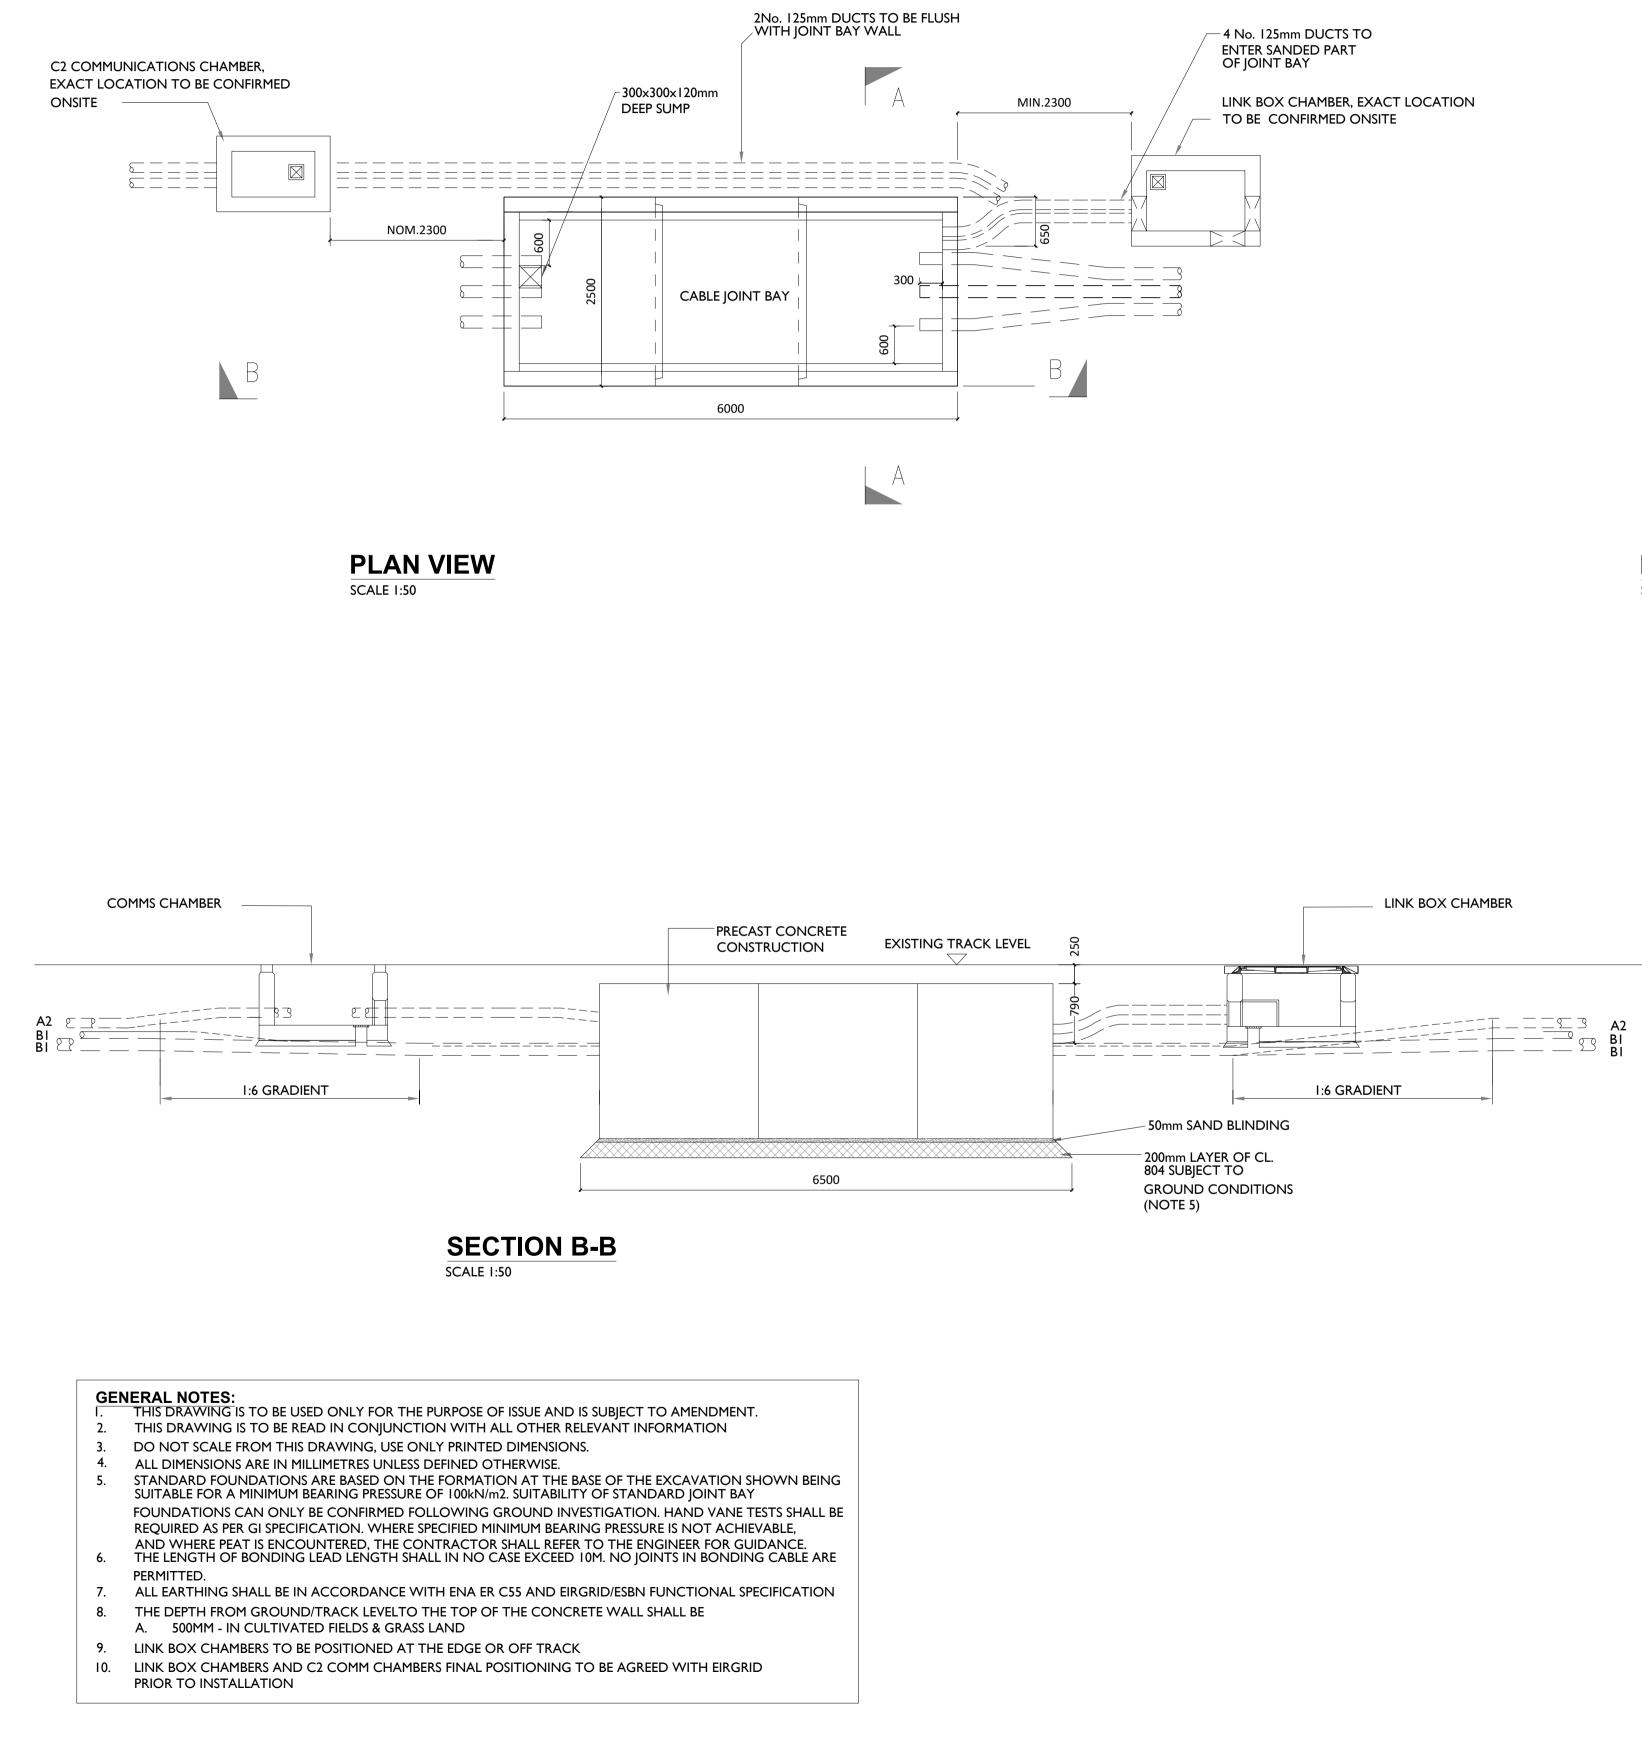

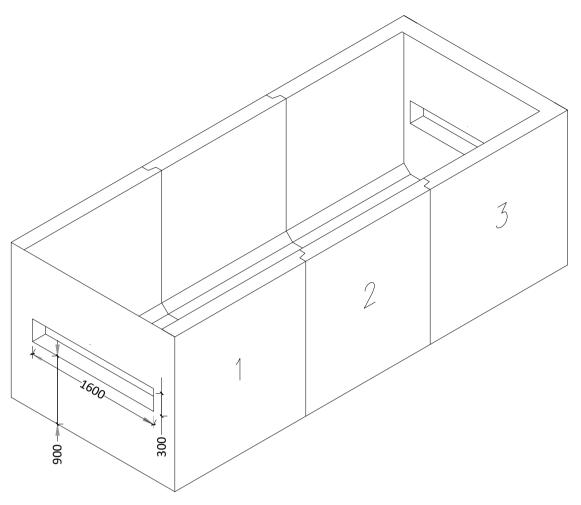

ISOMETRIC VIEW PRECAST CHAMBER SCALE 1:50



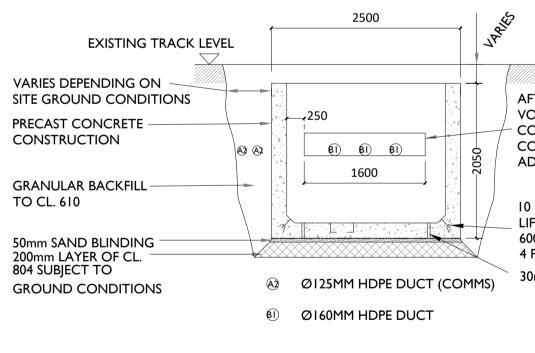

SECTION A-A SCALE 1:50



Head Office Beenreigh, Abbeydorney, Tralee, Co. Kerry Ireland Tel: 00353 66 7135710

PROJECT

Regional Office Basepoint Business Centre Stroudley Road, Basingstoke, Hampshire, RG24 8UP, UK Tel: 00 44 1256406664

Ballycar Wind Farm 110kV UGC Grid Connection

CLIENT



CONSULTANTS

NOTES: -

See General Notes

LEGEND: -

ISSUE/REVISION

P3	12.01.24	Issued for Planning
P2	12.12.23	Issued for Planning
P1	06.11.23	Issued for Planning
I/R	DATE	DESCRIPTION

PROJECT NUMBER

05-923

SHEET TITLE

110kV Joint Bay General Arrangement and Details


SHEET NUMBER

05923-DR-120

AFTER PLACING THE DUCTS VOID IS TO BE PACKED WITH CONCRETE C16/20 CONTAINING A NON-SHRINK ADDITIVE BY EIRGRID

10 T HALFEN DEHA SPHERICAL LIFTING ANCHORS. REF: 6000-10.0-0170 4 PER UNIT

30mmØ OPENING IN SLAB

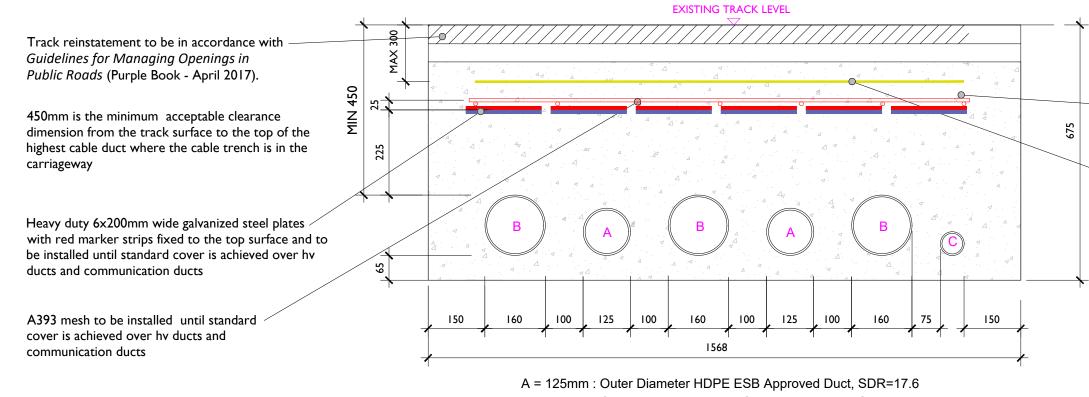

B = 160mm : Outer Diameter HDPE ESB Approved Duct, SDR= 21

C = 63mm : ECC Earth Continuity Conductor

Typical Section Through Ducting in Flat Formation


SCALE 1:10




C25/30 concrete to be in accordance with specification for road works 1000. 20mm max : of aggregate, with minimum duct spacing of 75r Min. cover to steel - 50mm.

4 X 400mm ESBN yellow warning tape across full width of trench

ISSUE	ISSUE/REVISION		
P3	12.01.24	Issued for Planning	
P2	12.12.23	Issued for Planning	
P1	06.11.23	Issued for Planning	
I/R	DATE	DESCRIPTION	

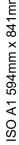

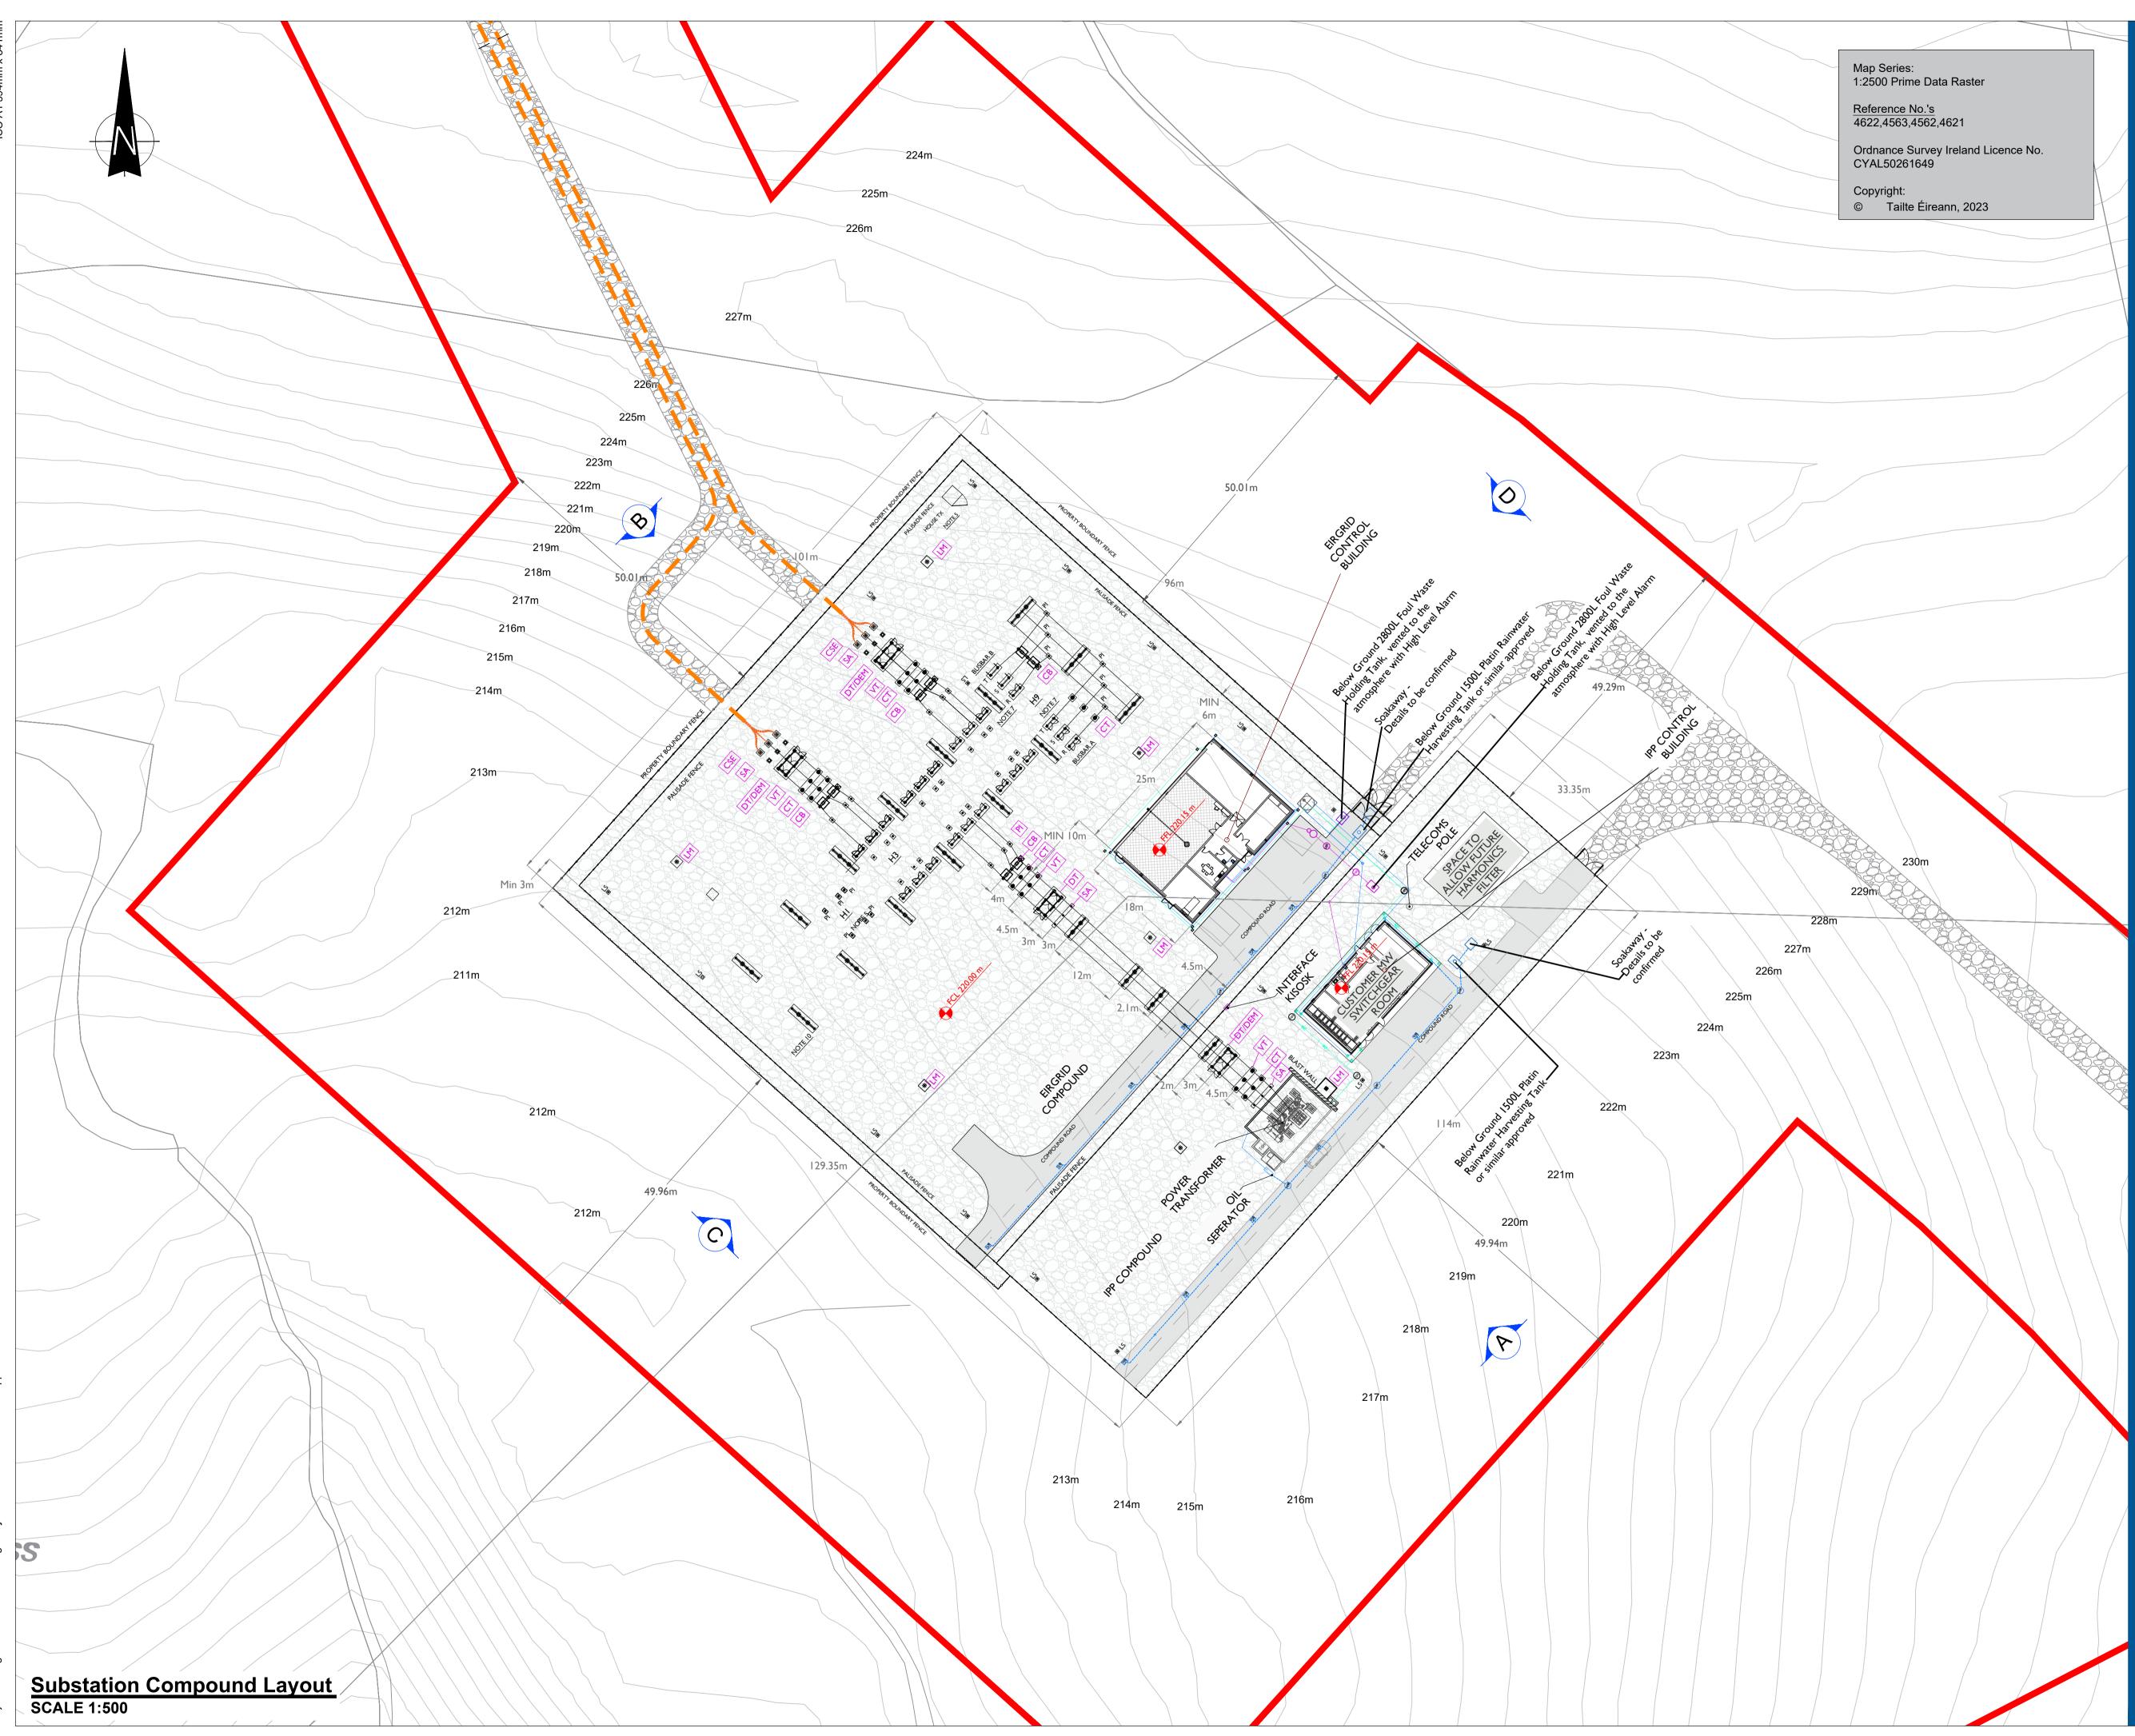



Head Office Beenreigh, Abbeydorney, Tralee, Co. Kerry Ireland Tel: 00353 66 7135710

Regional Office Basepoint Business Centre Stroudley Road, Basingstoke, Hampshire, RG24 8UP, UK Tel: 00 44 1256406664

PROJECT

Ballycar Wind Farm 110kV UGC Grid Connection

CLIENT



CONSULTANTS

NOTES: -

- This drawing is to be read in conjunction with relevant drawings, specifications and reports.
 Drawings are not to be scaled use figured dimensions only.
 All levels shown are in m O.D unless noted otherwise.
- For Elevation Ref. to Drawing 05923-DR-131.

LEGEND: -

UG Cable Route shown thus (1.5 km) Planning Application Boundary Contours

Access track

14.0

ISSUE/REVISION

Ρ7	12.01.24	Issued for Planning
P6	12.12.23	Issued for Planning
P5	05.12.23	Issued for Planning
Ρ4	06.11.23	Issued for Planning
P3	24.05.23	Issued for Planning
P2	12.01.23	Issued for Planning
P1	06.12.22	Issued for Information
I/R	DATE	DESCRIPTION
	•	

PROJECT NUMBER


05-923

SHEET TITLE

Substation Compound Layout

SHEET NUMBER

⁼⁼⁼⁼

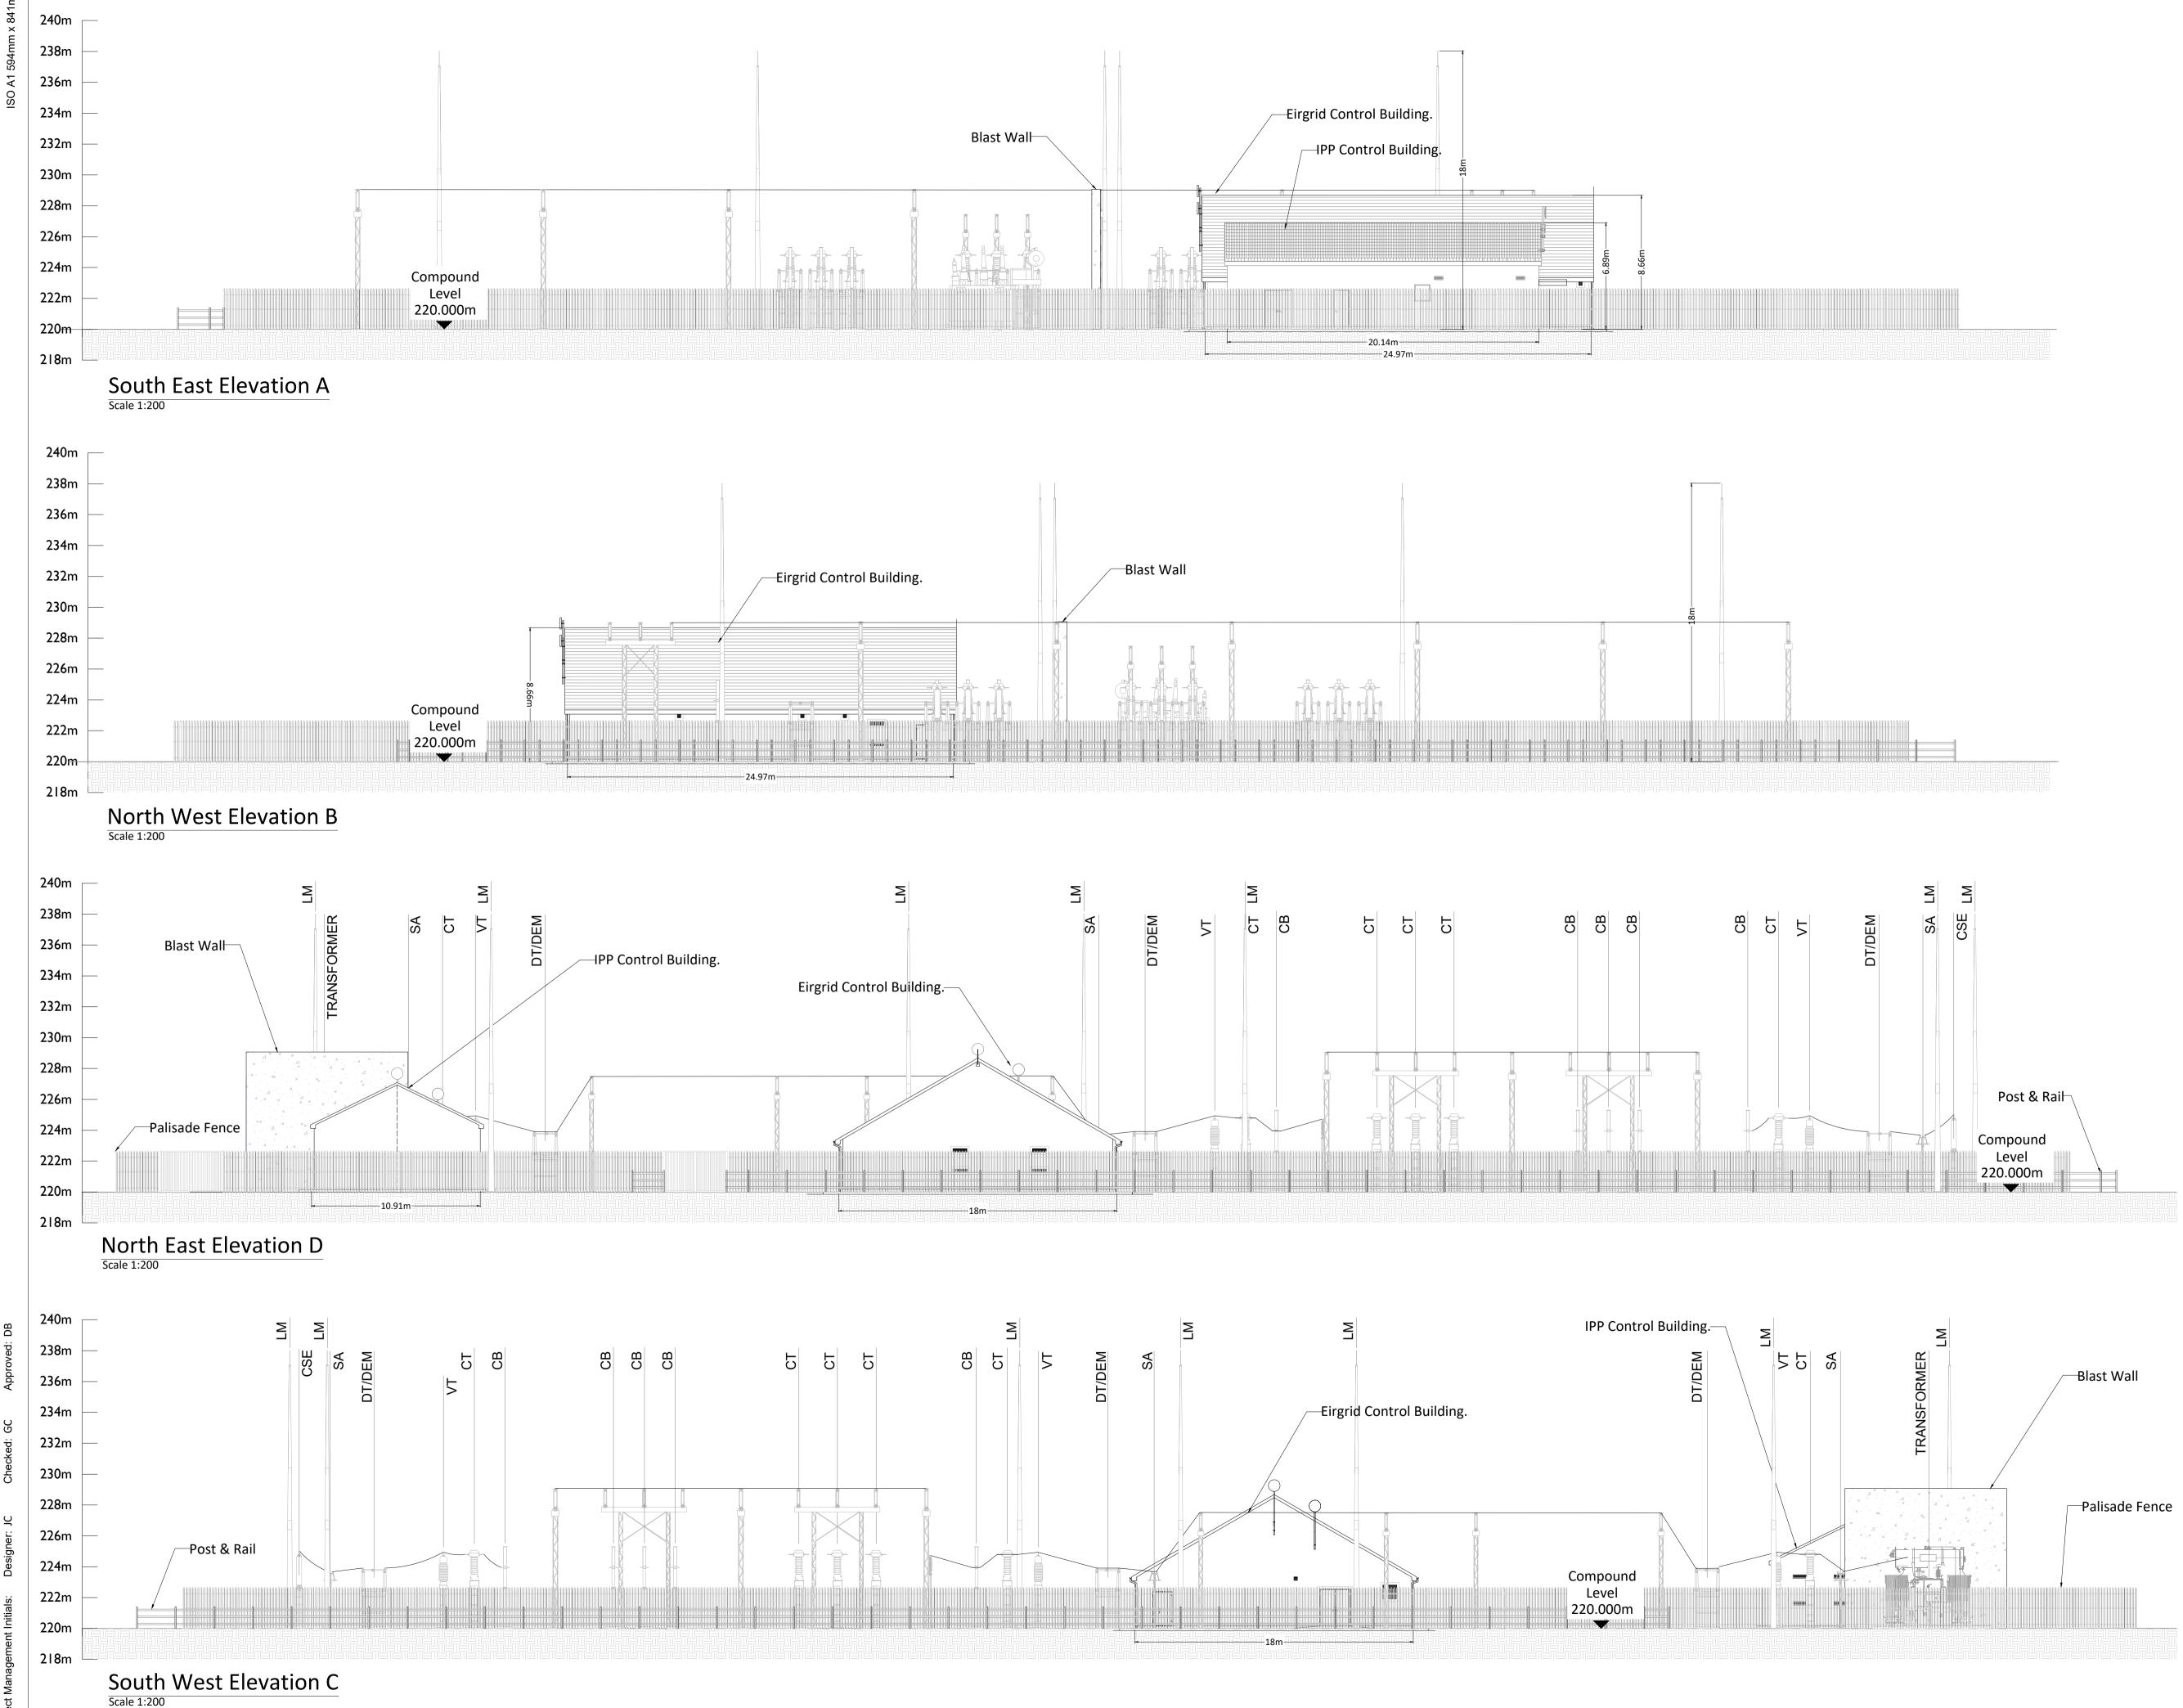

S 2

DB



Head Office Beenreigh, Abbeydorney, Tralee, Co. Kerry Ireland Tel: 00353 66 7135710

Regional Office Basepoint Business Centre Stroudley Road, Basingstoke, Hampshire, RG24 8UP, UK Tel: 00 44 1256406664

PROJECT

Ballycar Wind Farm 110kV UGC Grid Connection

CLIENT



CONSULTANTS

NOTES: -

- I. Layout and Arrangements of Substation Building and Electrical Equipment is shown indicatively and for illustration purposes only.
- 2. Dimensions shown are as per current Eirgrid Specifications at the time of submission. Dimensions may vary at time of construction to reflect any revisions to EirGrid Specifications.
- 3. Final Specifications of Buildings and Electrical Equipment is to be as per EirGrid and ESB Specifications.
- 4. The Elevation of the Compound is indicative and will be finalised to project design to ensure Cut/Fill Earthworks associated with the construction of the Compound are balanced.

LEGEND: -

	Description
CSE	Cable Sealing End.
SA	Surge Arrester.
DL/DE	Line / Earth Disconnect.
VT	Voltage Transformer.
СТ	Current Transformer.
СВ	Circuit Breaker.
PI	Post Insulator.
LM	Lightning Mast.

ISSUE/REVISION

12.01.24	Issued for Planning
12.12.23	Issued for Planning
06.11.23	Issued for Planning
24.05.23	Issued for Planning
12.01.23	Issued for Planning
06.12.22	Issued for Information
DATE	DESCRIPTION
	12.12.23 06.11.23 24.05.23 12.01.23 06.12.22


PROJECT NUMBER

05-923

SHEET TITLE

Substation Elevations

SHEET NUMBER

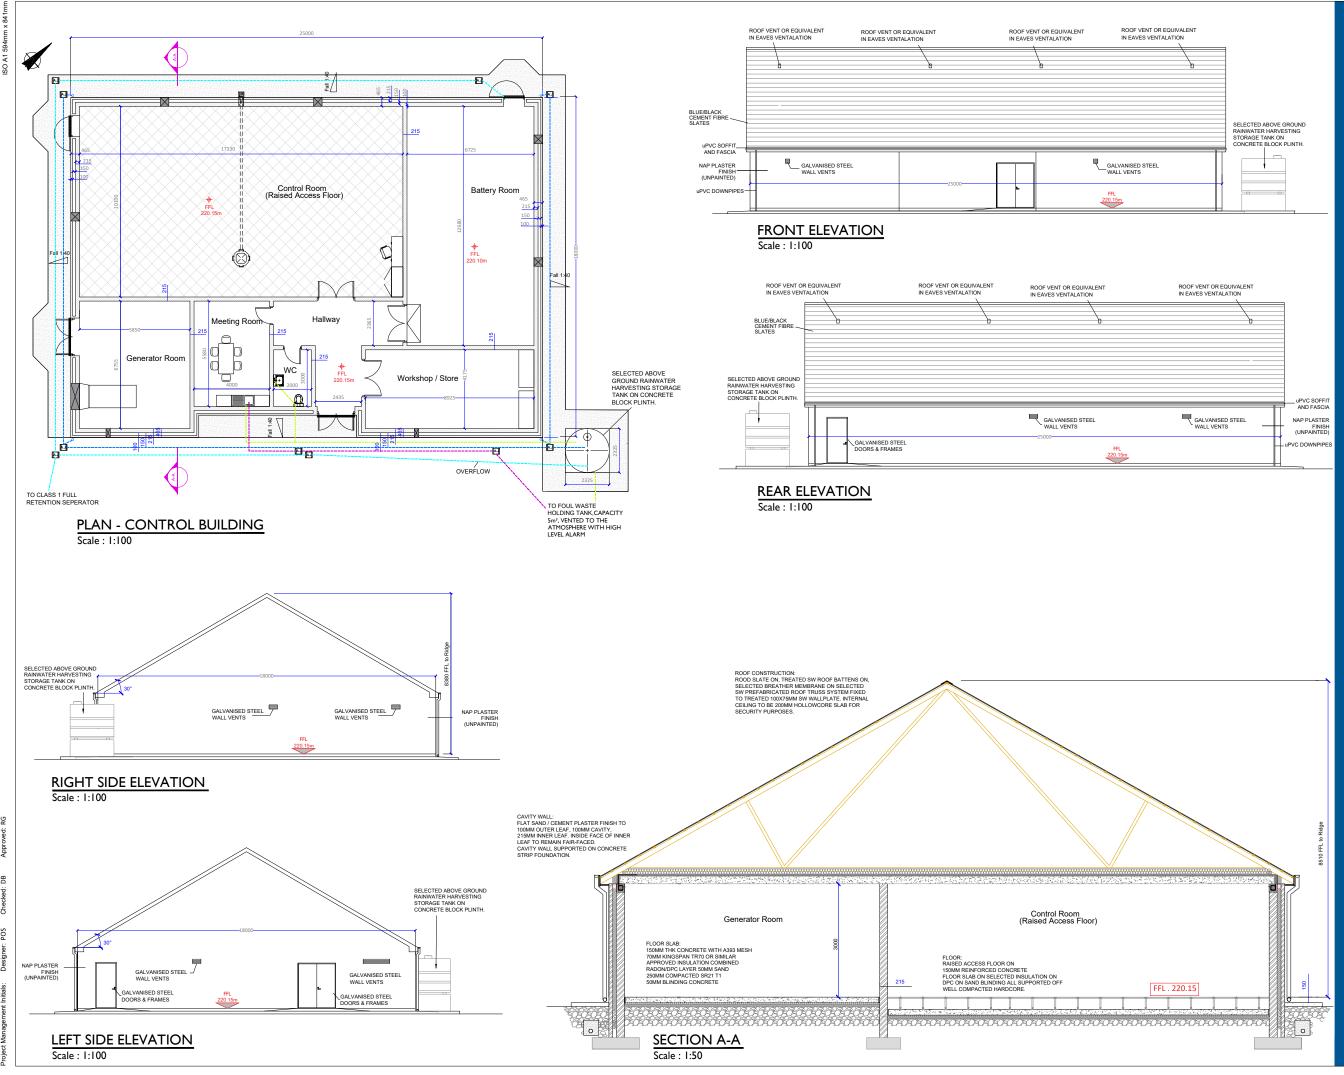



Beenreigh, Abbeydorne Tralee, Co, Kerry reland Tel: 00353 66 7135710

Basepoint Business Centre Stroudley Road, Basingstoke Hampshire, RG24 8UP, UK Tel: 00 44 1256406664

PROJECT

Ballycar Wind Farm 110kV UGC Grid Connection

CLIENT



CONSULTANTS

NOTES

- 1. Layout and Arrangements of Substation Building and Electrical Equipment is shown indicatively and for illustration purposes only.
- Dimensions shown are as per current EirGrid Specifications at the time of submission. Dimensions may vary at time of construction to reflect any revisions to EirGrid Specifications.
- Final Specifications of Buildings and Electrical Equip to be as per Eirgrid and ESB Specifications.
- The Elevation of the Compound will be depicted by localize Topography such that Cut/Fill Earthworks associated with the construction of the Compound are balanced. LEGEND: -

Levels shown thus

Concrete Footpath shown thus

ISSUE/REVISION

12.12.23	Issued for Planning
06.11.23	Issued for Planning
24.05.23	Issued for Planning
12.01.23	Issued for Planning
06.12.22	Issued for Information
DATE	DESCRIPTION
	06.11.23 24.05.23 12.01.23 06.12.22

PROJECT NUMBER


05-923

SHEET TITLE

Control Building - Plan & Elevations & Section

SHEET NUMBER



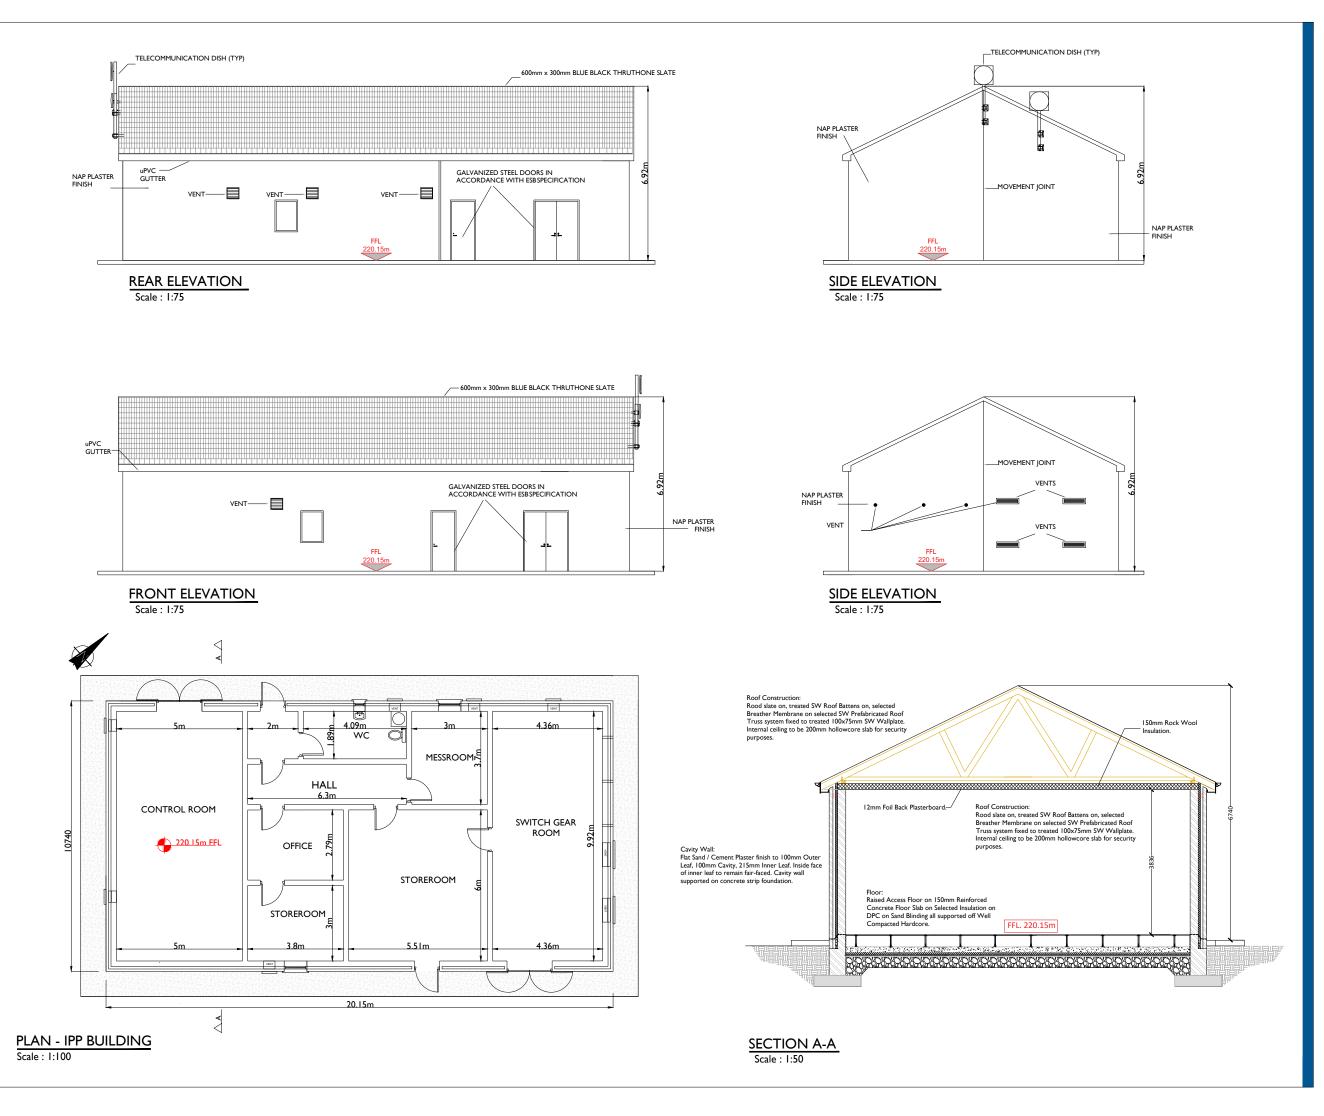



Beenreigh, Abbeydorney Tralee, Co. Kerry Ireland Tel: 00353 66 7135710

Basepoint Business Centre Stroudley Road, Basingstoke Hampshire, RG24 8UP, UK Tel: 00 44 1256406664

PROJECT

Ballycar Wind Farm 110kV UGC Grid Connection

CLIENT



CONSULTANTS

NOTES: -

- 1. Layout and Arrangements of Substation Building and Electrical Equipment is shown indicatively and for illustration purposes only.
- Dimensions shown are as per current EirGrid Specifications at the time of submission. Dimensions may vary at time of construction to reflect any revisions to EirGrid Specifications.
- Final Specifications of Buildings and Electrical Equipment is to be as per Eirgrid and ESB Specifications.
- The Elevation of the Compound will be depicted by localized Topography such that Cut/Fill Earthworks associated with the construction of the Compound are balanced. LEGEND: -

Levels shown thus

Concrete Footpath shown thus

ISSUE/REVISION

P5	12.12.23	Issued for Planning
P4	06.11.23	Issued for Planning
P3	24.05.23	Issued for Planning
P2	12.01.23	Issued for Planning
P1	06.12.22	Issued for Information
I/R	DATE	DESCRIPTION

PROJECT NUMBER

05-923

SHEET TITLE

IPP Building - Plan & Elevations & Section

SHEET NUMBER




- I. ALL DRAWINGS TO BE READ IN CONJUNCTION WITH THE SPECIFICATION AND ALL ENGINEERS AND ARCHITECTS DRAWINGS
- 2. ALL CONCRETE TO BE IN ACCORDANCE WITH I.S. EN 206-1:2002 WITH THE MIX DESIGNS SHOWN IN TABLE I
- 3. CONCRETE FINISHES TO BE IN ACCORDANCE WITH TABLE 6.1 OF THE ESBI SPECIFICATION CS17-SO1-005.
- 4. ALL REINFORCEMENT SHALL BE IN ACCORDANCE WITH BS4449 AND SCHEDULED IN ACCORDANCE WITH BS.8666. 300MM LAPS FOR A142 MESH 600MM MIN LAPS FOR A393 MESH.
- 5. REFER ALWAYS TO RELEVANT EARTH GRID DRAWING PRIOR TO EXCAVATIONS & CONCRETE POURS
- 6. GEOMETRICAL TOLERANCES TO BE IN ACCORDANCE WITH TABLE 6.2 OF ESBI SPECIFICATION CS17-S01-005

FOUNDATION NOTES:

7. GROUND TO HAVE A MINIMUM BEARING CAPACITY OF 100 kN/M².

- 8. FORMATION LEVEL AND FOUNDATIONS TO BE INSPECTED AND APPROVED BY THE ENGINEER PRIOR TO ANY CONCRETE BEING POURED.
- 9. ALL FOUNDATIONS ARE TO BE BLINDED IMMEDIATELY AFTER EXCAVATION WITH 50MM OF C16/20 CONCRETE BLINDING.

10. REFER ALWAYS TO THE RELEVANT EARTH WORK DRAWINGS PRIOR TO EXCAVATIONS & CONCRETE POURS.

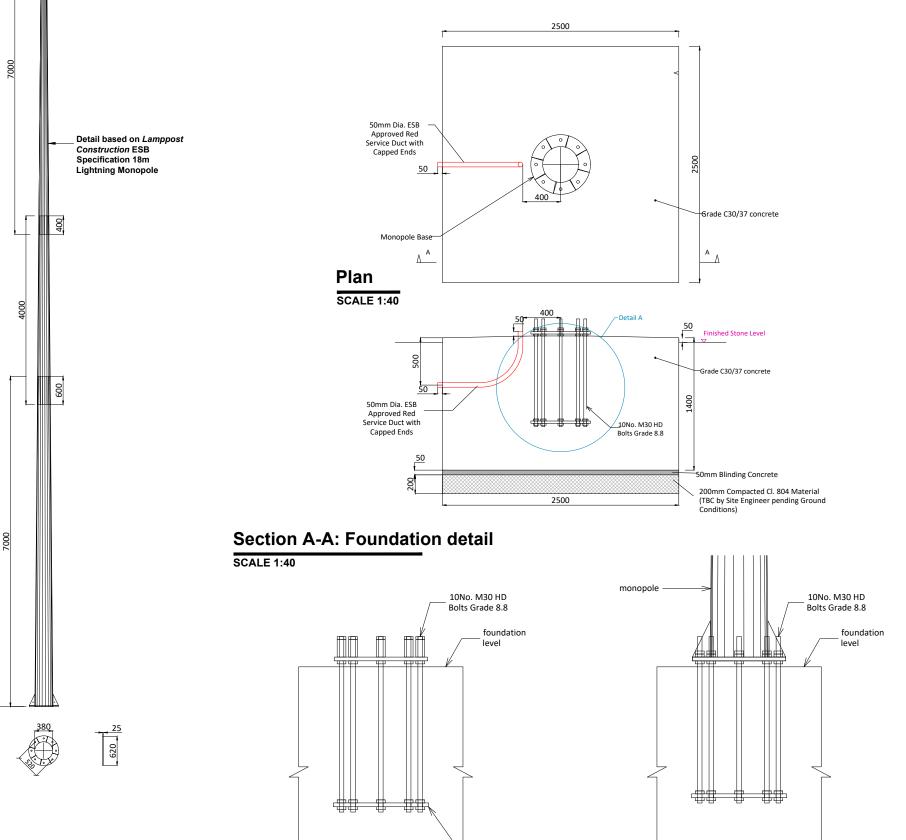

100

Monopole Details

SCALE 1:75

18000 MAX

17000

template

Bottom

Monopole Base Plate to HDB Connection Scale : 1:25

Head Office Beenreigh, Abbeydorney, Tralee, Co. Kerry Ireland Tel: 00353 66 7135710

BALLYCAR Green Energy

ISSUE/REVISION

P4	12.12.23	Issued for Planning
P3	06.11.23	Issued for Planning
P2	12.01.23	Issued for Planning
P1	14.10.22	Issued for Information
I/R	DATE	DESCRIPTION

PROJECT Ballycar Wind Farm 110kV UGC Grid Connection SHEET TITLE Lightning Monopole Foundation Details 18m Masts

DRAWING STATUS For Information PROJECT NUMBER 05-923

SHEET NUMBER

05923-DR-134

LEGEND/NOTES: -


- This drawing is to be read in conjuction with relevant drawings, specifications and reports
- Dimensions are in millimetres, unless noted otherwise
- Drawings are not to be scaled use figured dimensions only

iipiate




Detail A

ISO A2 420mm x 594

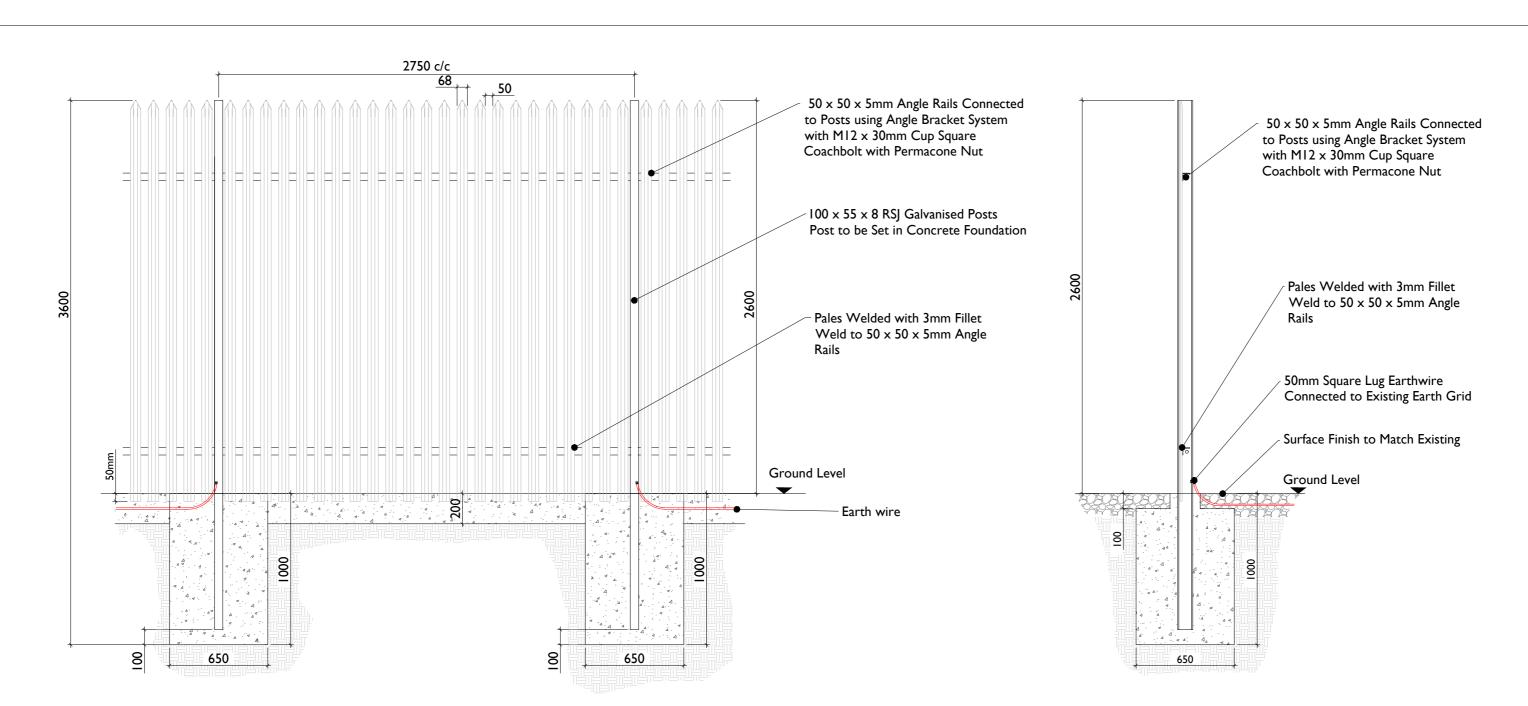

Palisade Fencing Details - Elevation SCALE 1:25

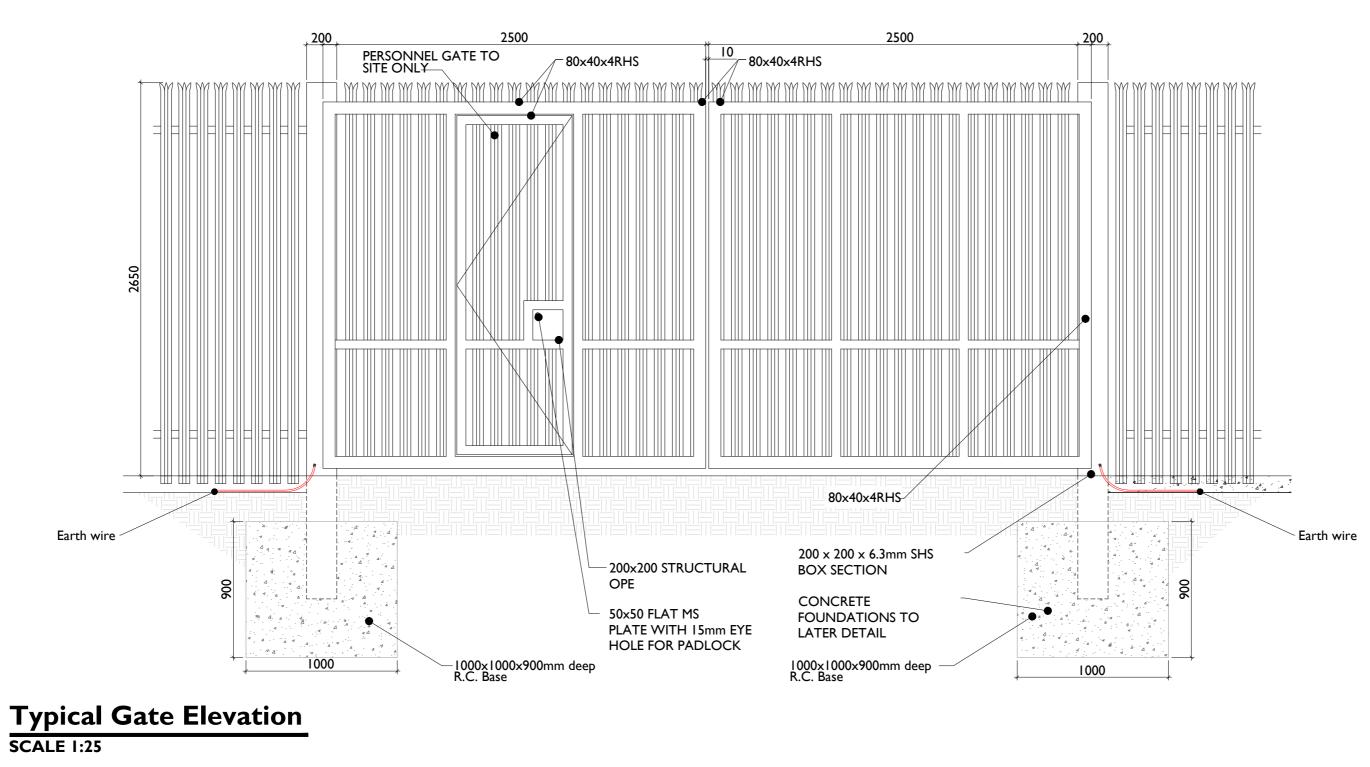

Project Management Initials: Designer: JC Checked: POS Approved: DB

Palisade Fencing Details - Section SCALE 1:25



Ballycar Wind Farm 110kV UGC Grid Connection

CLIENT



CONSULTANTS

NOTES: -

LEGEND: -

- This drawing is to be read in conjuction with relevant drawings, specifications and reports
- Dimensions are in millimetres, unless noted otherwise
- Drawings are not to be scaled use figured dimensions only

ISSUE/REVISION

P4	12.12.23	Issued for Planning	
P3	06.11.23	Issued for Planning	
P2	12.01.23	Issued for Planning	
P1	14.10.22	Issued for Information	
I/R	DATE	DESCRIPTION	
PR	PROIECT NUMBER		

PROJECT NUMBER


05-923

SHEET TITLE

Gate & Fence Details

SHEET NUMBER



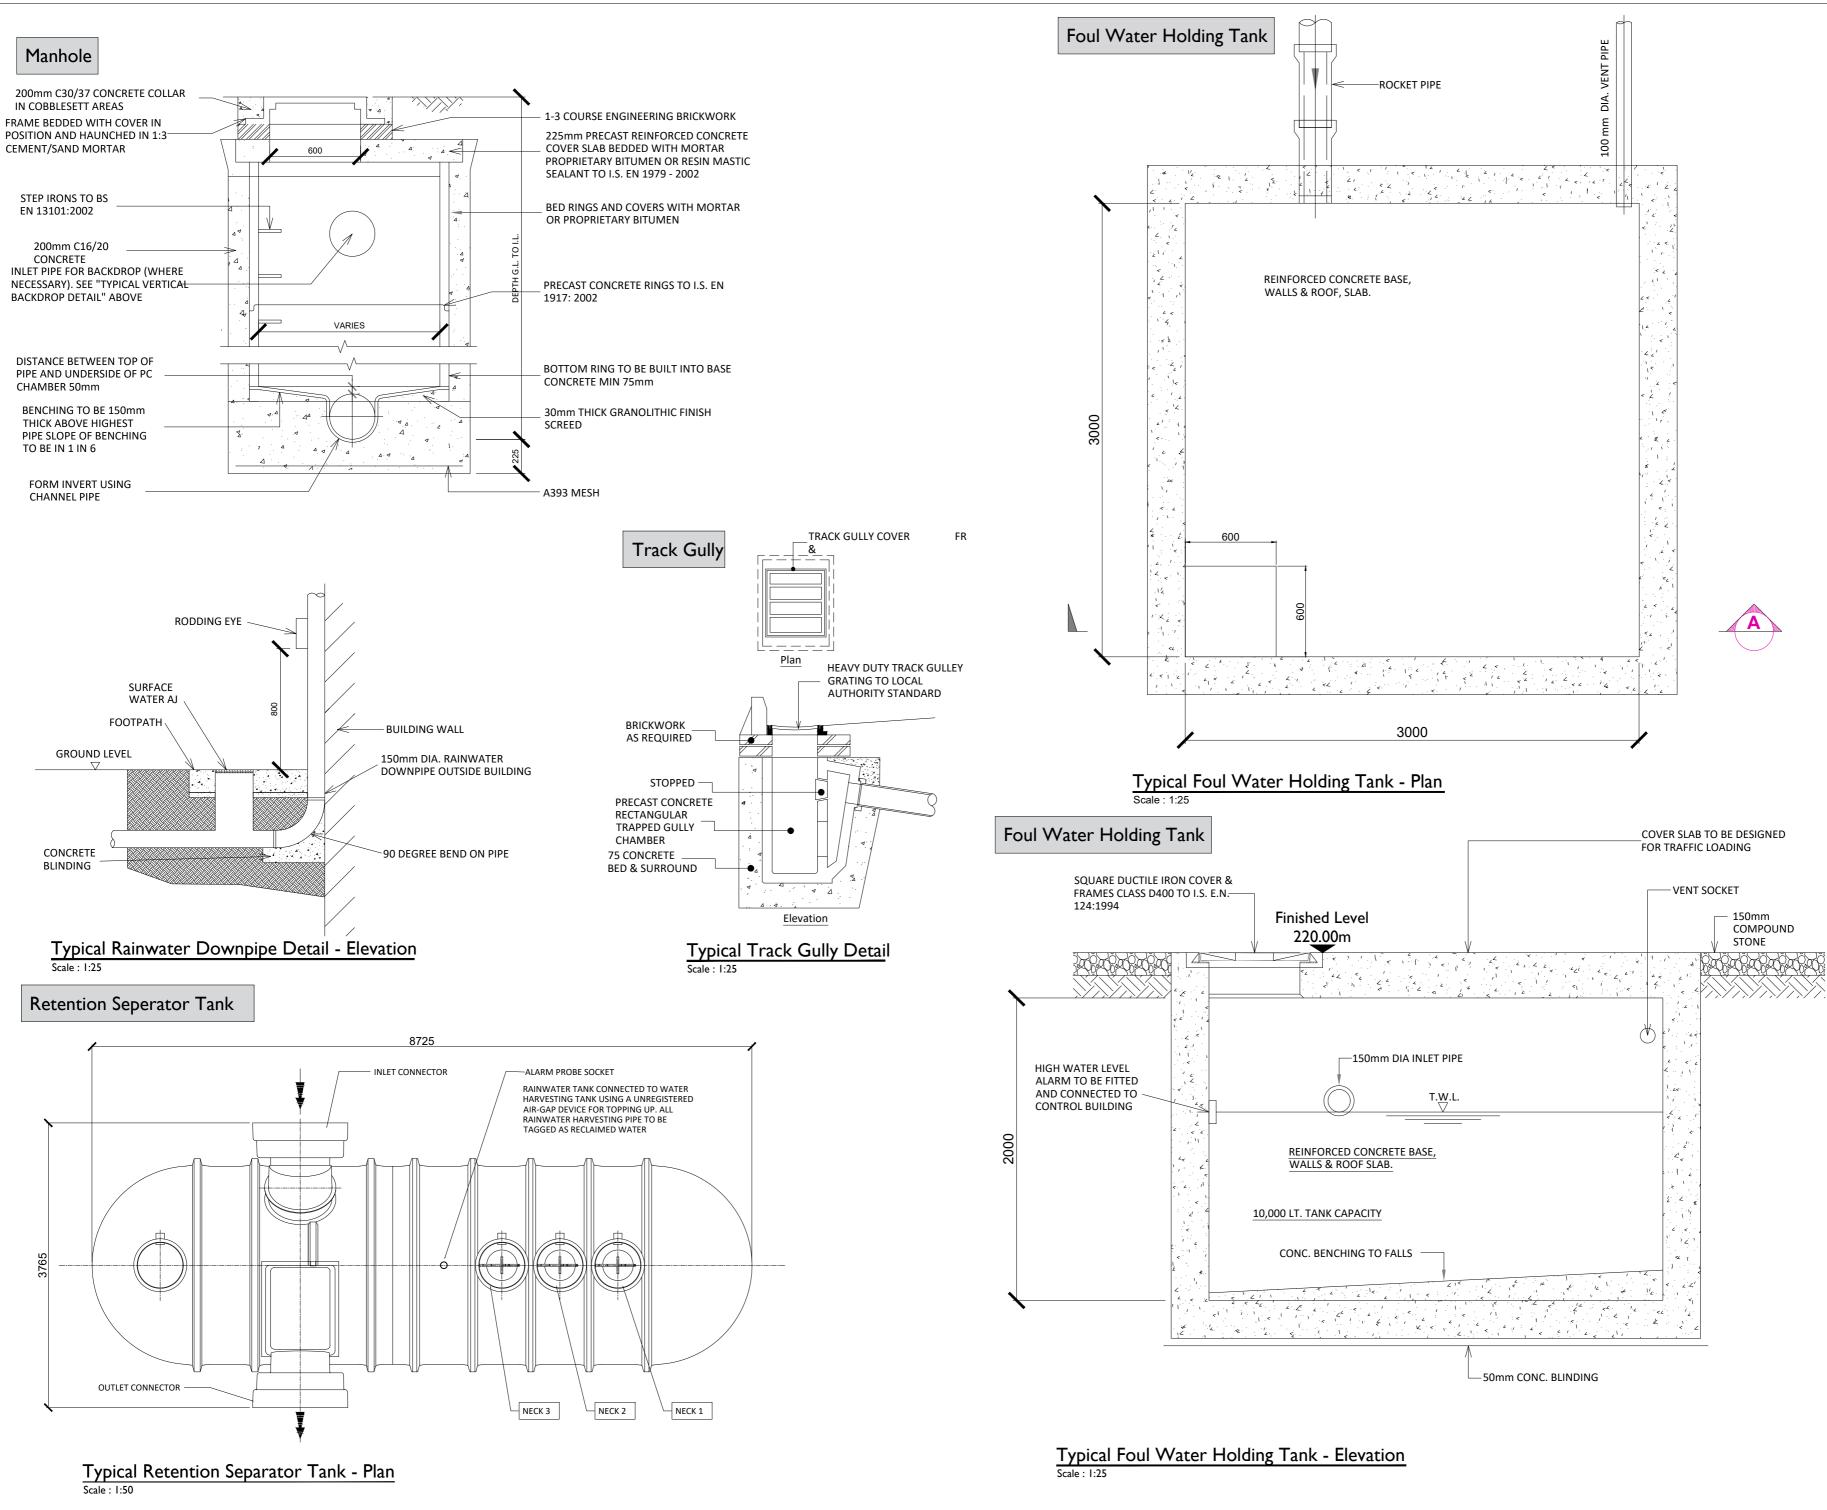



Ballycar Wind Farm 110kV UGC Grid Connection

CLIENT



CONSULTANTS

NOTES: -

- This drawing is to be read in conjunction with relevant engineering drawings, specifications and reports
- Dimensions are in millimeters, unless noted otherwise
- Drawings are not to be scaled use figured dimensions only

LEGEND: -


P5	12.01.24	Issued for Planning
P4	12.12.23	Issued for Planning
P3	06.11.23	Issued for Planning
P2	12.01.23	Issued for Planning
ΡI	14.10.22	Issued for Planning
I/R	DATE	DESCRIPTION

PROJECT NUMBER

05-923

SHEET TITLE

Substation Compound drainage, Rentention seperator tank, Foul water holding tank details SHEET NUMBER

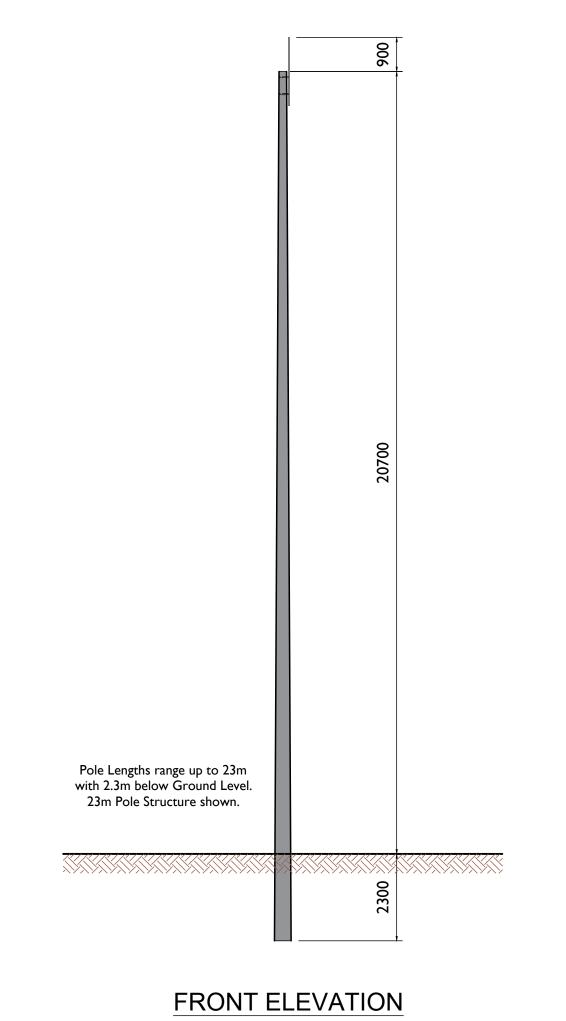

Scale 1:100



Head Office Beenreigh, Abbeydorney, Tralee, Co. Kerry Ireland Tel: 00353 66 7135710

ISSUE/REVISION

P4	12.12.23	Issued for Planning
P3	06.11.23	Issued for Planning
P2	12.01.23	Issued for Planning
P1	14.10.22	Issued for Information
I/R	DATE	DESCRIPTION

PROJECT Ballycar Wind Farm 110kV UGC Grid Connection

CLIENT

SHEET TITLE Telecoms Pole Elevation View


DRAWING STATUS For Planning PROJECT NUMBER 05-923 SHEET NUMBER

05923-DR-137

LEGEND/NOTES: -

All dimensions in mm unless noted otherwise

594 ISO A1

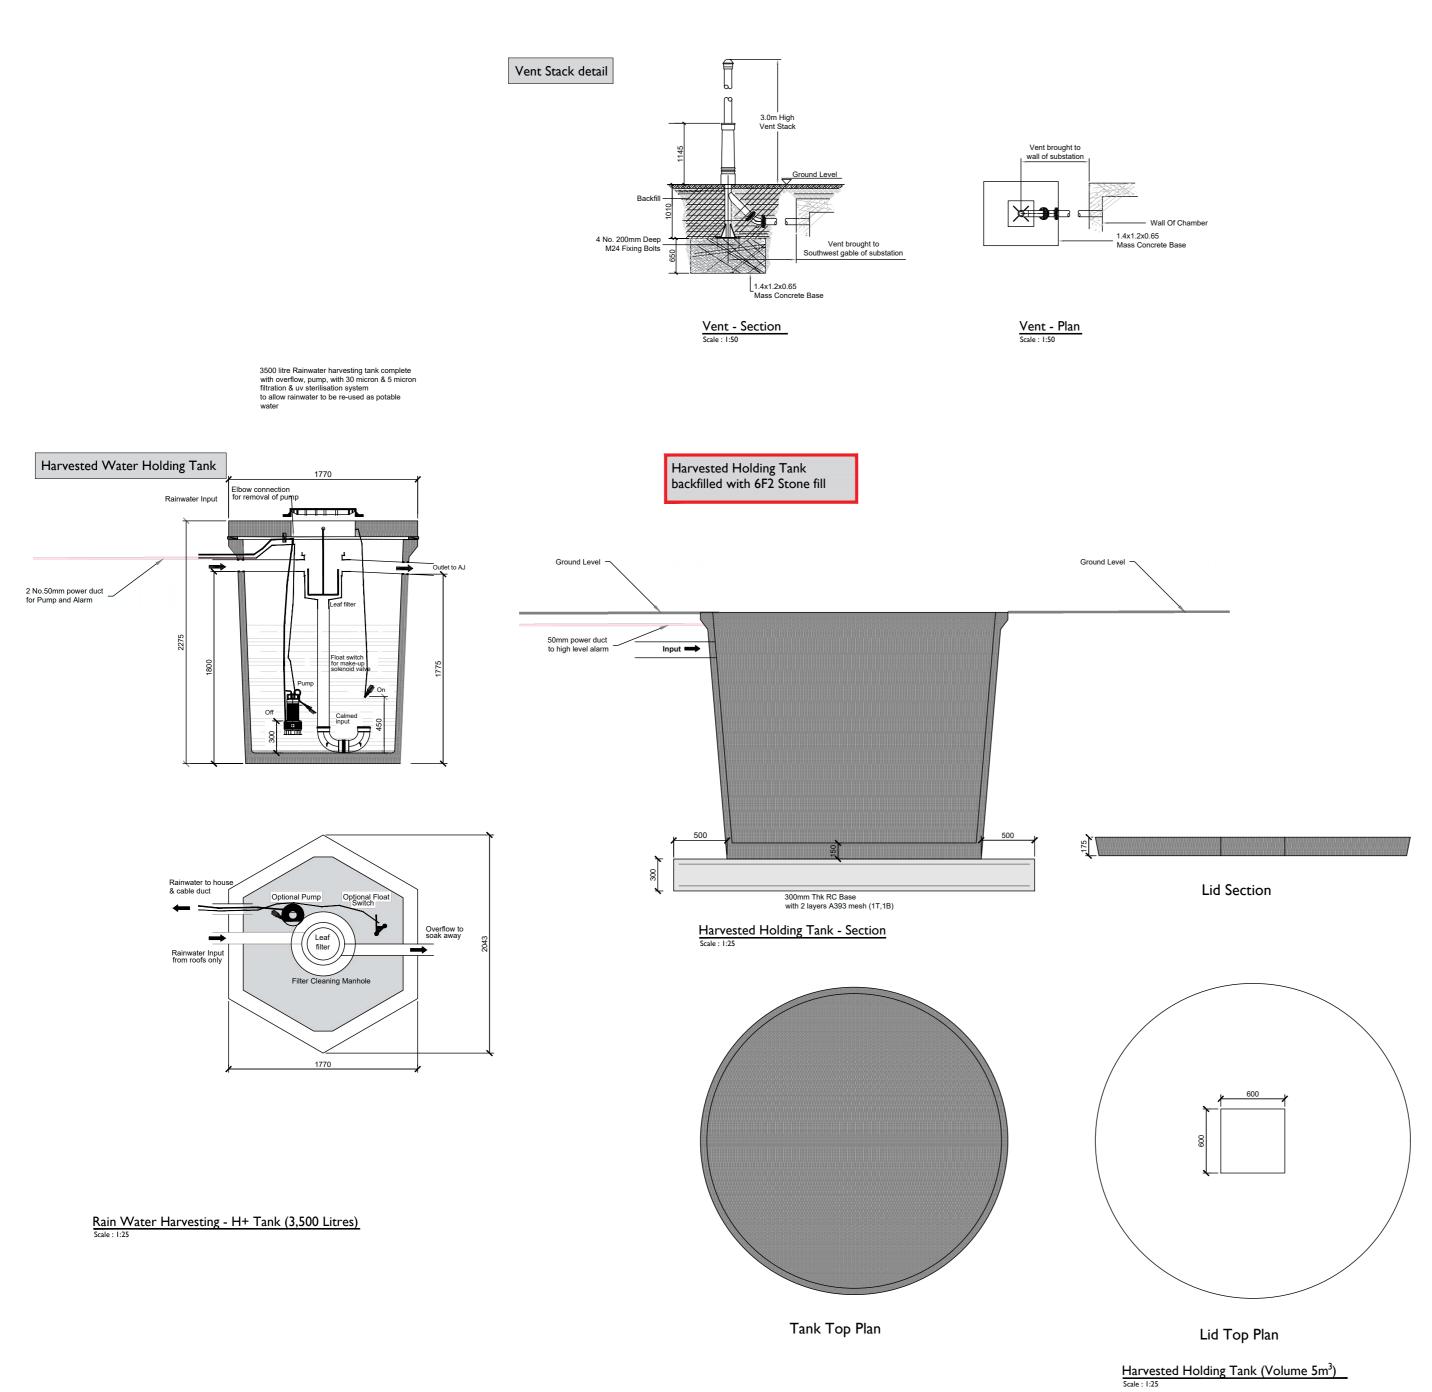



Head Office Beenreigh, Abbeydorney, Tralee, Co. Kerry Ireland Tel: 00353 66 7135710

PROJECT

Regional Office Basepoint Business Centre Stroudley Road, Basingstoke, Hampshire, RG24 8UP, UK Tel: 00 44 1256406664

Ballycar Wind Farm 110kV Grid Connection

CLIENT



CONSULTANTS

NOTES: -

- This drawing is to be read in conjuction with relevant drawings, specifications and reports
 Dimensions are in millimetres, unless noted
- otherwise • Drawings are not to be scaled use figured dimensions only

LEGEND: -

ISSUE/REVISION

_		I
P4	12.12.23	Issued for Planning
P3	06.11.23	Issued for Planning
P2	12.01.23	Issued for Planning
P1	14.10.22	Issued for Information
I/R	DATE	DESCRIPTION


PROJECT NUMBER


05-923

SHEET TITLE

Rain Water Harvesting Tank & Vent details

SHEET NUMBER

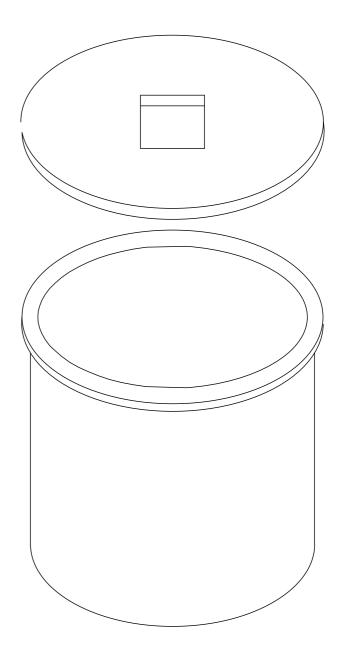

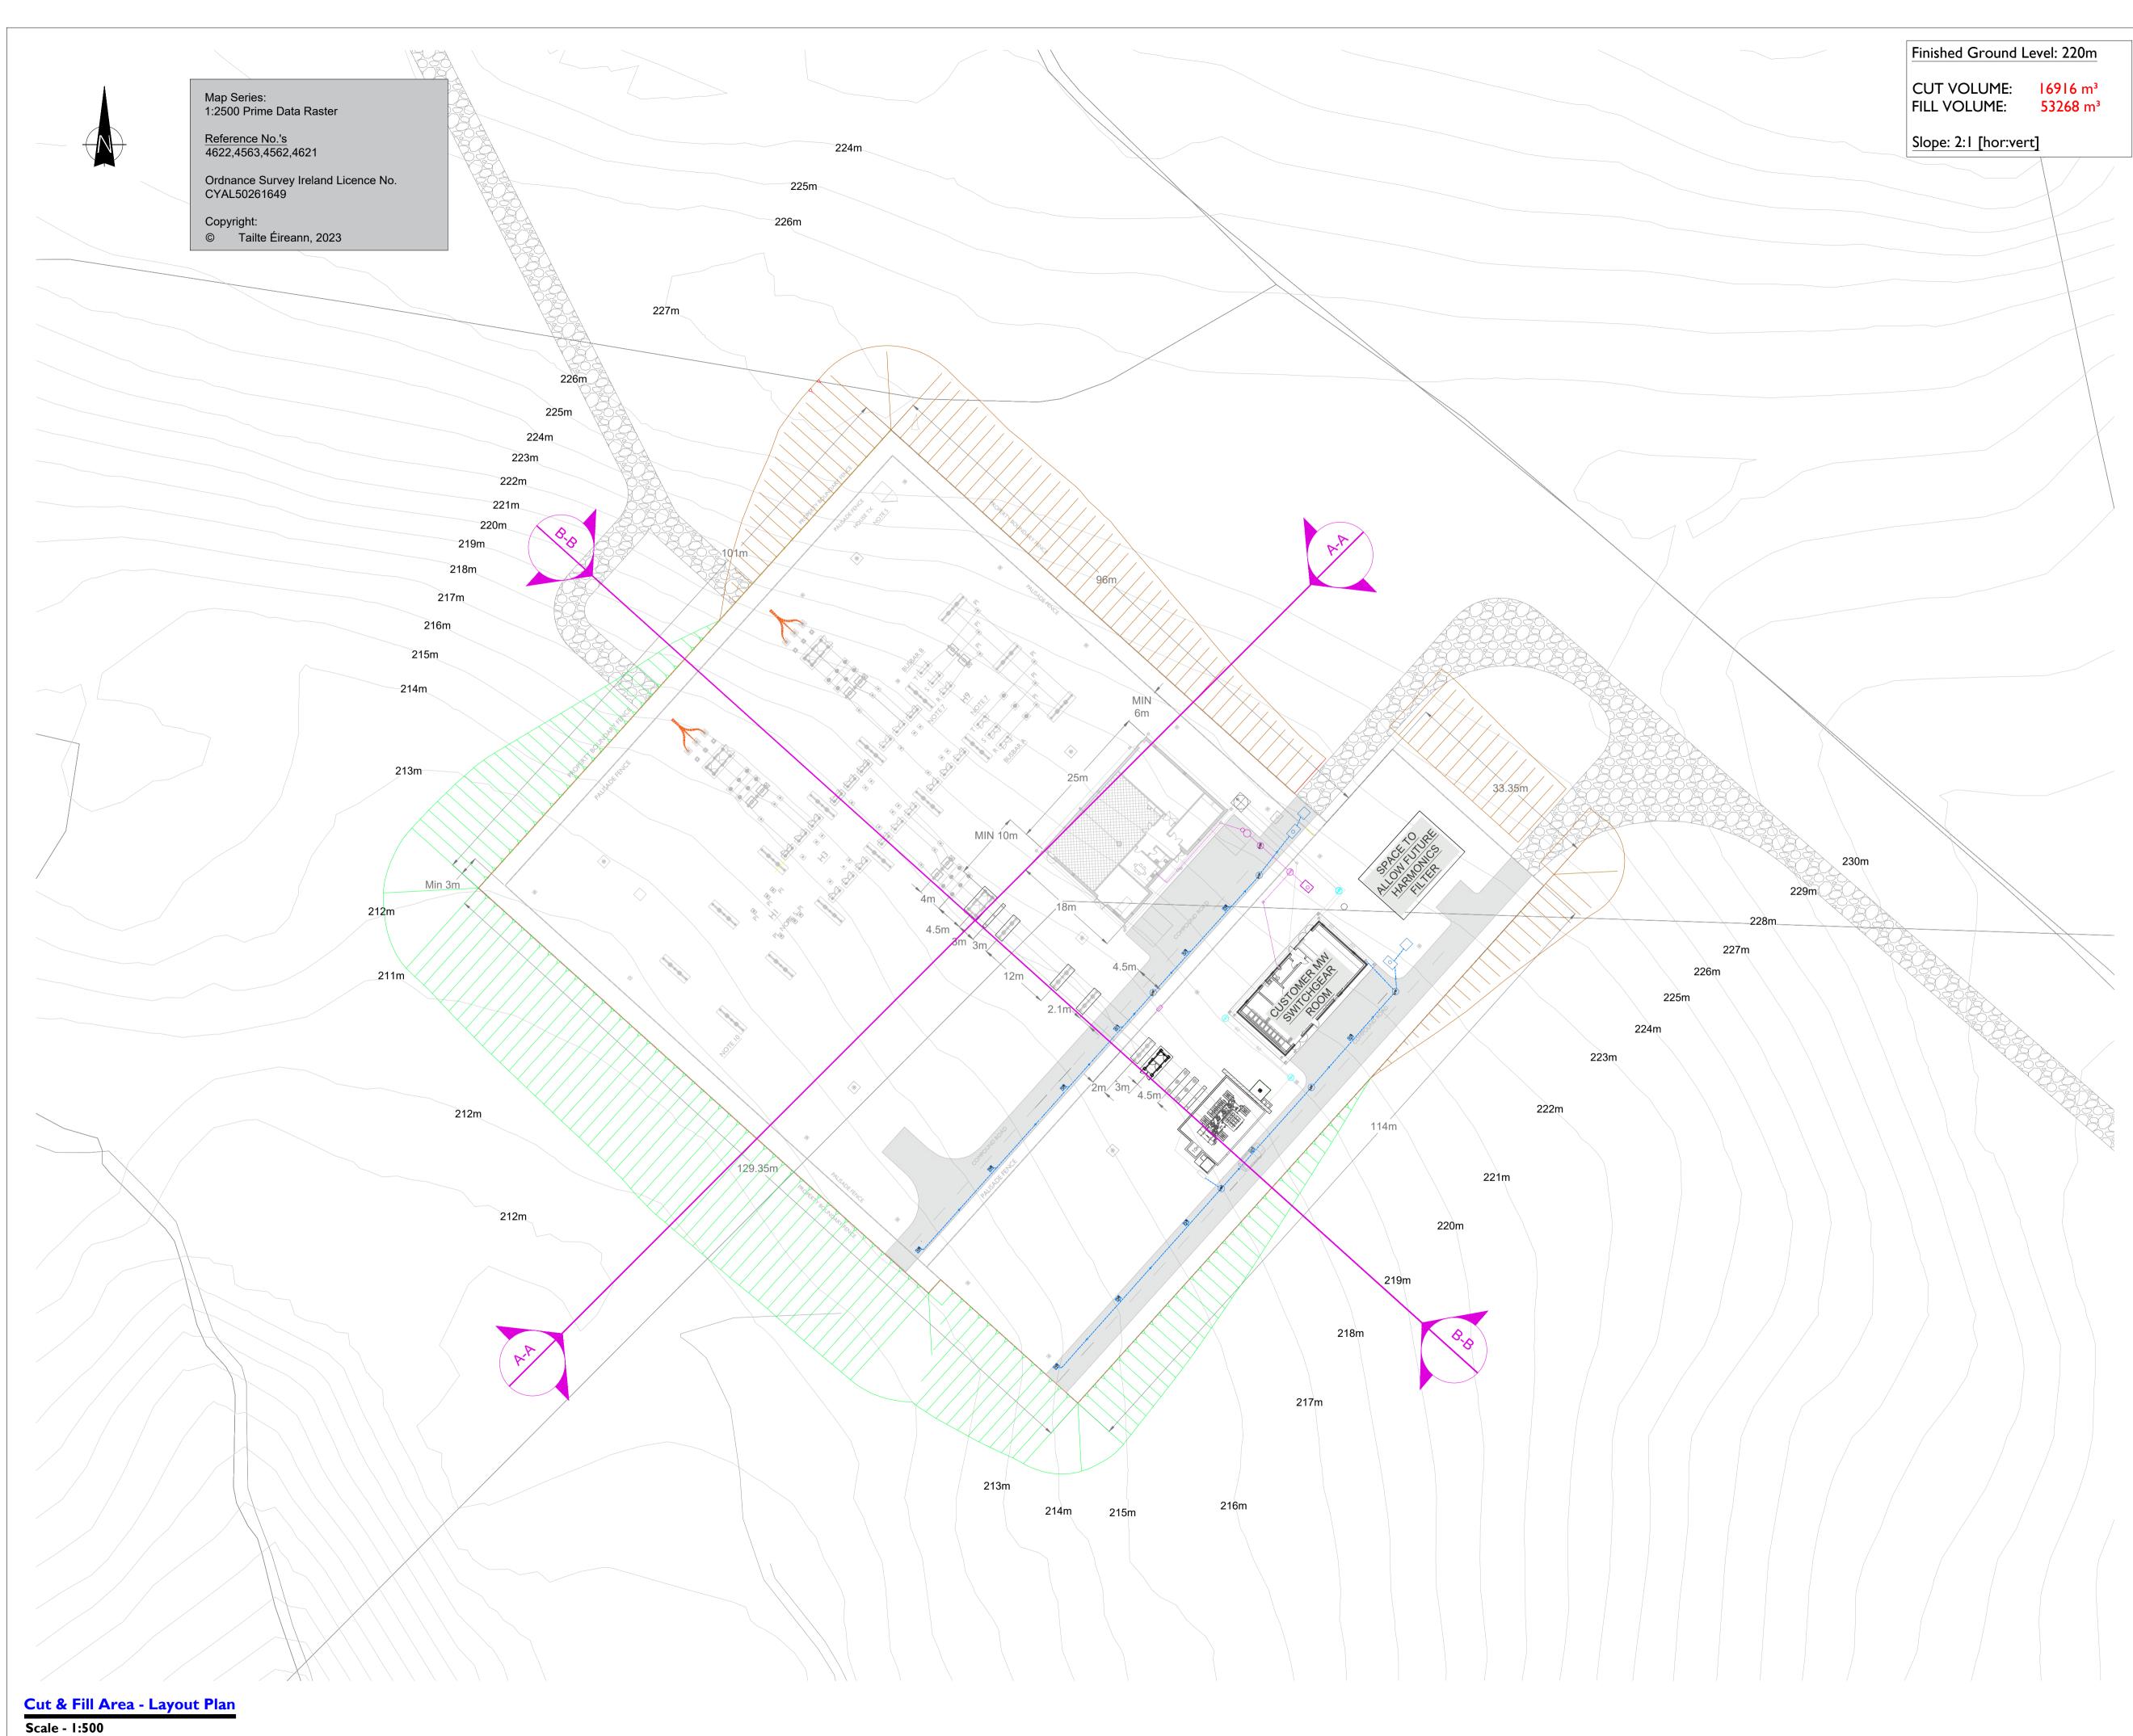



Head Office Beenreigh, Abbeydorney, Tralee, Co. Kerry Ireland Tel: 00353 66 7135710

Regional Office Basepoint Business Centre Stroudley Road, Basingstoke, Hampshire, RG24 8UP, UK Tel: 00 44 1256406664

PROJECT

Ballycar Wind Farm 110kV UGC Grid Connection

APPLICANT




CONSULTANTS

NOTES: -

- This drawing is to be read in conjuction with relevant drawings, specifications and reports
 Dimensions are in millimetres, unless noted otherwise
 Drawings are not to be scaled use figured dimensions only

LEGEND: -

Cut Volume Fill Volume Access track

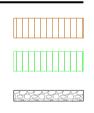

ISSUE/REVISION

P6	12.01.24	Issued for Planning
P5	12.12.23	Issued for Planning
P4	05.12.23	Issued for Planning
P3	06.11.23	Issued for Planning
P2	12.01.23	Issued for Planning
P1	06.12.22	Issued for Information
I/R	DATE	DESCRIPTION

PROJECT NUMBER


05-923


SHEET TITLE

Cut & Fill Area Layout Plan

SHEET NUMBER

A SO

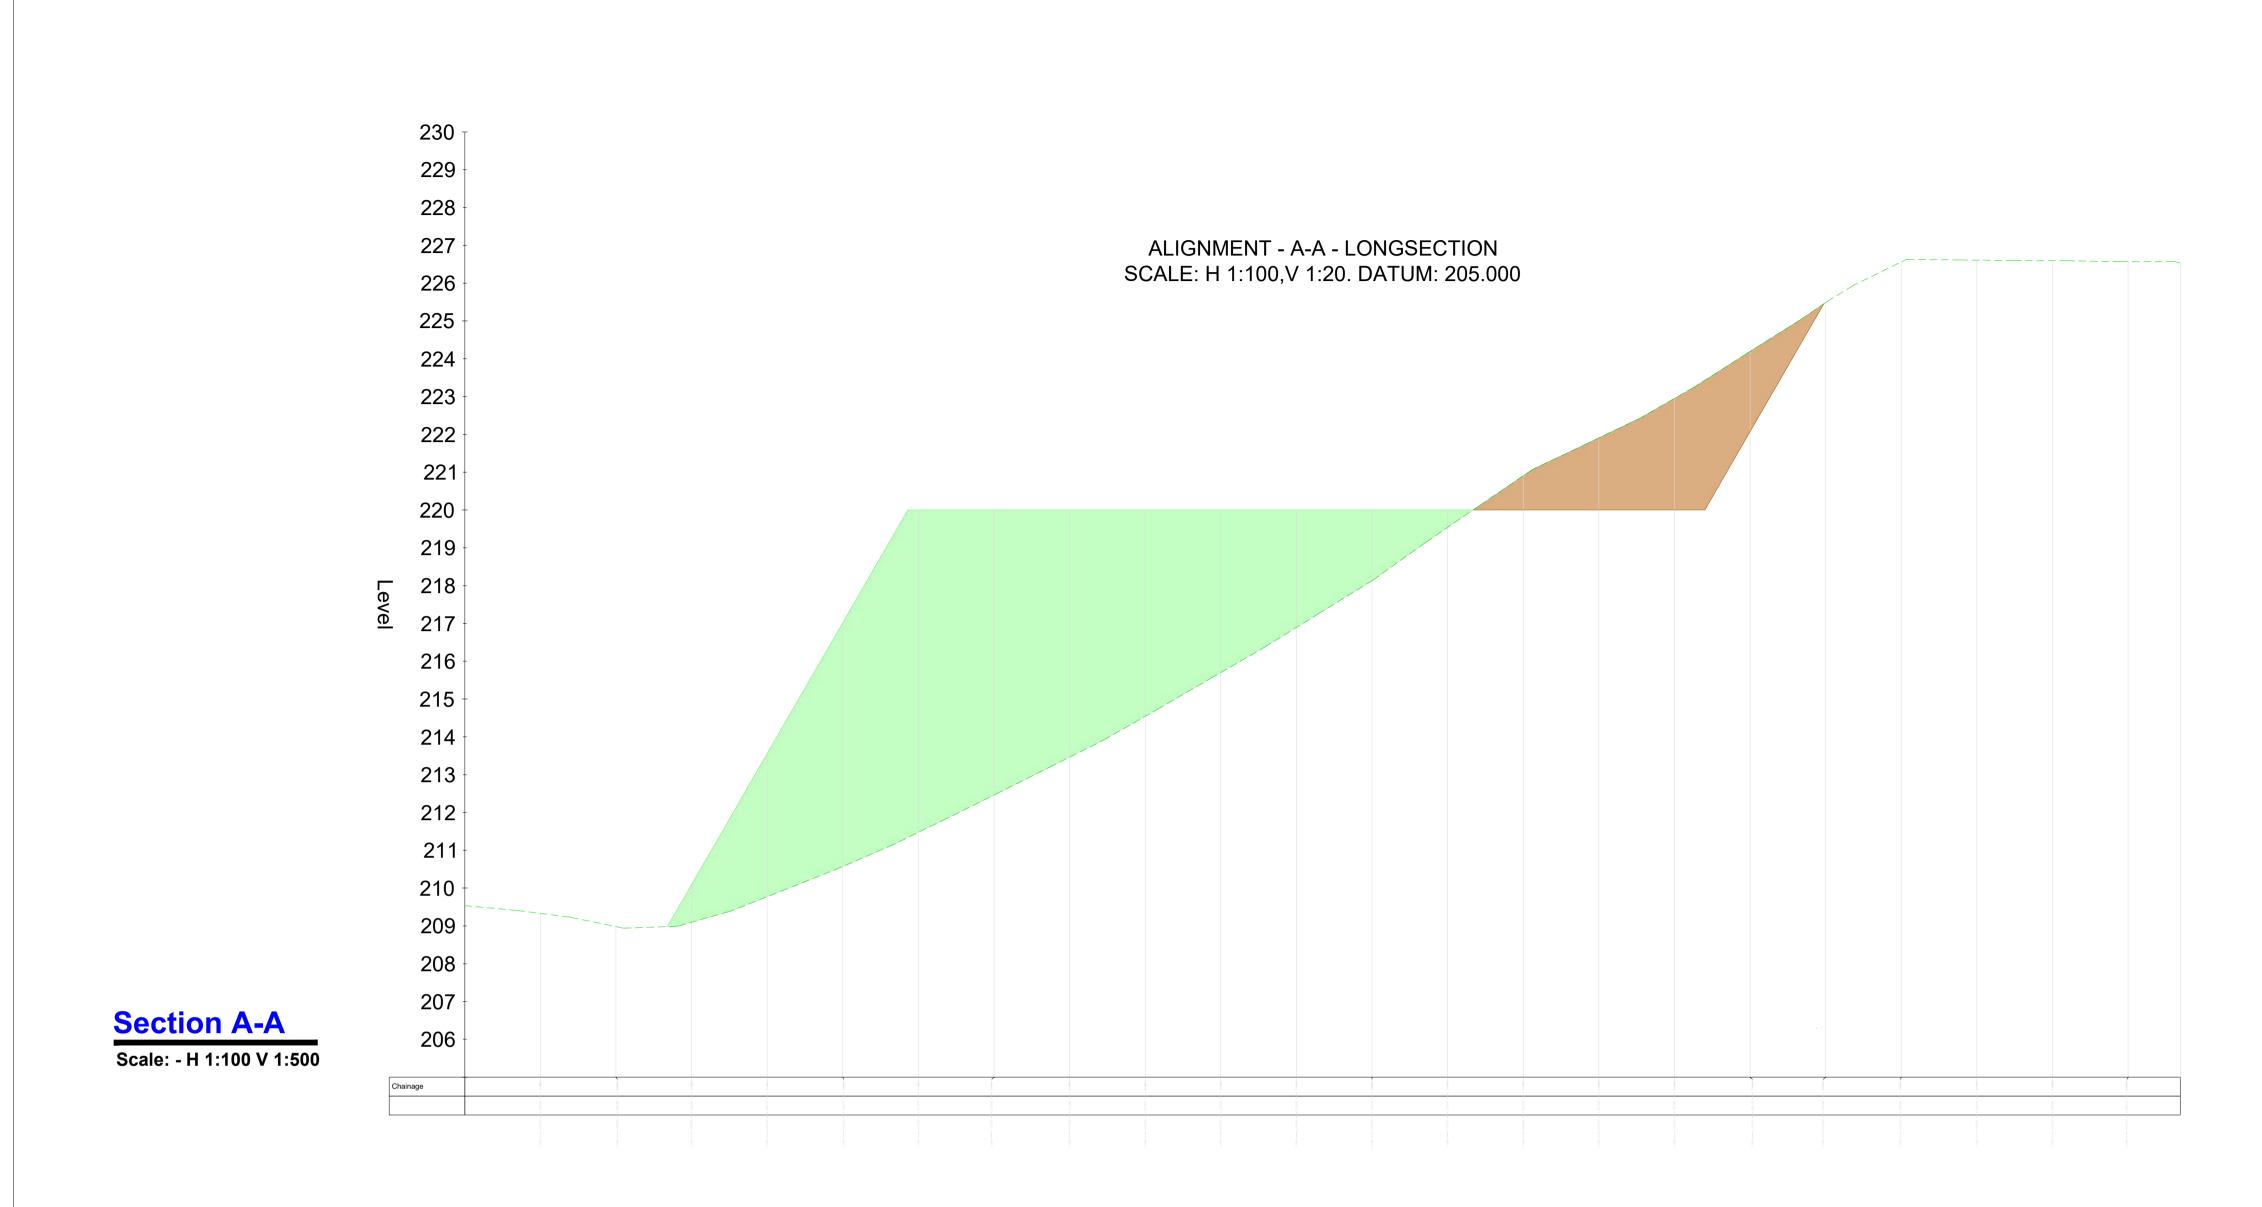

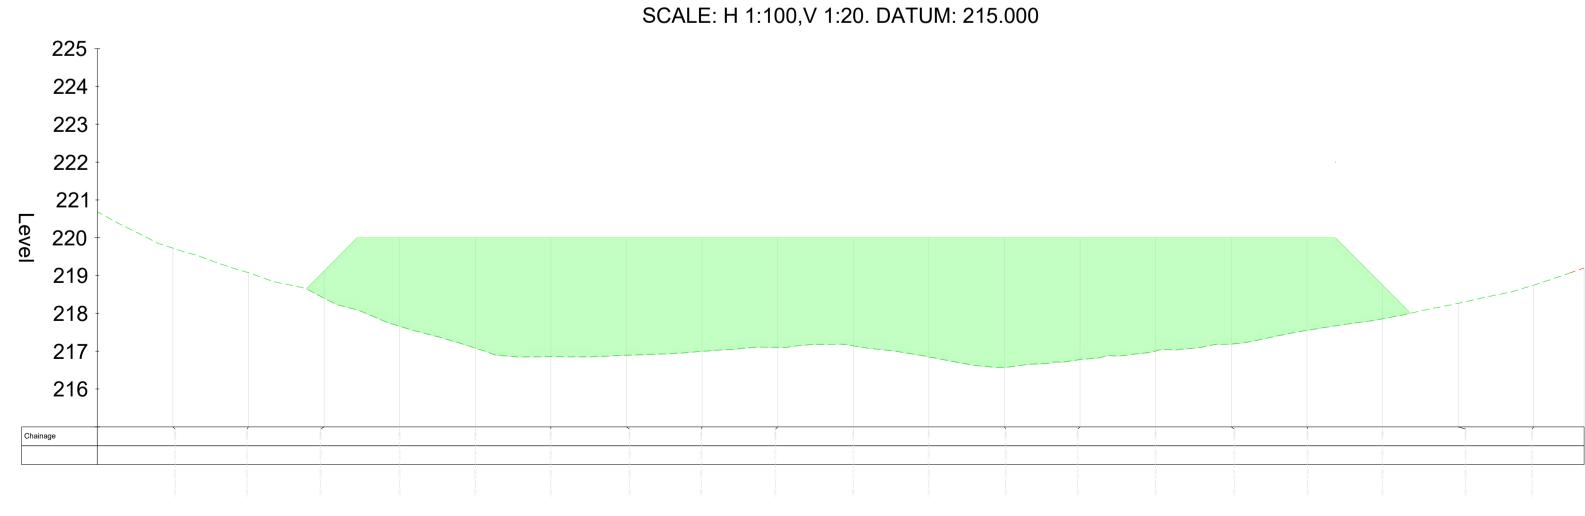



ALIGNMENT - B-B - LONGSECTION

Finished Ground Level: 220m

 CUT VOLUME:
 16916 m³

 FILL VOLUME:
 53268 m³

Slope: 2:1 [hor:vert]



Head Office Beenreigh, Abbeydorney, Tralee, Co. Kerry Ireland Tel: 00353 66 7135710

Regional Office Basepoint Business Centre Stroudley Road, Basingstoke, Hampshire, RG24 8UP, UK Tel: 00 44 1256406664

PROJECT

Ballycar Wind Farm 110kV UGC Grid Connection

APPLICANT



CONSULTANTS

NOTES: -

- This drawing is to be read in conjuction with relevant drawings, specifications and reports
- Dimensions are in millimetres, unless noted otherwise • Drawings are not to be scaled use figured dimensions only

LEGEND: -

Cut Volume Fill Volume

ISSUE/REVISION

P5	12.01.24	Issued for Planning
P4	12.12.23	Issued for Planning
P3	06.11.23	Issued for Planning
P2	12.01.23	Issued for Planning
P1	14.10.22	Issued for Information
I/R	DATE	DESCRIPTION

PROJECT NUMBER


05-923

SHEET TITLE

Substation Site Sections

SHEET NUMBER



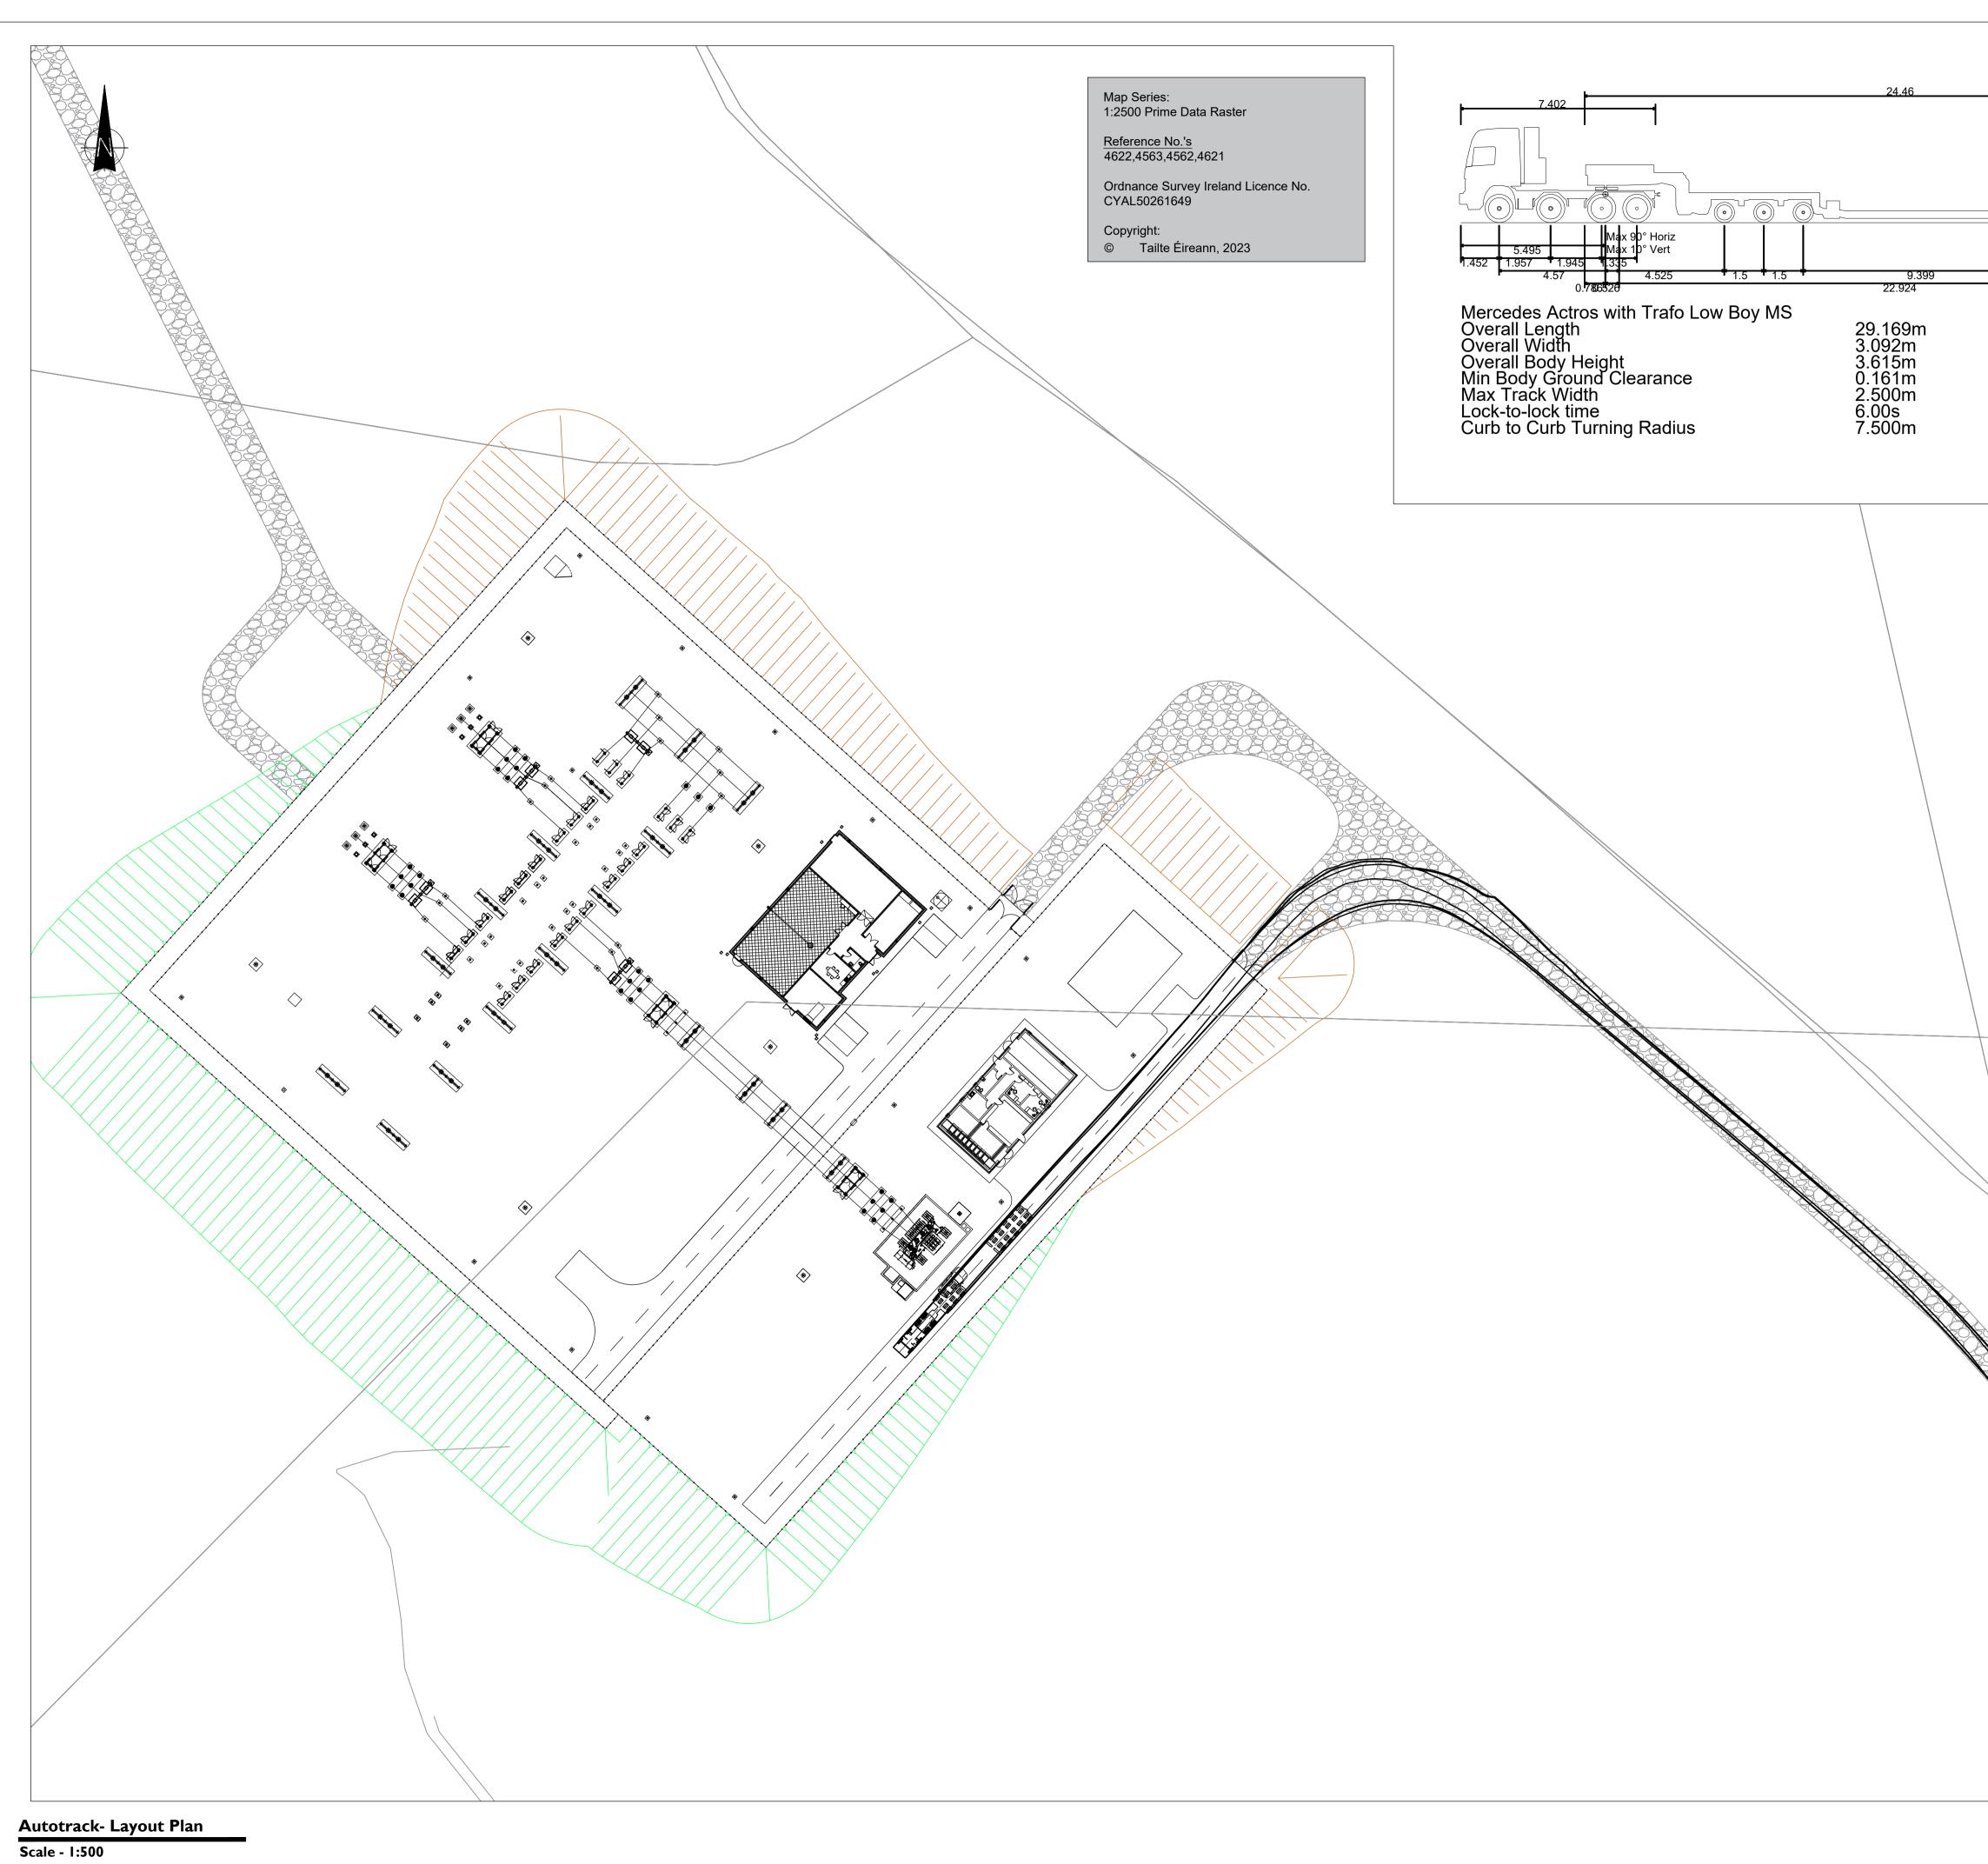

•) ($\overline{)}$		
	1			Ī
1.5	1.5	1.5	1.5	0.75
				-



Head Office Beenreigh, Abbeydorney, Tralee, Co. Kerry Ireland Tel: 00353 66 7135710

Regional Office Basepoint Business Centre Stroudley Road, Basingstoke, Hampshire, RG24 8UP, UK Tel: 00 44 1256406664

PROJECT

Ballycar Wind Farm 110kV UGC Grid Connection

APPLICANT




CONSULTANTS

NOTES: -

- This drawing is to be read in conjuction with relevant drawings, specifications and reports
- Dimensions are in millimetres, unless noted otherwise • Drawings are not to be scaled use figured dimensions only

LEGEND: -

Cut Volume Fill Volume Access track

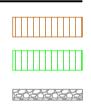

ISSUE/REVISION

P4	12.01.24	Issued for Information
Р3	12.12.23	Issued for Information
P2	05.12.23	Issued for Information
P1	06.11.23	Issued for Information
I/R	DATE	DESCRIPTION


PROJECT NUMBER

05-923

SHEET TITLE

Autotrack Layout Plan

SHEET NUMBER

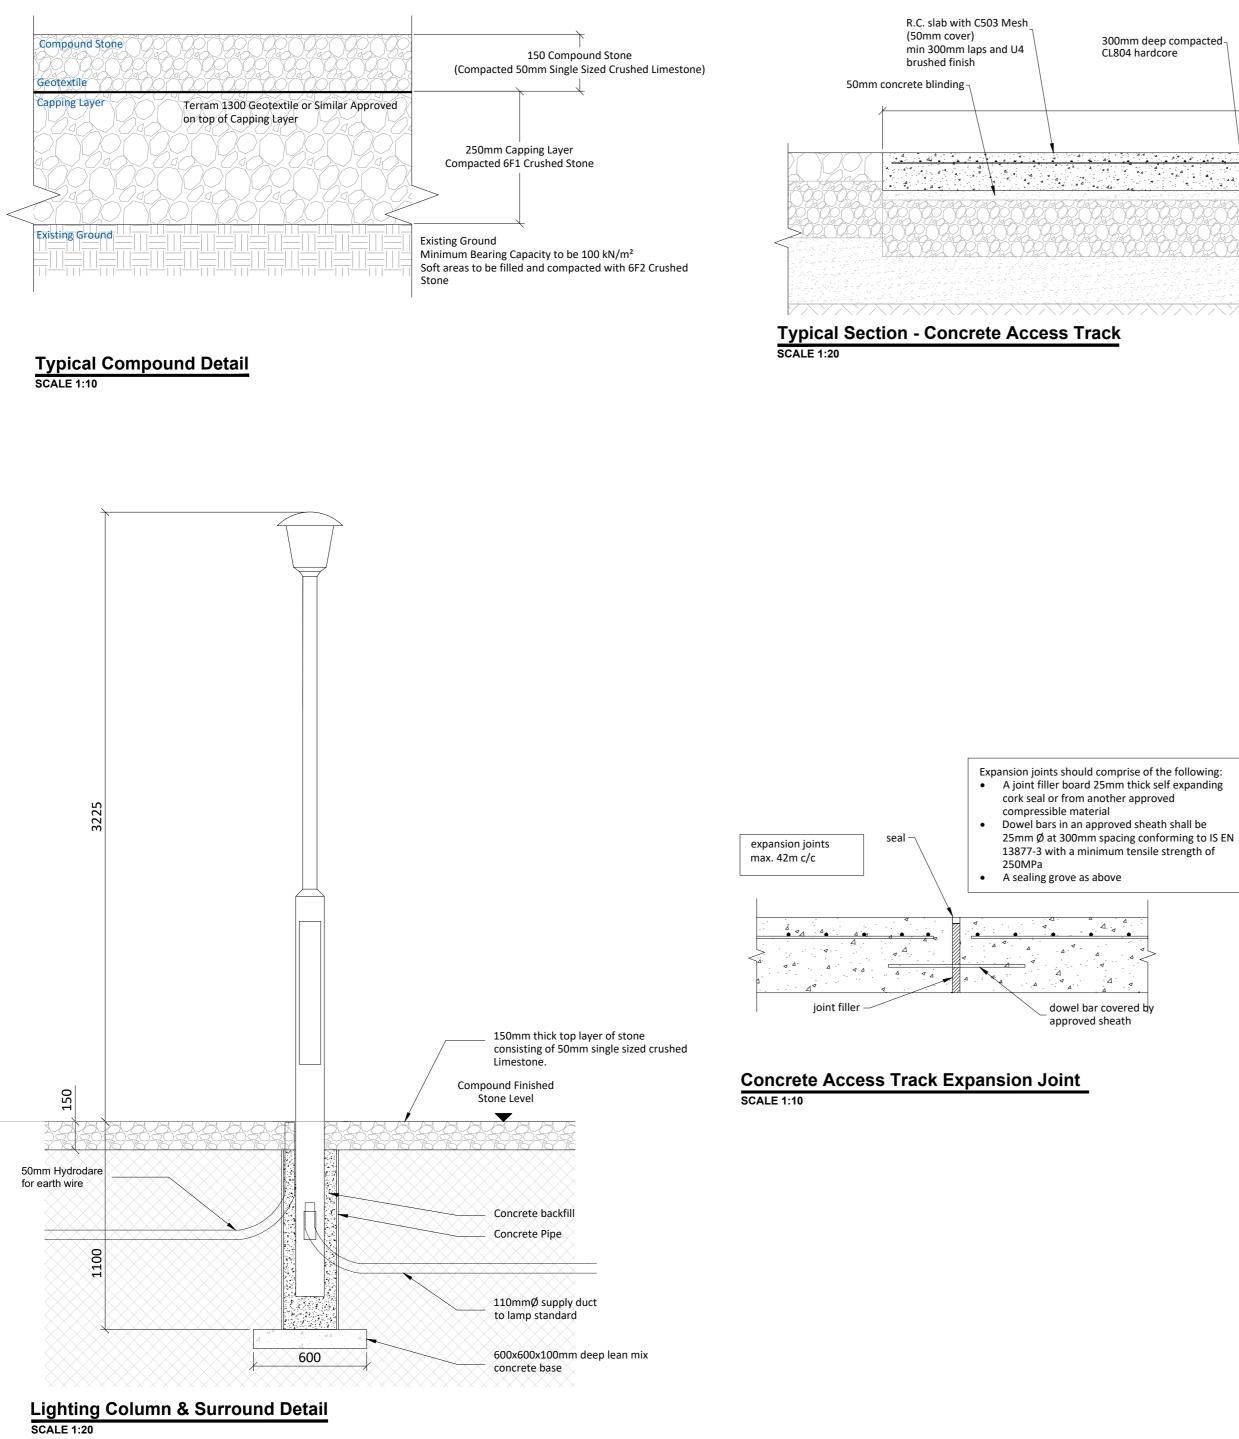

300mm deep compacted CL804 hardcore	4500 2.5% fall	Head OfficeBeenreigh, Abbeydorney, Tralee, Co. Kerry, Ireland Te: 00353 66 7135710PROJECT
<u>rack</u>		Ballycar Wind Farm 110kV UGC Grid Connection
		CONSULTANTS

Contraction joints should comprise of the following:

• A sawn groove joint 10mm wide at least $\frac{1}{4}$ the

Dowel bars shall be 20mm Ø at 300mm spacing conforming to IS EN 10060 and IS EN

13877-3 with a minimum tensile strength of

A sealing groove (seals shall be hot applied sealants Type N1 or Type F1 complying with IS

EN 14188-1 and applied in accordance with BS

slab depth

250 MPa

2499-2)



- This drawing is subject to detailed design and ESB design approval and should be used for planning purposes only.
 This drawing is to be read in conjunction with relevant drawings, specifications and reports.
- Dimensions are in millimeters, unless noted otherwise.
 Drawings are not to be scaled use figured dimensions only.

LEGEND: -

ISSUE/REVISION

P3	12.01.24	Issued for Planning
P2	12.12.23	Issued for Planning
P1	06.11.23	Issued for Planning
I/R	DATE	DESCRIPTION
PROJECT NUMBER		

PROJECT NUMBER

05-923

SHEET TITLE

Substation Compound Details

SHEET NUMBER

05923-DR-142



. ^Δ .:

50mm deep sawcut -

contraction joints max. 14m c/c

SCALE 1:10